

SITE LIGHTING PLAN

IF THESE DRAWINGS ARE SMALLER THAN 36" x 24" THEY HAVE BEEN REDUCED.

CONTRACTOR SHALL VERIFY ALL DIMENSIONS.

THESE DRAWINGS AND SPECIFICATIONS AS INSTRUMENTS OF SERVICE REMAIN THE PROPERTY OF DRP ENTERPRISES LLC AND SHALL NOT BE USED FOR ANY OTHER PURPOSE OTHER THAN THOSE FOR WHICH THEY HAVE BEEN SUPPLIED OR PREPARED.

THESE DRAWINGS SHALL NOT BE REPRODUCED, COPIED OR TRACED WITHOUT THE WRITTEN CONSENT OF DRP ENTERPRISES LLC

COPYRIGHT © 2022

No.	Revision / Issue	Drawn by	Checked by	Date





Project Owner

ROB BILLINGS
SUN MESA ROAD
YUCCA VALLEY, CA


Project

PROPOSED
MINI STORAGE
S.E. CORNER
NEWTON LANE AND SUN
MESA ROAD

SCALE

1/32" = 1'-0"

Project Number & Sheet Number

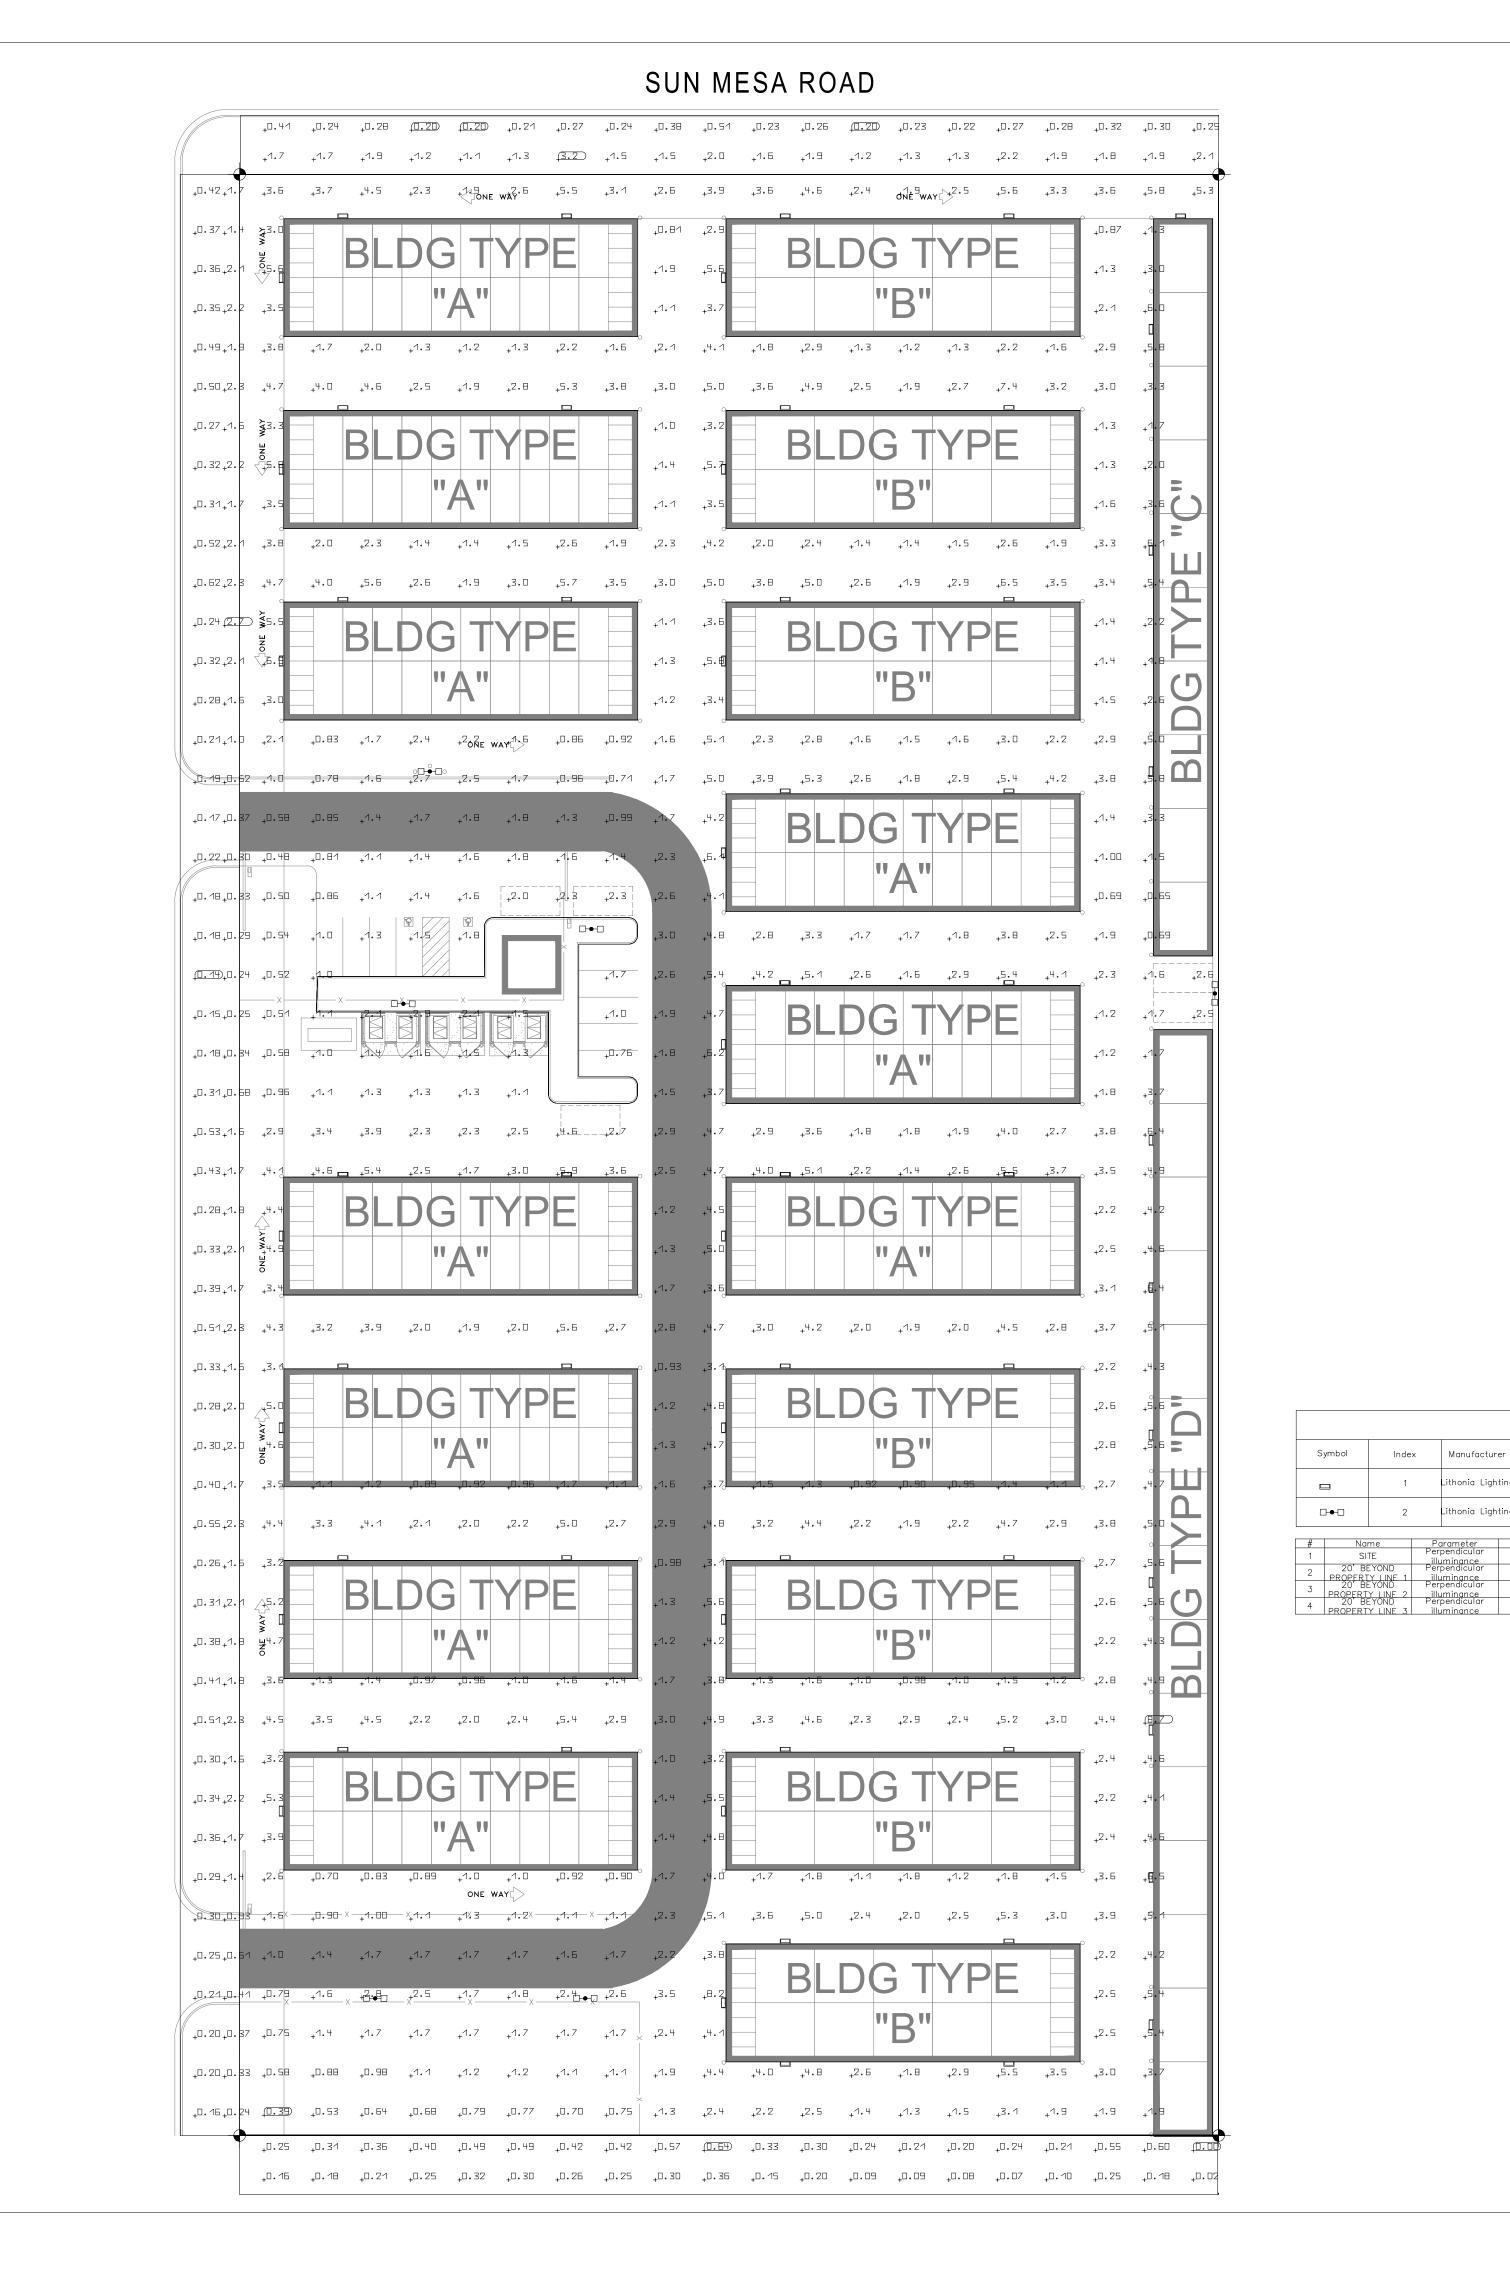

SITE **PHOTOMETRIC PLAN**

IF THESE DRAWINGS ARE SMALLER THAN 36" x 24" THEY HAVE BEEN REDUCED. CONTRACTOR SHALL VERIFY ALL DIMENSIONS. THESE DRAWINGS AND SPECIFICATIONS AS INSTRUMENTS OF SERVICE REMAIN THE PROPERTY OF DRP ENTERPRISES LLC AND SHALL NOT BE USED FOR ANY OTHER PURPOSE OTHER THAN THESE DRAWINGS SHALL NOT BE REPRODUCED, COPIED OR TRACED WITHOUT THE WRITTEN CONSENT OF DRP ENTERPRISES LLC COPYRIGHT © 2022

No.	Revision / Issue	Drawn by	Checked by	Date





Project Owner

Luminaire list (Site 1)

1x LED

6.19

4.97

198.7

2.70 fc

0.89 fc

0.99 fc

0.28 fc

Article name

Lithonia Lighting DSX1 LED P1 40K T4M DSX1 LED P1 40K T4M MVOLT

0.39 fc

0.20 fc

0.001 fc

DSXW1 LED WITH (2) 10 LED DSXW1 LED 200 Lithonia Lighting LIGHT ENGINES, TYPE T2M 1000 40K T2M 1x LED OPTIC, 4000K, @ 1000mA. MVOLT

8.66 fc

3.19 fc

0.64 fc

Index

Item number | Fitting | Luminous flux | Light loss factor | Connected load | Quantity

0.80 73.2 W

0.80

18.69

15.99

460.7

ROB BILLINGS SUN MESA ROAD YUCCA VALLEY, CA


PROPOSED MINI STORAGE S.E. CORNER NEWTON LANE AND SUN MESA ROAD


SCALE


1/32" = 1'-0"

Project Number & Sheet Number

						240/120V, 1Φ,	4W							
					CAE	BLE CALCUL	ATION							
	то	Total Connected			Cable Ampacities Table 310.15(B)(16) amper "AT"	CONDUCTOR/ - PHASE			Ground Cable	Conduit for				
FROM		Total Connected Load (VA) CABLE SIZE	CABLE SIZE	Main Breaker Size			CM(Circular mils) Chapter 9, Table 8	CABEL LENGTH D	Ampacity (240V,1Ph) I	ohms-cmil/ft K	VD	FEEDER V. DROP (%)	(NEC- 250.122)(Insulate d Copper)	feeders (Table C1)
	LIGHTING CIRCUIT-1	400	10 AWG	20	35	1	10380	500	2	12.9	1.04	0.43	AWG#12	1"
	LIGHTING CIRCUIT-3	510	10 AWG	20	35	1	10380	600	2	12.9	1.58	0.66	AWG#12	1"
	LIGHTING CIRCUIT-5	510	10 AWG	20	35	1	10380	600	2	12.9	1.58	0.66	AWG#12	1"
	LIGHTING CIRCUIT-7	400	10 AWG	20	35	1	10380	600	2	12.9	1.24	0.52	AWG#12	1"
	LIGHTING CIRCUIT-2	510	10 AWG	20	35	1	10380	620	2	12.9	1.64	0.68	AWG#12	1"
LGT PANEL	LIGHTING CIRCUIT-4	590	10 AWG	20	35	1	10380	745	2	12.9	2.28	0.95	AWG#12	1"
LGI PANEL	LIGHTING CIRCUIT-6	1,100	10 AWG	20	35	1	10380	825	5	12.9	4.70	1.96	AWG#12	1"
	LIGHTING CIRCUIT-8	510	10 AWG	20	35	1	10380	630	2	12.9	1.66	0.69	AWG#12	1"
	LIGHTING CIRCUIT-10	800	10 AWG	20	35	1	10380	400	3	12.9	1.66	0.69	AWG#12	1"
	ROLLING GATES CIRCUIT- 14,16	840	10 AWG	20	35	1	10380	320	4	12.9	1.39	0.58	AWG#12	1"
	ROLLING GATES CIRCUIT- 18,20	840	10 AWG	20	35	1	10380	75	4	12.9	0.33	0.14	AWG#12	1"
	ROLLING GATES CIRCUIT- 22,24	840	10 AWG	20	35	1	10380	120	4	12.9	0.52	0.22	AWG#12	1"

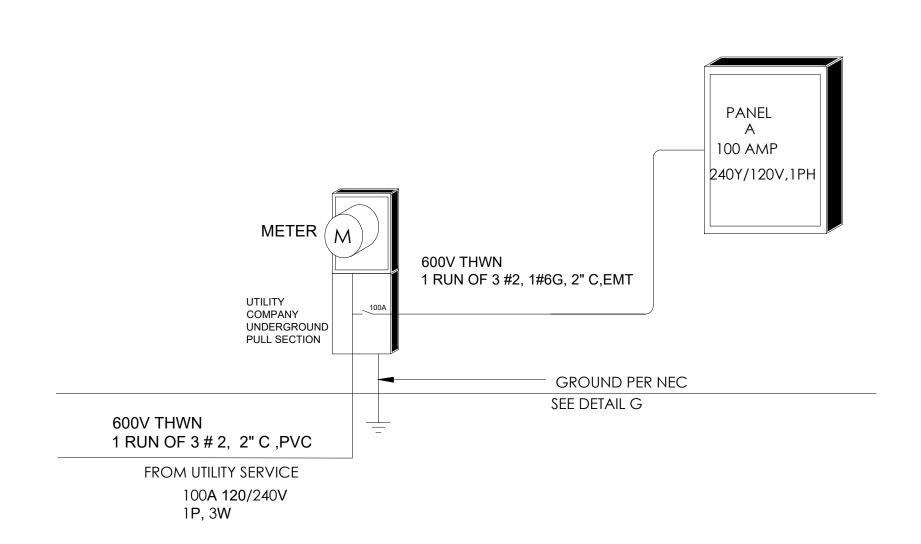

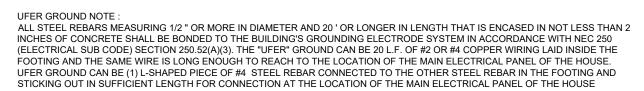

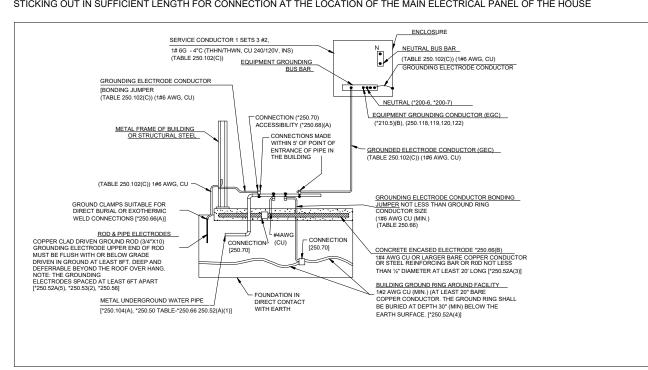

DETAIL "G" OF GROUNDING ELECTRODE SYSTEM (* 250.50) & GROUNDING ELECTRODES (*250.52) AS SERVICE

				CONNEC.	TED LOAD	DEMAND	
*	LOAD SUMMARY	CL	DF	Α	В	TOTAL	
L	Lighting	5.33	1.25	3.32	2.01	6.66	
R	Convenience Recept						
Н	Heating (Space)		1.25				
С	Cooling		1.00				
A	HVAC		1.00				
Р	Process		1.00				
0	Other Continuous		1.25				
K	Kitchen		0.65				
N	Noncontinuous		1.00				
M	Motor	4.20	1.00	2.10	2.10	4.20	
	Total	9.53		5.42	4.11	10.86	

Total Demand Load (KVA) 10.86
Total Demand Current (A) 45.27
Min. Feeder Ampacity (A) 56.58

LTG PANEL					
PANELBOARD DESIGNATION					
SYSTEM VOLTAGE	240/120V, 1Ф, 3W				
BUS SIZE	100				
SYSTEM TYPE	NORMA L				
FEEDER PROT	100A-2P C/B BUS PLUG				
CONDUCTOR SIZE	2 AWG - #6G CU				
CONDUCTOR/PHASE	1				
MAINS	100A MCB				
SCCR	FULLY RATED				
MCB RATING	80%				
GROUND FAULT	NO				
FEEDER LENGTH (FT)	100				
FEEDER V. DROP (%)	1.620				
FAULT CURRENT					
KAIC RATING	42				
ENCLOSURE	TYPE1				

	DESCRIPTION	*	СВ	KVA	Α	В	KVA	СВ	DESCRIPTION	*	
1	LIGHTING CIRCUIT WITH TIME CONTROL	L	20A-1P	0.40	0.91		0.51	20A-1P	LIGHTING CIRCUIT WITH TIME CONTROL	L	2
3	LIGHTING CIRCUIT WITH TIME CONTROL	L	20A-1P	0.51		1.10	0.59	20A-1P	LIGHTING CIRCUIT WITH TIME CONTROL	L	4
5	LIGHTING CIRCUIT WITH TIME CONTROL	L	20A-1P	0.51	1.61		1.10	20A-1P	LIGHTING CIRCUIT WITH TIME CONTROL	L	6
7	LIGHTING CIRCUIT WITH TIME CONTROL	L	20A-1P	0.40		0.91	0.51	20A-1P	LIGHTING CIRCUIT WITH TIME CONTROL	L	8
9	SPARE		20A-1P		0.80		0.80	20A-1P	LIGHTING CIRCUIT WITH TIME CONTROL	L	10
1	SPARE		20A-1P					20A-1P	SPACE		12
3	SPA RE		20A-1P		0.42		0.42	20A-2P	ROLLING SECURITY GATES	М	14
5	SPARE		20A-1P			0.42	0.42	20A-21		М	16
7	SPARE		20A-1P		0.42		0.42	20A-2P	ROLLING SECURITY GATES	М	18
9	SPARE		20A-1P			0.42	0.42	20A-21		М	20
1	SPA RE		20A-1P		0.42		0.42	20A-2P	ROLLING SECURITY GATES	М	22
3	SPARE		20A-1P			0.42	0.42	20A-2P		М	24
5	SPARE		20A-1P						SPA CE		26
7	SPARE		20A-1P						SPACE		28
9	SPARE		20A-1P						SPA CE		30
1	SPARE		20A-1P						SPA CE		32
3	SPARE		20A-1P						SPA Œ		34
5	SPARE		20A-1P						SPA CE		36
7	SPARE		20A-1P						SPA CE		38
9	SPA RE		20A-1P						SPA Œ		40
1	SPARE		20A-1P						SPA CE		42
		(K	VA)					Up	dated xx.xx.xxxx		
	Tot	100	VA) Connected	d Load	4.58	3.27		Uр	dated xx.xx.xxxx		

SINGLE LINE DIAGRAM AND PANEL BOARD SCHEDULE

IF THESE DRAWINGS ARE SMALLER THAN 36" x 24" THEY HAVE BEEN REDUCED.

CONTRACTOR SHALL VERIFY ALL DIMENSIONS.

THESE DRAWINGS AND SPECIFICATIONS AS INSTRUMENTS OF SERVICE REMAIN THE PROPERTY OF DRP ENTERPRISES LLC AND SHALL NOT BE USED FOR ANY OTHER PURPOSE OTHER THAN THOSE FOR WHICH THEY HAVE BEEN SUPPLIED OR PREPARED.

THESE DRAWINGS SHALL NOT BE REPRODUCED, COPIED OR TRACED WITHOUT THE WRITTEN CONSENT OF DRP ENTERPRISES LLC

COPYRIGHT © 2022

Revision / Issue	brawn	by	Date
	Revision / Issue		





Project Owner

ROB BILLINGS
SUN MESA ROAD
YUCCA VALLEY, CA


Projec-

PROPOSED
MINI STORAGE
S.E. CORNER
NEWTON LANE AND SUN
MESA ROAD

SCALE

NTC

Project Number & Sheet Number

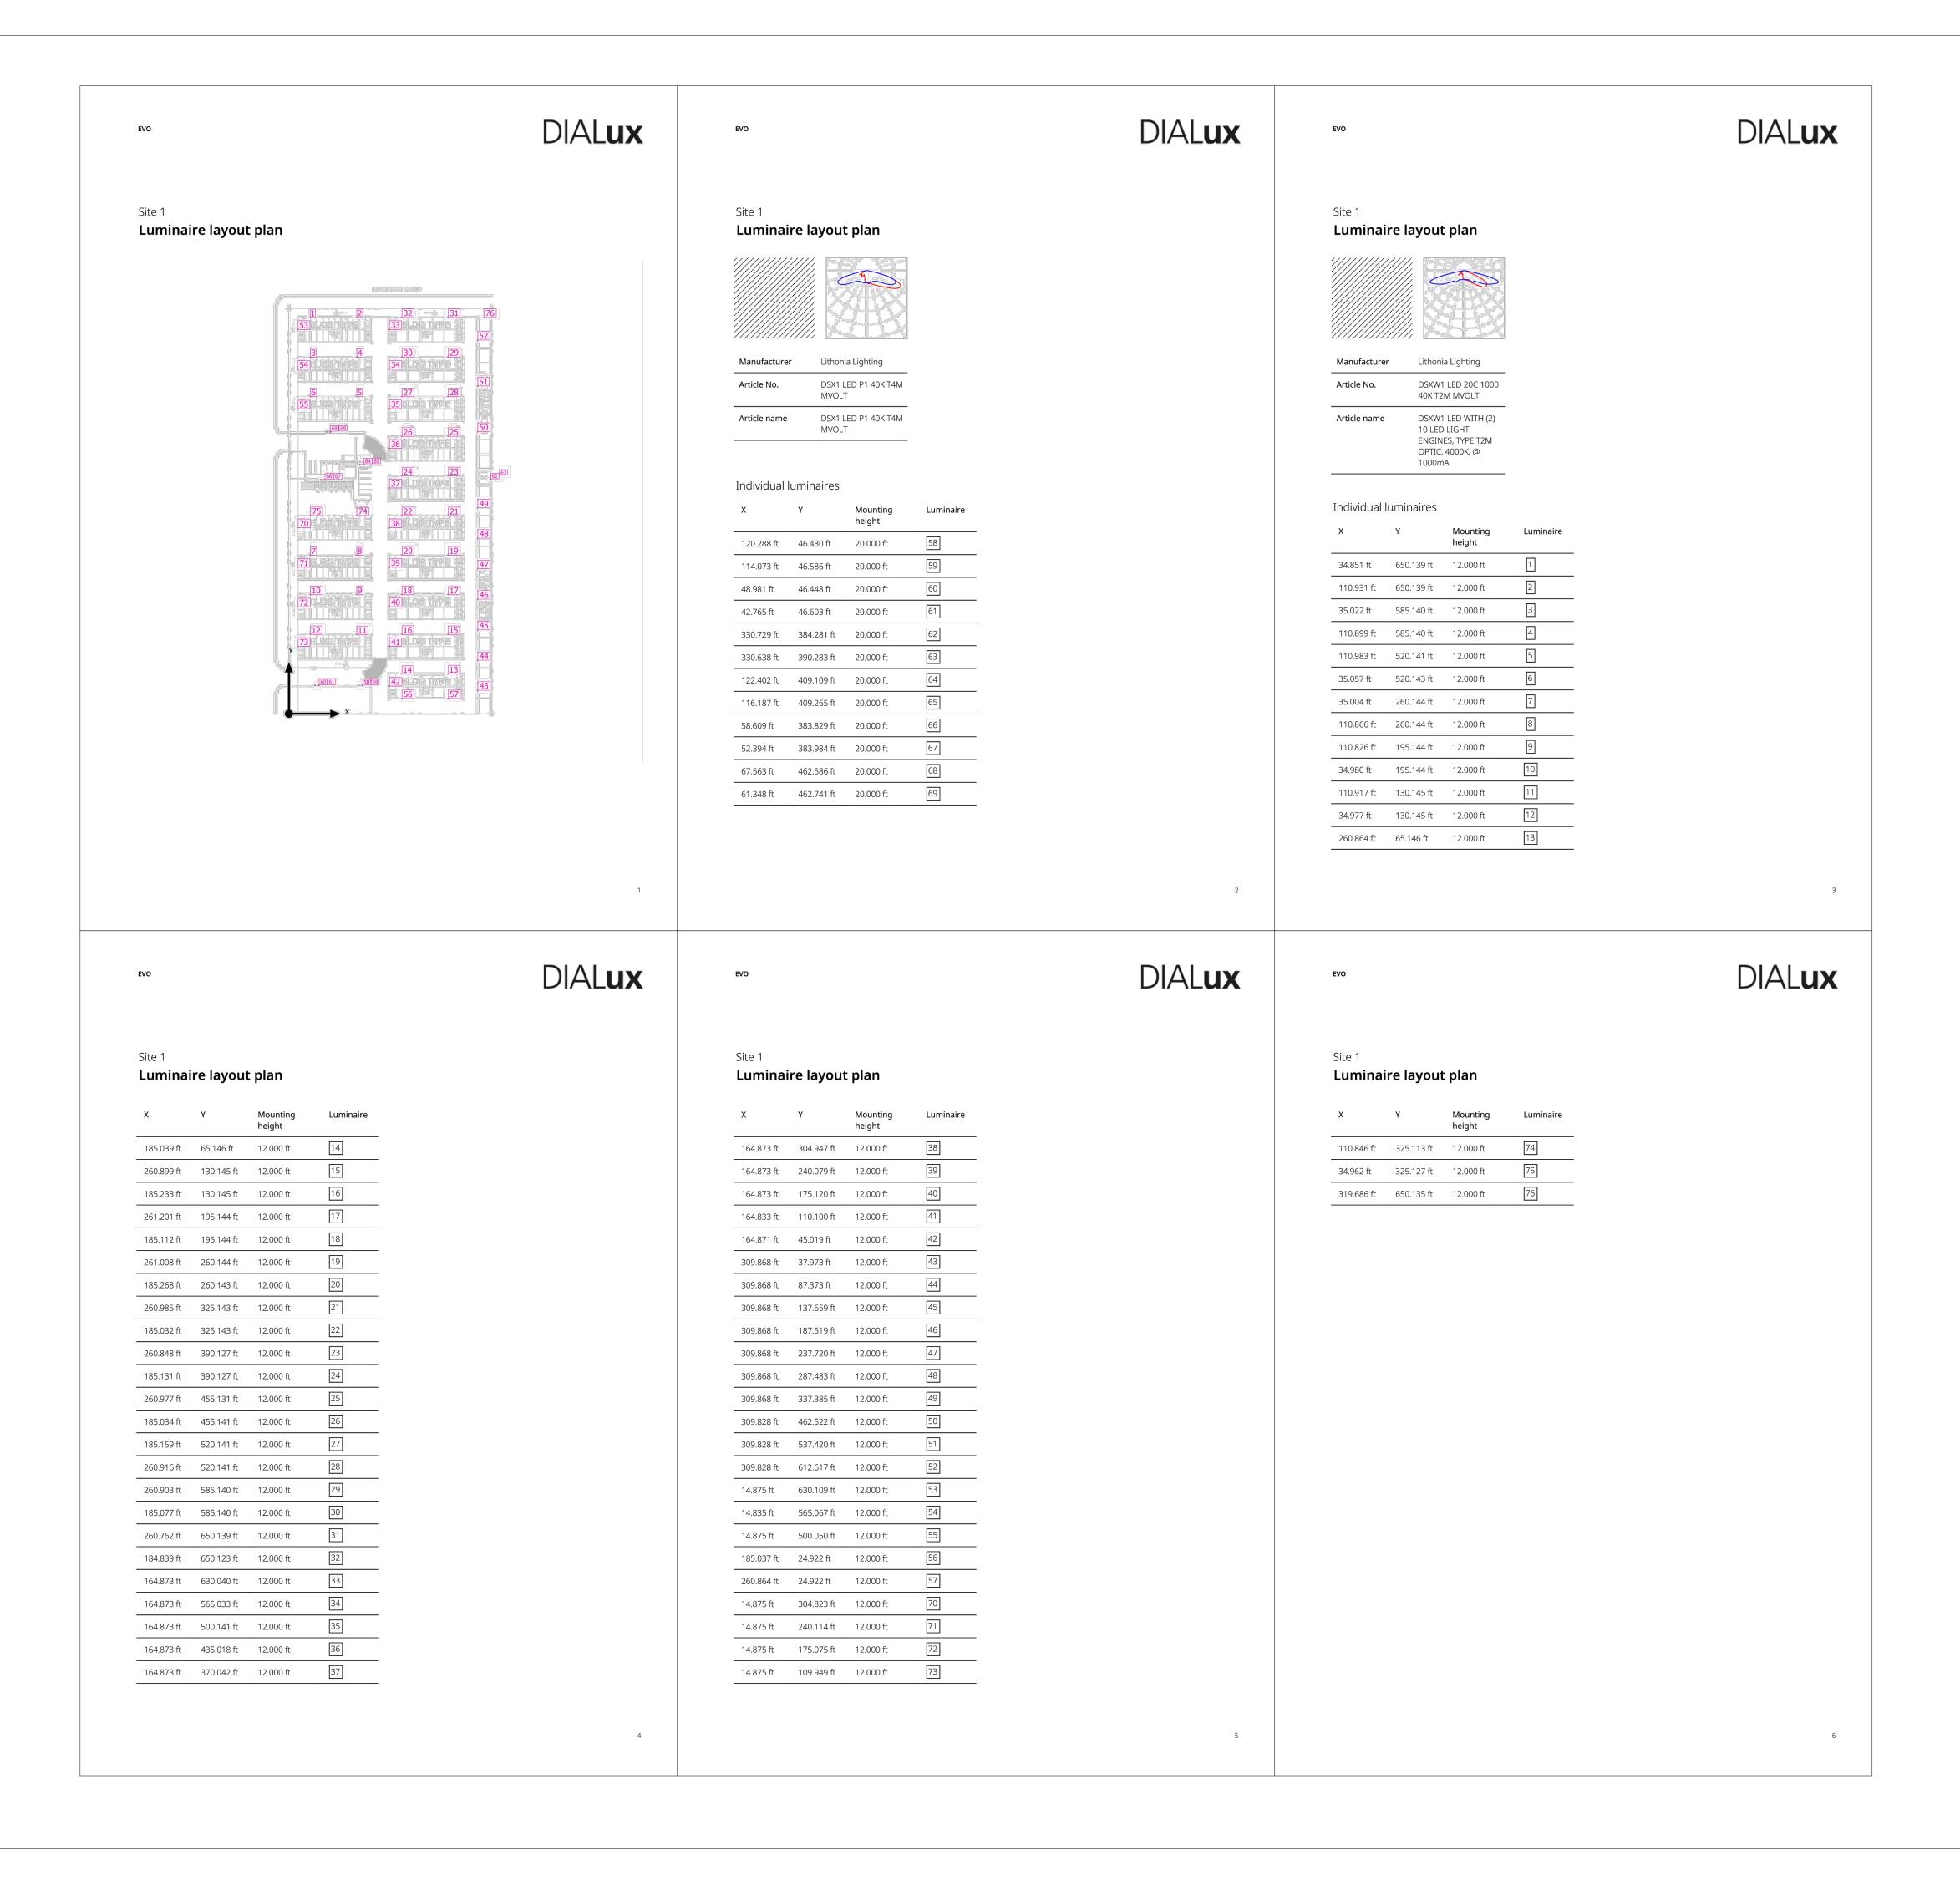

PHOTOMETRIC DATA

IF THESE DRAWINGS ARE SMALLER THAN 36" x 24" THEY HAVE BEEN REDUCED.

CONTRACTOR SHALL VERIFY ALL DIMENSIONS.

THESE DRAWINGS AND SPECIFICATIONS AS INSTRUMENTS OF SERVICE REMAIN THE PROPERTY OF DRP ENTERPRISES LLC AND SHALL NOT BE USED FOR ANY OTHER PURPOSE OTHER THAN THOSE FOR WHICH THEY HAVE BEEN SUPPLIED OR PREPARED.

THESE DRAWINGS SHALL NOT BE REPRODUCED, COPIED OR TRACED WITHOUT THE WRITTEN CONSENT OF DRP ENTERPRISES LLC

COPYRIGHT © 2022

No.	Revision / Issue	brawn	by Cnecked	Date





Project Owner

ROB BILLINGS
SUN MESA ROAD
YUCCA VALLEY, CA

Project

PROPOSED
MINI STORAGE
S.E. CORNER
NEWTON LANE AND SUN
MESA ROAD

SCALE

NTC

Project Number & Sheet Number