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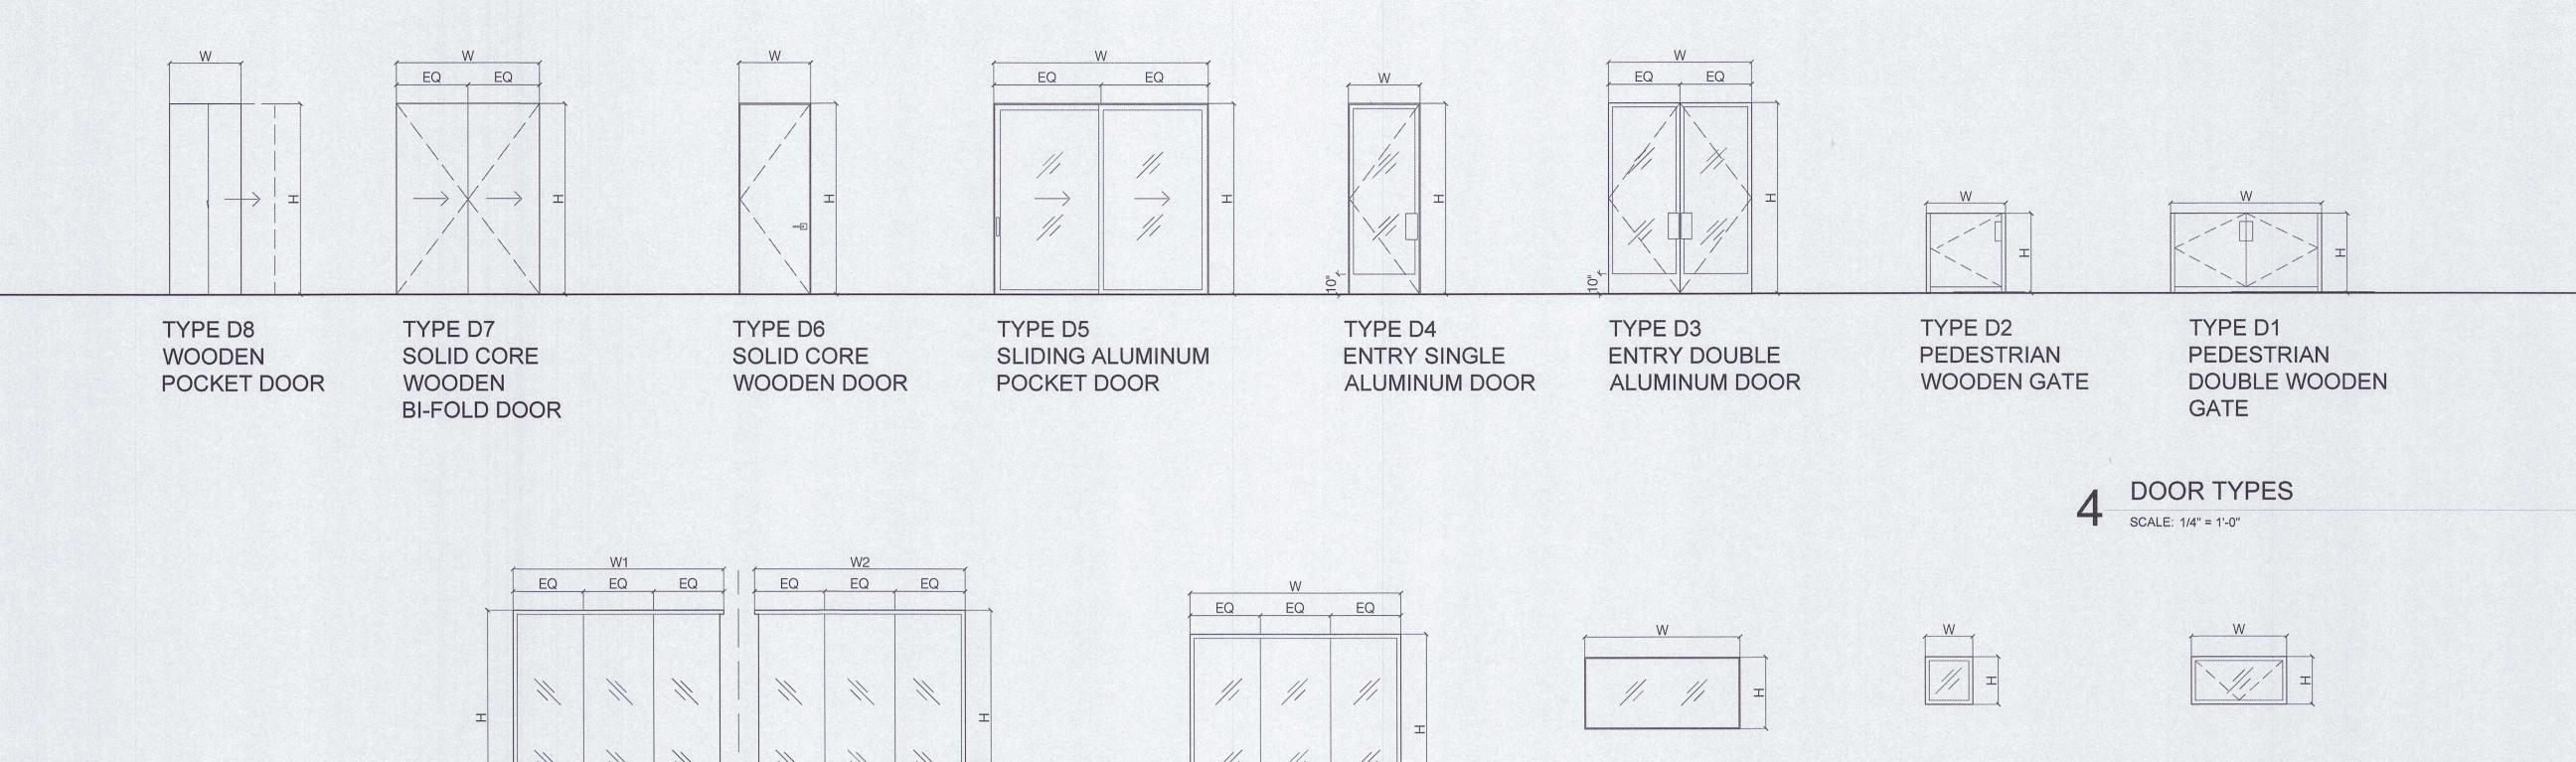
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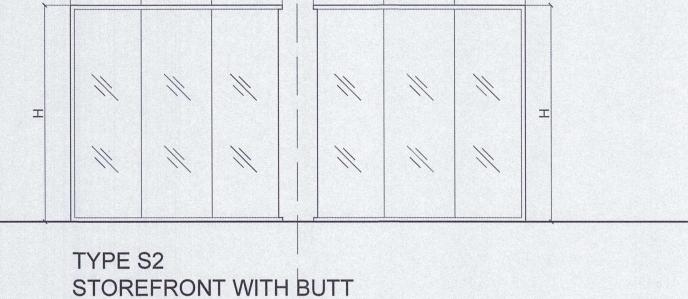
Issue Dates

SHEET TITLE

DOOR WINDOW SCHEDULE

DATE: 09-01-22 SHEET NUMBER





GLAZE JOINTS AND CORNER

GENERAL NOTES

A) INGRESS AND EGRESS DOORS

STANDING SURFACE)

STANDING SURFACE

F) GUARDS AND HANDRAILS

2-1/2" LONG. 91.67.09.5, 91.6709.7

91.6709.1, 91.6709.4

1. EACH UNIT OF TEMPERED GLASS SHALL BE PERMANENTLY IDENTIFIED BY THE

C) DOORS AND ENCLOSURE FOR HOT TUB, BATHTUB, SHOWERS (ALSO

D) IF WITHIN 2' OF VERTICAL EDGE OF CLOSED DOOR AND WITHIN 5' OF

4. WOOD FLUSH-TYPE DOORS SHALL BE 1 3/8" THICK MINIMUM WITH SOLID CORE

5. ALL PIN-TYPE DOOR HINGES ACCESSIBLE FROM OUTSIDE SHALL HAVE

GLAZING IN WALL ENCLOSING THESE COMPARTMENTS WITHIN 5' OF

CONSTRUCTION, 91, 6709.1. DOOR STOPS OF IN-SWINGING DOORS SHALL BE OF ONE-PIECE CONSTRUCTION WITH THE JAMB OR JOINED BY RABBET TO THE JAMB.

NON-REMOVABLE HINGE PINS. HINGES SHALL HAVE MIN. 1/4" DIAMETER STEEL JAMB STUD WITH 1/4" MIN. PROTECTION. THE STRIKE PLATE FOR LATCHES AND HOLDING DEVICE FOR PROJECTING DEAD BOLTS IN WOOD CONSTRUCTION SHALL

BE SECURED TO THE JAMB AND THE WALL FRAMING WITH SCREWS NO LESS THAN

ON THE GLASS AND BE VISIBLE WHEN THE UNIT IS GLAZED.


3. GLAZING IN HAZARDOUS LOCATIONS SHALL BE TEMPERED. 91.2406.4

2. ALL GLASS LITES IN DOORS AND SIDE LITES TO BE TEMPERED.

PANELS IN SLIDING OR SWINGING DOORS

E) IN WALL ENCLOSING STAIRWAY LANDING

MANUFACTURER. THE IDENTIFICATION SHALL BE ETCHED OR CERAMIC FIRED

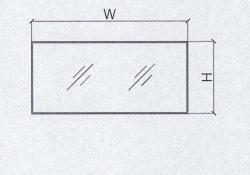

TYPE S1 STOREFRONT WITH BUTT **GLAZE JOINTS**

TYPE W3 WINDOW

TYPE W2 FIXED ALUMINUM

AWNING ALUMINUM

WINDOW TYPES SCALE: 1/4" = 1'-0"

			114171117	1 1 17 (17(100 17(7 11 100) 17(7 100			SGHC: 0.23			
C1	6'-0" X 3'-4"	D1	EXT	WOOD	NATURAL WOOD STAIN	WOOD			GATES TO HAVE HOLD OPEN DEVICES	
C2	3'-0" X 3'-4"	D2	EXT	WOOD	NATURAL WOOD STAIN	WOOD			GATES TO HAVE HOLD OPEN DEVICES	
101.1	6'-0" X 8'-0"	D3	EXT	ALUMINUM	ANODIZED DARK GRAY	IGU	CLEAR/TEMPERED		ENTRY DOORS TO HAVE MINIMUM 10" KICKPLATE	
103.1	3'-0" X 8'-0"	D6	INT	WOOD	BRUSHED WHITE	SOLID CORE WOOD				
104.1	2'-8" X 6'-8"	D7	INT	WOOD	BRUSHED WHITE	SOLID CORE WOOD				
105.1	3'-0" X 8'-0"	D6	INT	WOOD	BRUSHED WHITE	SOLID CORE WOOD				
106.1	9'-0" X 8'-0"	D5	EXT	ALUMINUM	ANODIZED DARK GRAY	IGU	CLEAR/TEMPERED			
106.2	3'-0" X 8'-0"	D4	EXT	ALUMINUM	ANODIZED DARK GRAY	IGU	CLEAR/TEMPERED		ENTRY DOORS TO HAVE MINIMUM 10" KICKPLATE	
106.3	5'-1 1/4" X 8'-0"	D7	INT	WOOD	BRUSHED WHITE	SOLID CORE WOOD			BI-FOLD DOOR TO BE FLUSHED WITH WALL AT CLOSED CONDITION WITH CONCEALED FRAMES.	
	DOOR SCHEDULE								SCHEDULE	
				SCALE:						
								SUALE.		

WINDOW SCHEDULE

NO.	WIDTH x HEIGHT	TYPE	SILL HEIGHT (AFF)	INT/EXT	FRAME MATERIAL	FINISH	BODY MATERIAL	GLAZING U VALUE: 0.27 SGHC: 0.23	DETAIL	NOTES
101.2	8'-10" X 8'-0"	S1	0'-0"	EXT	ALUMINUM	ANODIZED DARK GRAY	IGU	CLEAR/TEMPERED		INNER STOREFRONT DIVISIONS SHALL BE BUTT GLAZED.
101.3	8'-10" X 8'-0"	S1	0'-0"	EXT	ALUMINUM	ANODIZED DARK GRAY	IGU	CLEAR/TEMPERED		
101.4	6'-6" X 3'-0"	W3	4'-0"	EXT	½" ANODIZED ALUMINUM PLATE	ANODIZED DARK GRAY	IGU	CLEAR/TEMPERED		IGU SHALL BE BUTT GLAZED TO ANODIZED ALUMINUM PLATE POP OUT (REFER TO DETAIL)
101.5	W1 7'-10" X 9'-0" W2 7'-10" X 9'-0"	S2	0'-0"	EXT	ALUMINUM	ANODIZED DARK GRAY	IGU	CLEAR/TEMPERED		INNER AND CORNER STOREFRONT DIVISIONS SHALL BE BUTT GLAZED.(REFER TO DETAIL)
103.1	4'-0" X 2'-0"	W1	5'-0"	EXT	ALUMINUM	ANODIZED DARK GRAY	IGU	CLEAR/TEMPERED		
104.2	2'-0" X 2'-0"	W2	5'-0"	EXT	ALUMINUM	ANODIZED DARK GRAY	IGU	CLEAR/TEMPERED		
105.2	2'-0" X 2'-0"	W2	5'-0"	EXT	ALUMINUM	ANODIZED DARK GRAY	IGU	CLEAR/TEMPERED		

WINDOW SCHEDULE

FIXED BUTT GLAZED

WINDOW

TYPE W1 WINDOW

DOOR SCHEDULE

DOD DOD	GATES TO HAVE HOLD OPEN DEVICES
)OD	
	GATES TO HAVE HOLD OPEN DEVICES
GU CLEAR/TEMPERE	RED ENTRY DOORS TO HAVE MINIMUM 10" KICKPLATE
RE WOOD	
RE WOOD	
RE WOOD	
GU CLEAR/TEMPERE	RED
GU CLEAR/TEMPERE	RED ENTRY DOORS TO HAVE MINIMUM 10" KICKPLATE
RE WOOD	BI-FOLD DOOR TO BE FLUSHED WITH WALL AT CLOSED CONDITION WITH CONCEALED FRAMES.

10. ALL ENTRY DOORS SHALL COMPLY WITH CA ADA REQS.

9. GLASS DOORS ADJACENT PANELS AND ALL GLAZED

6. SLIDING DOORS SHALL BE PROVIDED WITH A DEVICE IN THE

CLOSED OR PARTIALLY OPEN POSITION. 91.6710

8. THE EXIT DOOR MUST OPEN OVER A LANDING NOT MORE

THAN 1/2" BELOW THE THRESHOLD PER 1997 UBC 1003.3.1.6

OPENINGS WITHIN 18" OF THE FLOOR SHALL BE OF GLASS

APPROVED FOR IMPACT HAZARD PER 1997 UBC SECTION

ALL GLAZING TO BE USED TO MEET TITLE-24 SPECS.

UPPER CHANNEL OF THE MOVING PANEL TO PROHIBIT

RAISING AND REMOVING OF THE MOVING PANEL IN THE