

TOWN OF YUCCA VALLEY

GILLIS + PANICHAPAN ARCHITECTS, INC.

Jack Panichapan, AIA
PRINCIPAL-IN-CHARGE

CONSTRUCTION SET - 02/02/2022

SENIOR CENTER - KITCHEN EQUIPMENT UPGRADES

PROJECT NO. 4107

57088 TWENTYNINE PALMS HIGHWAY
YUCCA VALLEY, CA 92284

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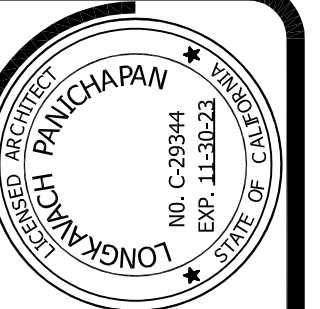
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CONSTRUCTION SET

DATE: 01/13/2022	DATE: 12/08/21
BLDG. DEPT. CORRECT.	JOB NO.: 4107
	DRAWN BY: STAFF
	CHECKED BY: LP
	SCALE:

COVER SHEET

TOWN OF YUCCA VALLEY
Senior Center - Kitchen Equipment Upgrades

CV-1

GENERAL NOTES

GENERAL NOTES (CON'T)

ABBREVIATIONS

PROJECT DIRECTORY

PROJECT DESCRIPTION

1. THESE PLANS AND SPECIFICATIONS ARE THE PROPERTY OF THE TOWN OF YUCCA VALLEY AND ARE NOT TO BE USED FOR OTHER PROJECTS WITHOUT THE PERMISSION OF THE ARCHITECT.
2. THESE NOTES APPLY TO ALL DRAWINGS, UNLESS NOTED OTHERWISE. ANY OMISSIONS OR CONFLICTS BETWEEN THE VARIOUS ELEMENTS OF THE DRAWINGS AND/OR GENERAL NOTES ARE TO BE BROUGHT TO THE ATTENTION OF THE OWNER BEFORE PROCEEDING WITH ANY WORK SO INVOLVED.
3. ALL DRAWINGS AND SPECIFICATIONS ARE CONSIDERED TO BE PART OF THE CONTRACT DOCUMENTS. THE CONTRACT DRAWINGS AND SPECIFICATIONS REPRESENT THE FINISHED STRUCTURE, UNLESS OTHERWISE SHOWN. THEY DO NOT INDICATE METHOD OF CONSTRUCTION. CONTRACTOR IS TO SUPERVISE AND DIRECT THE WORK UNDER HIS CONTRACT AND IS SOLELY RESPONSIBLE FOR ALL CONSTRUCTION MEANS, METHODS, TECHNIQUES, SEQUENCES, AND PROCEDURES. OBSERVATION VISITS TO THE SITE BY FIELD REPRESENTATIVES OF THE OWNER AND / OR HIS CONSULTANTS ARE NOT TO INCLUDE INSPECTIONS OF REQUIRED FOR SAME, WHICH ARE THE SOLE RESPONSIBILITY OF THE CONTRACTOR. ANY SUPPORT SERVICES PERFORMED BY THE OWNER AND / OR HIS CONSULTANTS DURING CONSTRUCTION ARE TO BE DISTINGUISHED FROM CONTINUOUS AND DETAILED INSPECTION SERVICES WHICH ARE FURNISHED BY OTHERS. THESE SUPPORT SERVICES PERFORMED BY THE OWNER AND / OR HIS CONSULTANTS, WHETHER OF MATERIAL OR WORK, AND WHETHER PERFORMED PRIOR TO, DURING OR AFTER COMPLETION OF CONSTRUCTION ARE PERFORMED SOLELY FOR THE PURPOSE OF ASSISTING IN QUALITY CONTROL AND IN ACHIEVING GENERAL CONFORMANCE WITH DESIGN CONCEPT AND CONTRACT DRAWINGS AND SPECIFICATIONS AND THEREFORE, THEY DO NOT GUARANTEE CONTRACTORS PERFORMANCE AND ARE NOT TO BE CONSTRUED AS SUPERVISION OF CONSTRUCTION.
4. CONTRACTOR SHALL FAMILIARIZE HIMSELF WITH ALL EXISTING FACILITIES TO BE DEMOLISHED/ REMOVED, TEMPORARILY REMOVED AND RE-INSTALLED, RELOCATED OR REMAIN INTACT AND HOW THE NEW CONSTRUCTION RELATES TO THE EXISTING SITE CONDITIONS.
5. THE CONTRACTOR SHALL EXAMINE THE JOB SITE. CONFIRM ALL UTILITY LOCATIONS, SIZES, PRESSURES, ETC., AND PROTECT, RELOCATE, CONNECT OR REMOVE ALL NECESSARY FOR TOTAL PROJECT COMPLETION. VERIFY ALL DIMENSIONS AND SATISFY HIMSELF AS TO THE EXISTING CONDITIONS UNDER WHICH HE WILL BE OBLIGATED TO OPERATE. NOTIFY THE OWNER OF ANY AND ALL DISCREPANCIES PRIOR TO COMMENCING WORK.
6. ALL CONTRACTORS AND SUBCONTRACTORS SHALL FAMILIARIZE THEMSELVES WITH THE CONTENTS OF ALL THE DRAWING AND ALL SPECIFICATION SECTIONS, REGARDLESS OF THEIR LICENSE CLASSIFICATION. NO REQUEST FOR CHANGE ORDER WILL BE CONSIDERED BASED UPON INFORMATION FOUND IN ONE AREA OF THE PLANS OR SPECIFICATIONS, AND NOT THE OTHER. INFORMATION FOUND IN ONE PART OF THE PLANS SHALL BE DEEMED TO BE IN ALL SECTIONS.
7. ALL SYMBOLS AND ABBREVIATIONS USED ON THE DRAWINGS ARE CONSIDERED TO BE CONSTRUCTION STANDARDS. IF CLARIFICATION IS REQUIRED THE CONTRACTOR SHALL NOTIFY THE ENGINEER PRIOR TO PROCEEDING WITH THE BID WORK.
8. DO NOT SCALE DRAWINGS. PRINTED DIMENSIONS HAVE PRECEDENCE OVER SCALED DRAWINGS AND LARGE SCALE OVER SMALL. DIMENSIONS SHOWN ARE TO THE FACE OF WALL FRAMING (CMU, STUD) UNLESS OTHERWISE NOTED.
9. ALL DIMENSIONS AND THE SITE CONDITIONS SHALL BE VERIFIED BY THE CONTRACTOR AT THE JOB SITE PRIOR TO BID SUBMITTAL. START OF SHOP DRAWINGS, START OF CONSTRUCTION, AND/OR FABRICATION OF MATERIALS. IF DISCREPANCIES ARE ENCOUNTERED, OR CONDITIONS DEVELOP NOT COVERED BY THE CONTRACT DOCUMENTS, THE OWNER SHALL BE NOTIFIED FOR CLARIFICATION.
10. ANYONE SUPPLYING LABOR AND MATERIALS TO THE PROJECT IS TO CAREFULLY EXAMINE ALL SUBSURFACES TO RECEIVE WORK. ANY CONDITIONS DETRIMENTAL TO WORK TO BE REPORTED IN WRITING TO OWNER & PROJECT ARCHITECT PRIOR TO BEGINNING WORK. COMMENCEMENT OF WORK IMPLIES ACCEPTANCE OF SUBSURFACES.
11. PROVIDE OPENINGS AND SUPPORTS FOR MECHANICAL EQUIPMENT, DUCTS, PIPING, VENTS, ETC., AS REQUIRED. REFER TO ARCHITECTURAL AND MECHANICAL DRAWINGS FOR ADDITIONAL OPENINGS AND EQUIPMENT NOT SHOWN ON STRUCTURAL DRAWINGS. ALL SUSPENDED EQUIPMENT AND MATERIALS TO BE INSTALLED WITH APPROVED LATERAL BRACING. VERIFY SIZES AND LOCATIONS OF ALL MECHANICAL EQUIPMENT BEFORE CONSTRUCTION OF ANY BASES OR PADS TO SUPPORT SUCH EQUIPMENT. VERIFY ALL PLUMBING AND EQUIPMENT SIZES BEFORE BEGINNING CONSTRUCTION.
12. NOTIFY THE OWNER IF ANY CONDITIONS EXIST WHICH WILL PREVENT THE COMPLETION OF WORK IN A PROFESSIONAL AND SATISFACTORY MANNER AS WELL AS ANY AND ALL ADDITIONAL WORK TO BE PERFORMED BEFORE STARTING WORK ALL NOTIFICATIONS SHALL BE IN WRITING.
13. ALL CONTRACTORS AND SUB-CONTRACTORS SHALL OBTAIN A CITY BUSINESS LICENSE.
14. THE CONTRACTOR SHALL TAKE ALL PRECAUTIONARY MEASURES NECESSARY TO PROTECT EXISTING IMPROVEMENTS, WHICH ARE TO REMAIN IN PLACE, FROM DAMAGE. ANY IMPROVEMENTS DAMAGED BY THE CONTRACTOR'S OPERATIONS SHALL BE EXPEDITIOUSLY REPAIRED OR RECONSTRUCTED TO THE ENGINEER'S SATISFACTION AT THE CONTRACTOR'S EXPENSE WITHOUT ADDITIONAL COMPENSATION.
15. LOCATION OF EXISTING PIPING AND EQUIPMENT IS BASED ON RECORD DRAWINGS AND FIELD INFORMATION. CONTRACTOR SHALL FIELD LOCATE ALL EXISTING PIPING AND EQUIPMENT THAT CONFLICTS WITH CONSTRUCTION AND REMOVE AND REPLACE AS REQUIRED. AFTER CONSTRUCTION IS COMPLETE, EXISTING PIPING SYSTEMS SHALL BE RETURNED TO THE SAME OR BETTER CONDITION THAN AS RECORDED BEFORE. ALL FIELD RELOCATION OF EXISTING PIPING SHALL BE RECORDED ON RECORD DRAWINGS. IN AREAS WHERE GAS PIPING IS LOCATED, CONTRACTOR SHALL POTHOLE AND LOCATE GAS PIPING BEFORE EXCAVATION OF THE AREA.
16. CONTRACTOR SHALL TAKE ALL NECESSARY PRECAUTIONS TO PREVENT DAMAGE TO THE EXISTING STRUCTURES OR OTHER EXISTING IMPROVEMENTS TO REMAIN. CONTRACTOR SHALL ALSO PROVIDE ALL NECESSARY BRACING, SCAFFOLDING OR OTHER MEASURES NECESSARY FOR CONSTRUCTION.
17. REMOVAL, ABANDONMENT OR TEMPORARY RELOCATION OF EXISTING PIPES OR UTILITIES SHALL BE SCHEDULED WITH THE ENGINEER TO AVOID UNNECESSARY DISRUPTION OF PLANT OPERATIONS.
18. ELEVATIONS SHOWN ARE BASED UPON THE AS-BUILT DRAWINGS. CONTRACTOR SHALL FIELD VERIFY AND ADJUST ELEVATIONS AS REQUIRED TO MAINTAIN DIMENSIONAL RELATIONSHIPS DEPICTED IN THE DRAWINGS.
19. THE CONTRACTOR SHALL COMPLY WITH CAL-OSHA AND ALL OTHER LOCAL AGENCY REQUIREMENTS.
20. CONTRACTOR SHALL RESTORE ALL EXISTING PAVED AREAS, GUARDRAILS AND HANDRAILS DISTURBED DURING CONSTRUCTION INCLUDING INSTALLATION OF PIPELINES, DRAINS AND ELECTRICAL DUCTS TO ORIGINAL CONDITION. CURB AND GUTTER, AREA DRAINS, AND ALL SITE DRAINAGE AFFECTED BY THE WORK SHALL BE RETURNED TO THE SAME OR BETTER CONDITION AFTER WORK IS COMPLETED.
21. THE CONTRACTOR SHALL COMPLY WITH STATE DEPARTMENT OF HEALTH SERVICE CRITERIA FOR THE SEPARATION OF POTABLE WATER MAINS AND SANITARY SEWERS, ASSET FORTH IN SECTION 64630, TITLE 22 OF THE CALIFORNIA ADMINISTRATIVE CODE.
22. THE CONTRACTOR SHALL NOTIFY THE ENGINEER, IN WRITING, AS SPECIFIED, 72 HOURS IN ADVANCE OF MAKING ANY CONNECTION TO AN ACTIVE PIPELINE OR UTILITY SYSTEM, AND SHALL RECEIVE THE ENGINEERS CONSENT BEFORE PROCEEDING.

24. THE CONTRACTOR SHALL SCHEDULE HIS WORK TO CONTINUOUSLY MAINTAIN SENIOR CENTER OPERATIONS AND SHALL NOT UNDULY RESTRICT ACCESS OR CIRCULATION.
25. THE CONTRACTOR SHALL PROVIDE ADEQUATE SANITARY CONVENIENCES, WATER AND SHADE FOR THE USE OF ALL PERSONS AT THE CONSTRUCTION SITE OF THE WORK. SUCH CONVENIENCES SHALL INCLUDE CHEMICAL TOILETS OR WATER CLOSETS LOCATED AT APPROPRIATE LOCATIONS. POTABLE WATER AND SHADE SHALL ALSO BE PROVIDED. AT COMPLETION OF THE WORK ALL SUCH CONVENIENCES SHALL BE REMOVED AND THE SITE LEFT IN SANITARY CONDITION.
26. THE CONTRACTOR SHALL FURNISH POTABLE WATER FOR A DRINKING SOURCE OTHER THAN THE EXISTING PLANT UTILITY WATER SUPPLY, WHICH SHALL MEET ALL THE REQUIREMENTS OF THE TOWN AND STATE HEALTH DEPARTMENTS. CONTRACTOR SHALL ALSO SUPPLY AMPLE SIGNS THROUGHOUT THE WORK SITE AREA ADVISING HIS EMPLOYEES THAT THE PLANT WATER IS NOT POTABLE.
27. THE CONTRACTOR SHALL PROVIDE AT HIS OWN COST ALL ELECTRICAL POWER NECESSARY FOR CONSTRUCTION, TESTING, GENERAL AND SECURITY LIGHTING AND ALL OTHER PURPOSES, WHETHER SUPPLIED THROUGH TEMPORARY OR PERMANENT FACILITIES.
28. THE CONTRACTOR SHALL NOTE THAT THERE MAY BE OTHER PROJECTS UNDER CONSTRUCTION AT THIS SITE AND/OR NEARBY SITE. CONTRACTOR SHALL COORDINATE WITH THE OTHER CONTRACTORS PRESENT ON THE SITE DURING THE COURSE OF CONSTRUCTION.
29. AREAS WHERE MECHANICAL COMPACTION OF BACKFILL CANNOT BE ACCOMPLISHED, CONTRACTOR SHALL USE A 2-SACK CEMENT/SAND SLURRY FOR BACKFILL.
30. IRRIGATION LINES ARE NOT MARKED AND SHALL BE THE RESPONSIBILITY OF THE CONTRACTOR TO CORRECT AT NO COST TO THE TOWN.
31. ELECTRICAL CONDUIT RUNS PARALLEL TO PROJECT AND CROSSES VICINITY. CONTRACTOR SHALL IDENTIFY LATERALS IN PLACE AND PROVIDE THE INFORMATION TO THE ENGINEER LOCATING PRIOR TO STARTING WORK.

CODE (GENERAL)

1. IT IS THE RESPONSIBILITY OF ANYONE SUPPLYING LABOR OR MATERIALS OR BOTH TO BRING TO THE ATTENTION OF THE OWNER AND PROJECT ARCHITECT ANY DISCREPANCIES OR CONFLICTS BETWEEN THE CODE REQUIREMENTS AND THE DRAWINGS BEFORE PROCEEDING WITH WORK.
2. CONTRACTOR SHALL COMPLY FULLY WITH THE LATEST EDITION OF THE LOCAL BUILDING CODE, ALL LAWS AND ORDINANCES PERTINENT TO ALL WORK OF THIS PROJECT. IN CASE OF ANY CONFLICT WHEREIN THE METHOD OR STANDARDS OF INSTALLATION OR THE MATERIALS SPECIFIED DO NOT EQUAL OR EXCEED THE REQUIREMENTS OF THE LAWS OR ORDINANCES. THE LAWS OR ORDINANCES SHALL GOVERN.
3. ALL WORK SHALL COMPLY WITH TITLE 24 OF THE CODE OF REGULATIONS AND THE UNIFORM BUILDING CODE LATEST EDITION (INDICATED ON THESE SHEETS WITH CBC AMENDMENTS, AND ALL OTHER LOCAL OR STATE AGENCIES HAVING JURISDICTION OVER THIS PROJECT) AND ICBO REGULATIONS.

WATERPROOFING COMMENTS

1. THERE IS A HEIGHTENED CONCERN IN THE CONSTRUCTION INDUSTRY ABOUT THE INTRUSION OF WATER INTO BUILDINGS AND THE RESULTING MOLD THAT DEVELOPS SUBSEQUENTLY. THE OWNER HAS MADE A DILIGENT ATTEMPT TO SPECIFICALLY DETAIL THE PROJECT TO STOP THIS WATER FROM ENTERING THROUGH PENETRATIONS INTO THE BUILDING. HOWEVER, ALL OF THESE AVENUES WHICH ALLOW THE INTRUSION OF WATER INTO THE BUILDING MAY NOT HAVE BEEN OBSERVED DURING DESIGN. DURING THE COURSE OF YOUR CONSTRUCTION OF THE BUILDING, THE OWNER ASKS TO BE ADVISED IMMEDIATELY OF ANY QUESTIONABLE CONDITIONS THAT MAY OCCUR WITH RESPECT TO THE PERCEIVED WATER-TIGHTNESS OF THE STRUCTURE. ONCE A BUILDING SUFFERS A BREACH, AND MOLD DEVELOPS, A BUILDING CAN BECOME UNFIT FOR OCCUPANCY AND CORRECTIONS COSTLY. WE ASK THAT THE CONSTRUCTION TEAM BE DILIGENT IN THEIR CONSTRUCTION EFFORTS TO HELP INSURE THAT, THE BUILDING THAT WE TURN OVER AS A TEAM, WILL BE AS WATERTIGHT AS WE CAN MAKE IT. YOU, THE CONTRACTOR, WILL BE THE LAST HANDS ON THE PROJECT, AND WE ARE CERTAINLY AVAILABLE TO DISCUSS WITH YOU, YOUR CONSTRUCTABILITY IDEAS TO KEEP THIS PROJECT WATERTIGHT.

CLEAN UP

1. RUBBISH CONTAINERS:
A. THE CONTRACTOR SHALL PROVIDE DUMPSTERS THAT ARE ADEQUATE SIZED FOR THE WASTER, DEBRIS AND RUBBISH FOR THE LIFE OF THE PROJECT.
B. THE CONTRACTOR SHALL DISPOSE OF CONTAINER(S) CONTENTS WEEKLY OR AT MORE FREQUENT INTERVALS IF REQIUEM BY INADEQUATE CONTAINER CAPACITY.
C. VOLATILE WASTE AND RUBBISH SHALL NOT BE PLACED IN THE STANDARD RUBBISH CONTAINERS, BUT SHALL BE STORED IN SEPARATE CONTAINERS UNTIL LEGALLY EXPOSED OUTSIDE.
2. CONTRACTOR SHALL SWEEP SITE(S) EACH DAY, CONTRACTOR PROPER RUMBLE PLATE STATION INDICATED BY BMP'S (IF REQUIRED).
3. CONTRACTOR SHALL PROVIDE TEMPORARY DIVIDERS TO CONTAIN CONSTRUCTION DUST FROM ENTERING AREAS ADJACENT TO KITCHEN/PROJECT AREA.
3. FINAL CLEANING:
A. THE CONTRACTOR SHALL PERFORM AN OVERALL CLEANUP OF THE AREA. ALL TRADES SHALL REMOVE THEIR RUBBISH AND DEBRIS FROM THE SITE TO THE RUBBISH COLLECTION CENTER.
B. IF THIS CLEANING IS NOT PERFORMED TO THE SATISFACTION OF THE TOWN, IT WILL BE PERFORMED FOR THE CONTRACTOR AT THE CONTRACTOR'S EXPENSE.

Table with 2 columns: Abbreviation and Full Name. Includes entries like @ ANCHOR BOLT, AC ASPHALTIC CONCRETE, ADJ ADJUSTABLE, etc.

SYMBOLS LEGEND

Diagrammatic symbols for Interior Elevation Bubble, Building Section Bubble, Detail Reference Bubble, Wall Type Mark, Door Type Mark, Window Type Mark, Keynote/Gridline Mark, and Working Point.

LIFE SAFETY

1. PORTABLE FIRE EXTINGUISHERS TO BE PROVIDED IN CABINETS LOCATED WITHIN SEVENTY-FIVE (75) FOOT TRAVEL DISTANCE TO ALL PORTIONS OF THE BUILDING ON EACH FLOOR AND AS SHOWN ON PLANS.
2. CONTRACTOR SHALL MAINTAIN THE RATING OF ALL PENETRATING WALLS AND SHALL APPLY FIRESTOP AND FIREPROOFING, AT HIS EXPENSE, WHENEVER ANY PENETRATION ARE MADE...ETC. FIRESTOP AND FIREPROOFING MATERIAL SHALL BEAR U.L. LISTING NUMBER DEPICTING WALL TYPE COMPOSITION AND FIRE RATED MATERIAL LIMITATIONS. SUBMIT PROPOSED FIRESTOP FIREPROOFING METHOD FOR APPROVAL PRIOR TO APPLICATION IN THE FIELD.

CLIENT / OWNER: TOWN OF YUCCA VALLEY 58928 BUSINESS CENTER DRIVE YUCCA VALLEY, CA 92684 P: 760-369-6579
ARCHITECT: GILLIS + PANICHAPAN ARCHITECT, INC. 2900 BRISTOL ST., STE G-205 COSTA MESA, CA 92626 P: 714-668-4260 F: 714-668-4265
STRUCTURAL ENGINEER: DALE CHRISTIAN STRUCTURAL ENGINEER INC. 1744 WEST KATELLA AVE., SUITE 107 ORANGE, CA 92667 P: 714-290-0718 F: 714-276-0658
MEP ENGINEER: H2S ENGINEERS 675 N. EUCLID STREET, SUITE 518 ANAHEIM, CA 92801 P: 714-290-0718

DEMOLITION NOTES

1. THE CONTRACTOR SHALL VERIFY ALL EXISTING CONDITIONS AND IMPROVEMENTS PRIOR TO DEMOLITION.
2. ALL DEMOLITION SHALL BE CARRIED ON IN SUCH A WAY AS NOT TO DAMAGE EXISTING ELEMENTS THAT ARE TO REMAIN IN PLACE.
3. ALL CONSTRUCTION DEBRIS SHALL BE HAULED OFF SITE FOR LEGAL DUMPING BY THE CONTRACTOR. DISPOSAL OF WASTE MATERIALS AND DEBRIS OFF-SITE SHALL BE IN ACCORDANCE WITH LOCAL, STATE, AND FEDERAL LAWS.
4. ALL DEBRIS SHALL BE REMOVED FROM CONSTRUCTION AREA ON A DAILY BASIS, UNLESS APPROVED BY THE ENGINEER.
5. HOURS OF CONSTRUCTION SHALL BE PREDETERMINED BETWEEN THE TOWN AND THE CONTRACTOR.
6. THE TOWN AND THE CONTRACTOR SHALL HAVE A WALK-THROUGH INSPECTION TO ASSESSES THE CONDITION OF ALL NEARBY EQUIPMENT AND STRUCTURES PRIOR TO START OF DEMOLITION. THE CONTRACTOR SHALL PROVIDE A PRE-CONSTRUCTION, HIGH RESOLUTION VIDEO TO DOCUMENT PRESENT CONDITIONS PRIOR TO THE START OF CONSTRUCTION BEGINNING.
7. IT SHALL BE THE RESPONSIBILITY OF THE CONTRACTOR TO LOCATE ALL EXISTING UTILITIES, WHETHER SHOWN HEREON OR NOT, AND TO PROTECT THEM FROM DAMAGE. DAMAGED EQUIPMENT, UTILITIES, PIPING, AND STRUCTURES SHALL BE REPAIRED AND RESTORED TO ORIGINAL CONDITION AT THE CONTRACTOR'S EXPENSE, IN A MANNER APPROVED BY THE TOWN, AND AS STATED IN THE SPECIFICATIONS.
8. DO NOT USE EXPLOSIVES AND/OR REMOVAL OR DEMOLITION METHODS WHICH MAY CONSTITUTE A FIRE OR SAFETY HAZARD.
9. PROVIDE FOR SAFE PASSAGE OF PERSONS AROUND THE DEMOLITION WORK. PROVIDE SAFE TEMPORARY ACCESS FOR OCCUPANTS. ERECT TEMPORARY COVERED SAFETY FACILITIES AS REQUIRED BY OSHA AND REGULATIONS OF THE JURISDICTIONAL SAFETY AUTHORITIES.
10. CONTRACTOR SHALL PROVIDE FALLING DEBRIS PROTECTION AROUND WORK. (INTERIOR/EXTERIOR AS NEEDED)

ACCESSIBILITY

AS REQUESTED BY YUCCA VALLEY, THE SITE AND BUILDING ACCESSIBILITY (PATH OF TRAVEL, ETC.) HAS NOT BEEN INCLUDED OR ASSESSED IN THE SCOPE OF WORK (KITCHEN EQUIPMENT REPLACEMENT). ALL EXISTING ACCESSIBILITY CONDITIONS OUTSIDE OF THE SPECIFIC SCOPE OF WORK IS TO REMAIN AS-IS.

GENERAL DEMOLITION NOTES

1. KEYNOTES AND ITEMS NOTED AS "DEMO" AND/OR "DEMOLISH" AND/OR "REMOVE" INDICATES DIRECTION FOR THE CONTRACTOR TO CAREFULLY REMOVE THE ITEM AND/OR SYSTEM FROM THE BUILDING AND DISPOSE OF OFF-SITE IN A WAY PERMITTED BY LOCAL AND STATE REGULATIONS.
2. SELECTIVE DEMOLITION TO SPECIFIC ITEMS AROUND MATERIALS TO REMAIN SHOULD BE REMOVED WITH CARE AS TO NOT DAMAGE THE ADJACENT MATERIAL/ITEM THAT IS TO REMAIN.
3. DEMOLITION WORK NEAR ITEMS IDENTIFIED AS HAVING ASBESTOS CONTAINING MATERIALS AND/OR LEAD BASED MATERIALS SHALL COMPLY WITH RECOMMENDATIONS NOTED IN REPORT AND PER RULES AND REGULATIONS PERTAINING TO HAZARDOUS MATERIALS ABATEMENT AND/OR ENCAPSULATION.
4. IT IS THE CONTRACTOR'S RESPONSIBILITY TO STORE AND PROTECT ITEMS NOTED FOR TEMPORARY REMOVAL AND RE-INSTALLATION. COORDINATE WITH OWNER FOR POTENTIAL LOCATIONS ON-SITE FOR TEMPORARY STORAGE.
5. WORKING AND/OR FUNCTIONING EQUIPMENT THAT WILL BE TEMPORARILY REMOVED AND RE-INSTALLED MAY REQUIRE VERIFICATION OF CONDITION PRIOR TO REMOVAL. EQUIPMENT DEMONSTRATION AFTER RE-INSTALLATION MAY BE REQUESTED BY THE OWNER. CONTRACTOR TO BE RESPONSIBLE FOR SAFELY DISCONNECTING POWER TO EQUIPMENT AND/OR PROVIDING TEMPORARY EQUIPMENT SUPPORT DURING INTERIM STORAGE.

CONSTRUCTION COORDINATION

1. THE GENERAL CONTRACTOR WILL COORDINATE ACCESS TO AND FROM THE SITE WITH THE TOWN.
2. BUILDING SECURITY DURING CONSTRUCTION AND OFF-HOURS SHALL BE COORDINATED WITH THE TOWN. IT WILL BE THE RESPONSIBILITY OF THE CONTRACTOR TO SECURE THE SITE AND BUILDING DURING CONSTRUCTION AND REMODEL.

APPLICABLE CODES

Table with 2 columns: Code Name and Year. Includes California Building Code 2019, California Electrical Code 2019, California Mechanical Code 2019, California Plumbing Code 2019.

PROJECT ADDRESS

YUCCA VALLEY SENIOR CENTER 57088 TWENTYNINE PALMS HIGHWAY YUCCA VALLEY, CA 92284

OWNER PROVIDED AND CONTRACTOR INSTALLED EQUIPMENT


- 1. THE OWNER WILL PROVIDE THE FOLLOWING ITEMS/SYSTEM FOR CONTRACTOR TO INSTALL:
1.1. WALK-IN FREEZER AND MECHANICAL SYSTEM (NOT ASSEMBLED)
1.2. WALK-IN COOLER AND MECHANICAL SYSTEM (NOT ASSEMBLED)
2. THE CONTRACTOR SHALL INSTALL THE EQUIPMENT INCLUDING, BUT NOT LIMITED TO THE FOLLOWING WORK:
2.1. SURVEY THE EXISTING WALK-IN EQUIPMENT (WITH OWNER) THAT WILL BE STORED ON-SITE (200 FEET FROM PROJECT BUILDING) AND ACKNOWLEDGE THE CONDITION OF EQUIPMENT (WITH VISUAL INSPECTION) AND PROVIDE A WRITTEN DOCUMENT STATING OBSERVED CONDITION OF BOXED EQUIPMENT.
2.2. REVIEW WALK-IN EQUIPMENT/SYSTEM'S ELECTRICAL AND PLUMBING REQUIREMENTS AND COORDINATE AS REQUIRED WITH PROPOSED WORK SHOWN ON DRAWINGS.
2.3. SURVEY THE EXISTING ROOMS/AREAS TO RECEIVE THE EQUIPMENT.
2.4. SURVEY THE EXISTING ROOFTOP LAYOUT (EXISTING AND PROPOSED) PROVIDE AND INSTALL ALL ROOF PENETRATIONS, ELECTRICAL WIRING/CONDUIT, PLUMBING (CONDENSATE DRAIN SYSTEM), ETC. FOR A COMPLETE OPERATING SYSTEM.
2.5. INSTALL WALK-IN FREEZER AND WALK-IN COOLER EQUIPMENT PER MANUFACTURER'S RECOMMENDATIONS, CURRENT CODE. CONNECT AND RUN EQUIPMENT.
2.6. TEST ALL EQUIPMENT AND PROVIDE A STATEMENT/REPORT OF EQUIPMENT FUNCTION.

CONTRACTOR'S MEANS AND METHODS

1. THE CONTRACTOR IS RESPONSIBLE FOR MEANS AND METHODS TO PERFORM THE SCOPE OF WORK INDICATED/IMPLIED ON THE CONSTRUCTION DOCUMENTS.
2. MEANS AND METHODS SHALL BE DEFINED AS THE CONTRACTOR'S SELECTED CHOICE DESCRIBING TECHNIQUES AND TACTICS TO COMPLETE THE WORK REQUIRED FOR A FINISHED PROJECT.
3. THE CONTRACTOR SHALL PROVIDE THE APPROPRIATE MATERIALS, EQUIPMENT, TOOLS AND/OR SERVICES TO COMPLETE THE WORK SHOWN ON THE CONTRACT DOCUMENTS IN A MANNER THAT IS ACCEPTED AS "INDUSTRY STANDARDS" IN THE AREA OF PROPOSED WORK.
4. THE CONTRACTOR SHALL EMPLOY THE APPROPRIATE TECHNICIANS, SKILLED WORKFORCE, TRADESMEN, AND MANAGEMENT TO COMPLETE THE WORK SHOWN ON THE CONTRACT DOCUMENTS IN A MANNER THAT IS ACCEPTED AS "INDUSTRY STANDARDS" IN THE AREA OF PROPOSED WORK.
5. CONTRACTORS AND SUBCONTRACTORS SHALL BE LICENSED FOR THE TYPE OF WORK THEY ARE PERFORMING, AND/OR AS OUTLINED IN THE GENERAL REQUIREMENTS.
6. IF THE CONTRACTOR REQUIRES A PROFESSIONAL ENGINEER FOR DETAILING OR CALCULATIONS FOR TEMPORARY WORK (MEANS AND METHODS), IT WILL BE UNDER THE CONTRACTOR'S SCOPE OF WORK AND INCLUDED IN THE CONSTRUCTION BID PRICE.

OCCUPANCY DURING CONSTRUCTION

1. TOWN OF YUCCA VALLEY WILL NOT OCCUPY THE BUILDING DURING CONSTRUCTION.
2. THE CONTRACTOR IS TO COORDINATE TEMPORARY UTILITY DISRUPTION A MIN. OF 2 DAYS PRIOR TO ANY DISRUPTION.
3. LIFE SAFETY AND EXITING SHALL BE OBSERVED DURING CONSTRUCTION.
4. DUST AND VOC CONTROL SHALL BE OBSERVED DURING CONSTRUCTION.
5. CLEANING SHALL OCCUR DURING CONSTRUCTION AND PRIOR TO SUBSTANTIAL COMPLETION, AND SHALL INCLUDE AREAS ADJACENT TO THE KITCHEN AREAS.

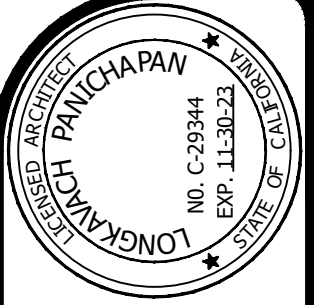

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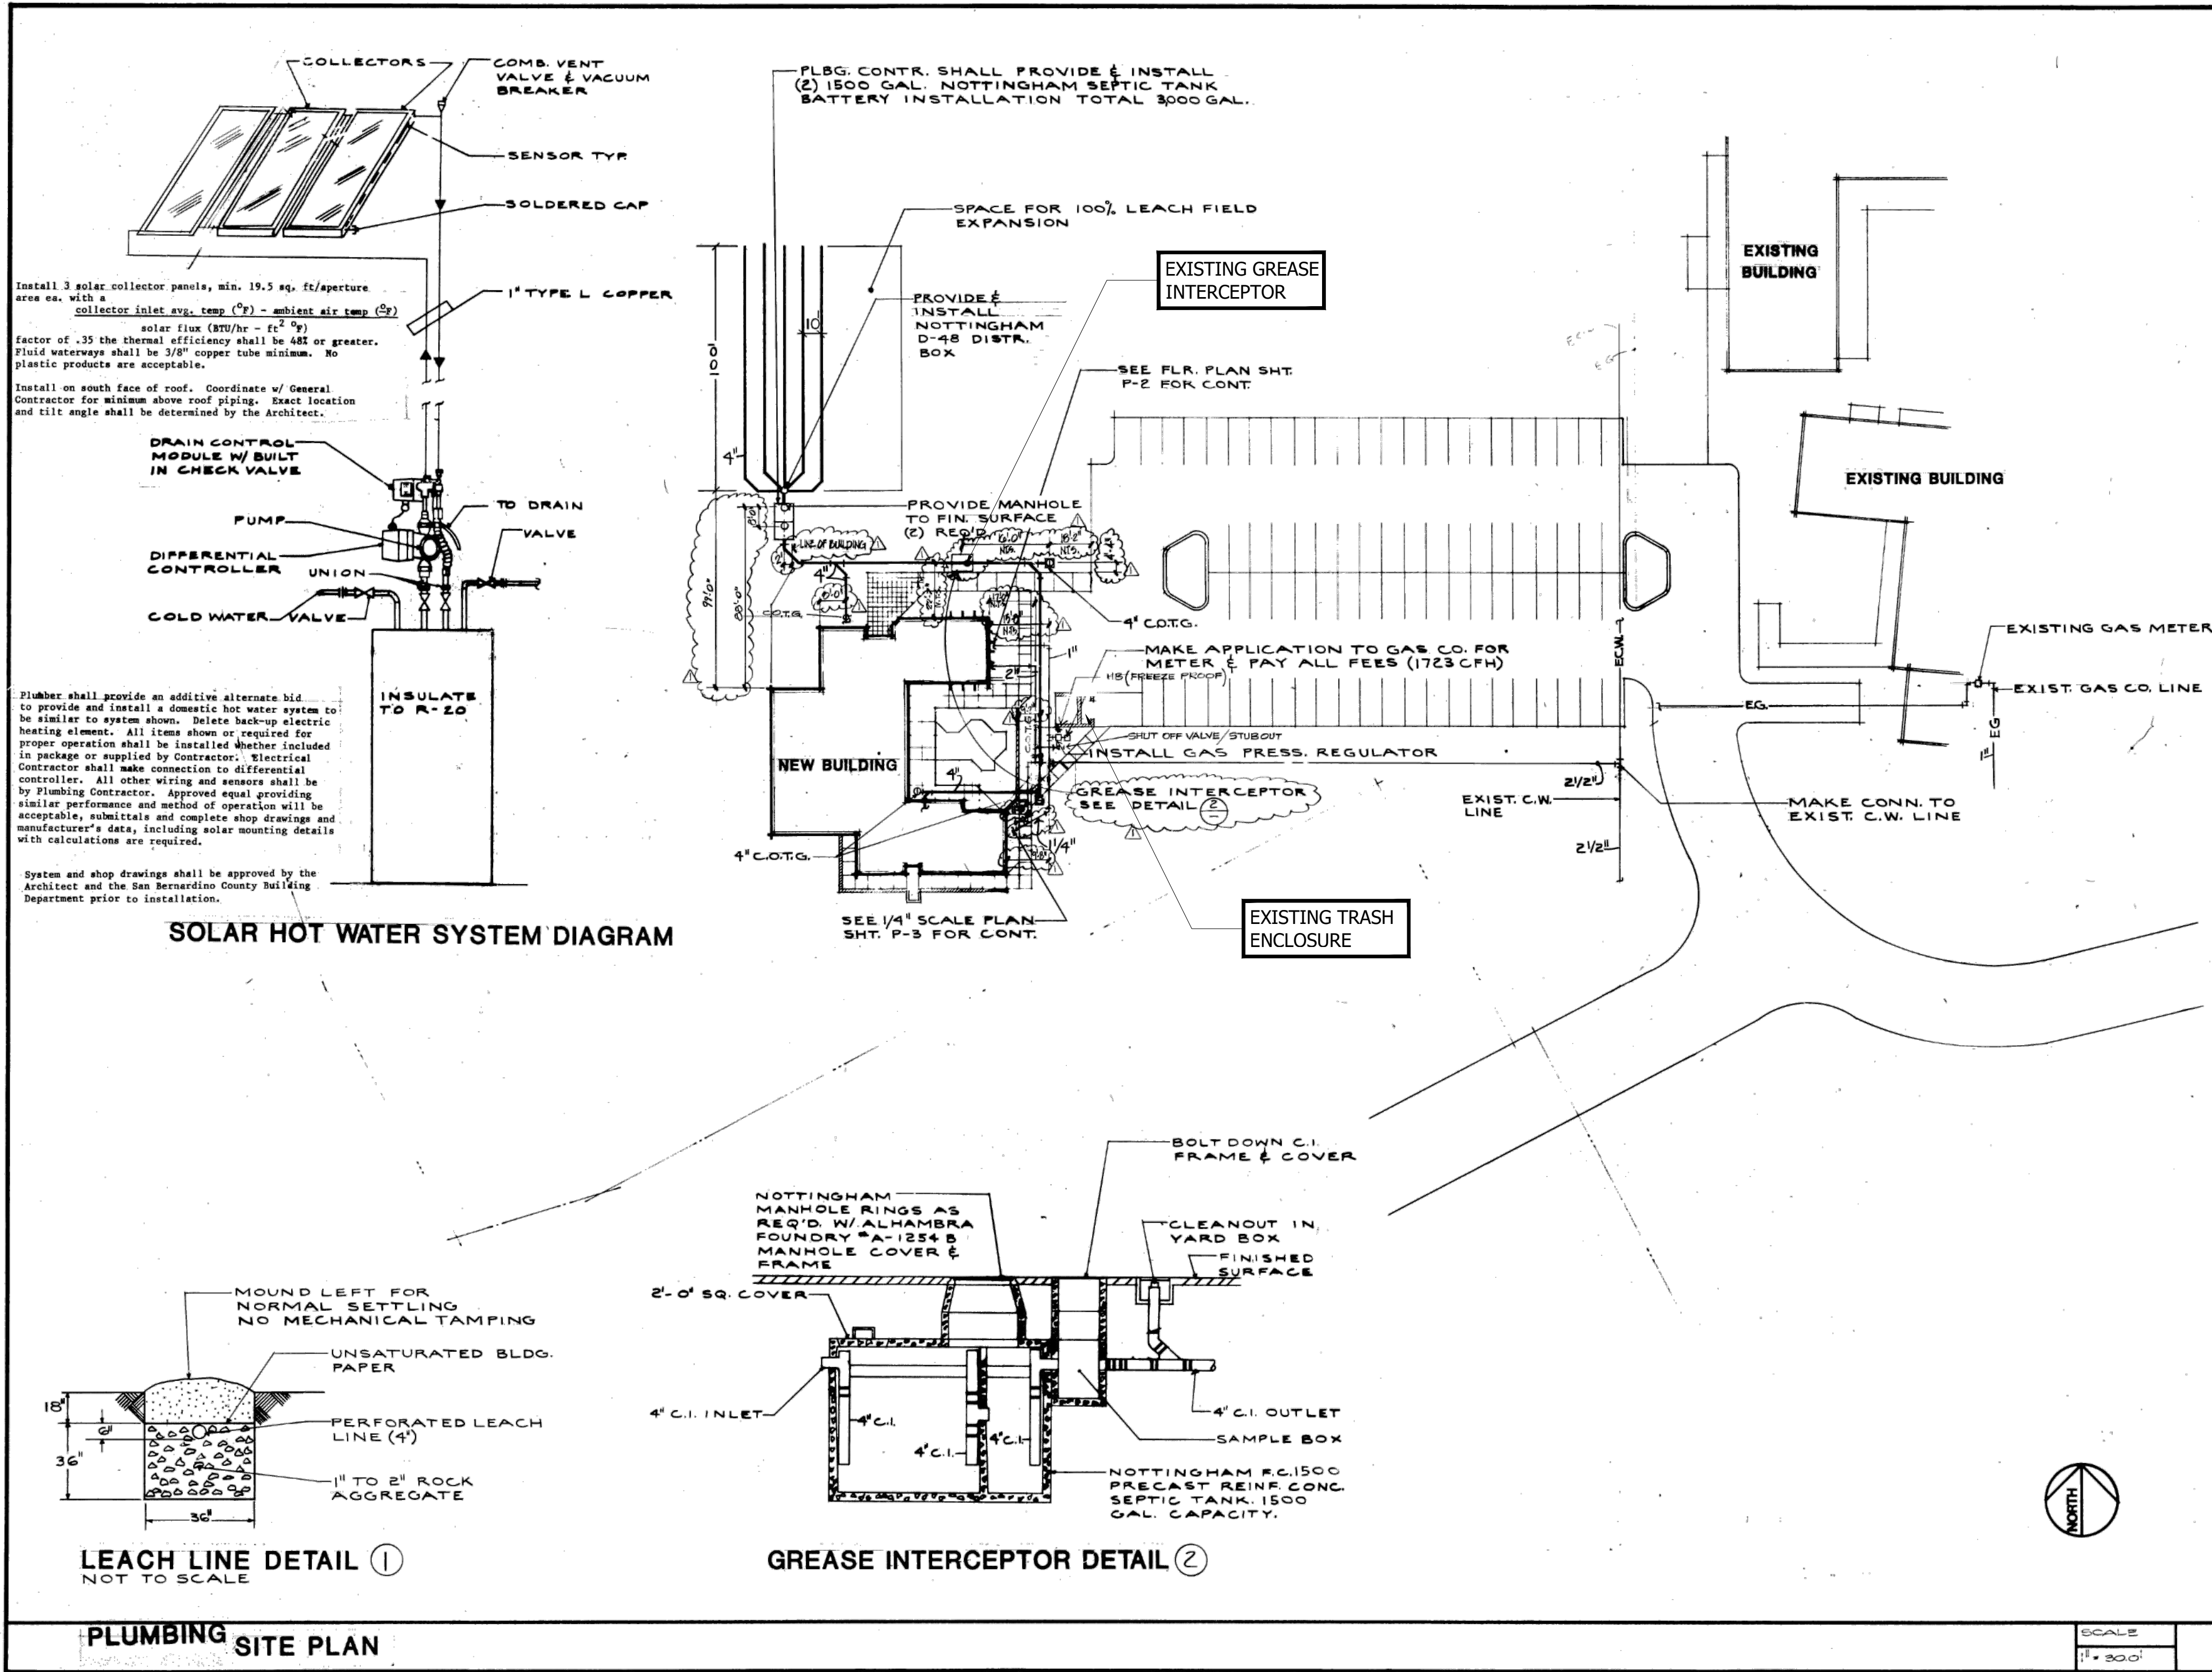
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CONSTRUCTION SET

Table with 2 columns: Field and Value. Includes Date: 01/13/2022, Job No.: 4107, Drawn By: STAFF, Checked By: LP, Scale: 1/8" = 1'-0".

TITLE SHEET

TOWN OF YUCCA VALLEY Senior Center - Kitchen Equipment Upgrades



**B. BARMAKIAN
WOLFF*LANG
CHRISTOPHER
ARCHITECTS**

101 ARCHCENTER 8075 ARCHBOLD RANCHO CUCAMONGA CALIFORNIA 91730 714-987-0909



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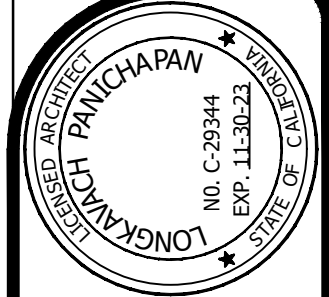
NO.	DATE BY REVISION	REMARKS
1	9-24-81	RELEASO DRAWING

PLUMBING SITE PLAN
DRAWN
CHECKED
DATE 9-24-81
SCALE 1"=300'
JOB NO. B.024



SCALE
1"=300'

FOR REFERENCE ONLY



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CONSTRUCTION SET

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SITE PLAN

TOWN OF YUCCA VALLEY
Senior Center - Kitchen Equipment Upgrades

A-1.1

LEGEND:

	EXISTING WALL TO REMAIN
	EXISTING WALL/DOOR TO BE REMOVED
	EXISTING DOOR TO REMAIN
	EXISTING DOOR TO BE REMOVED



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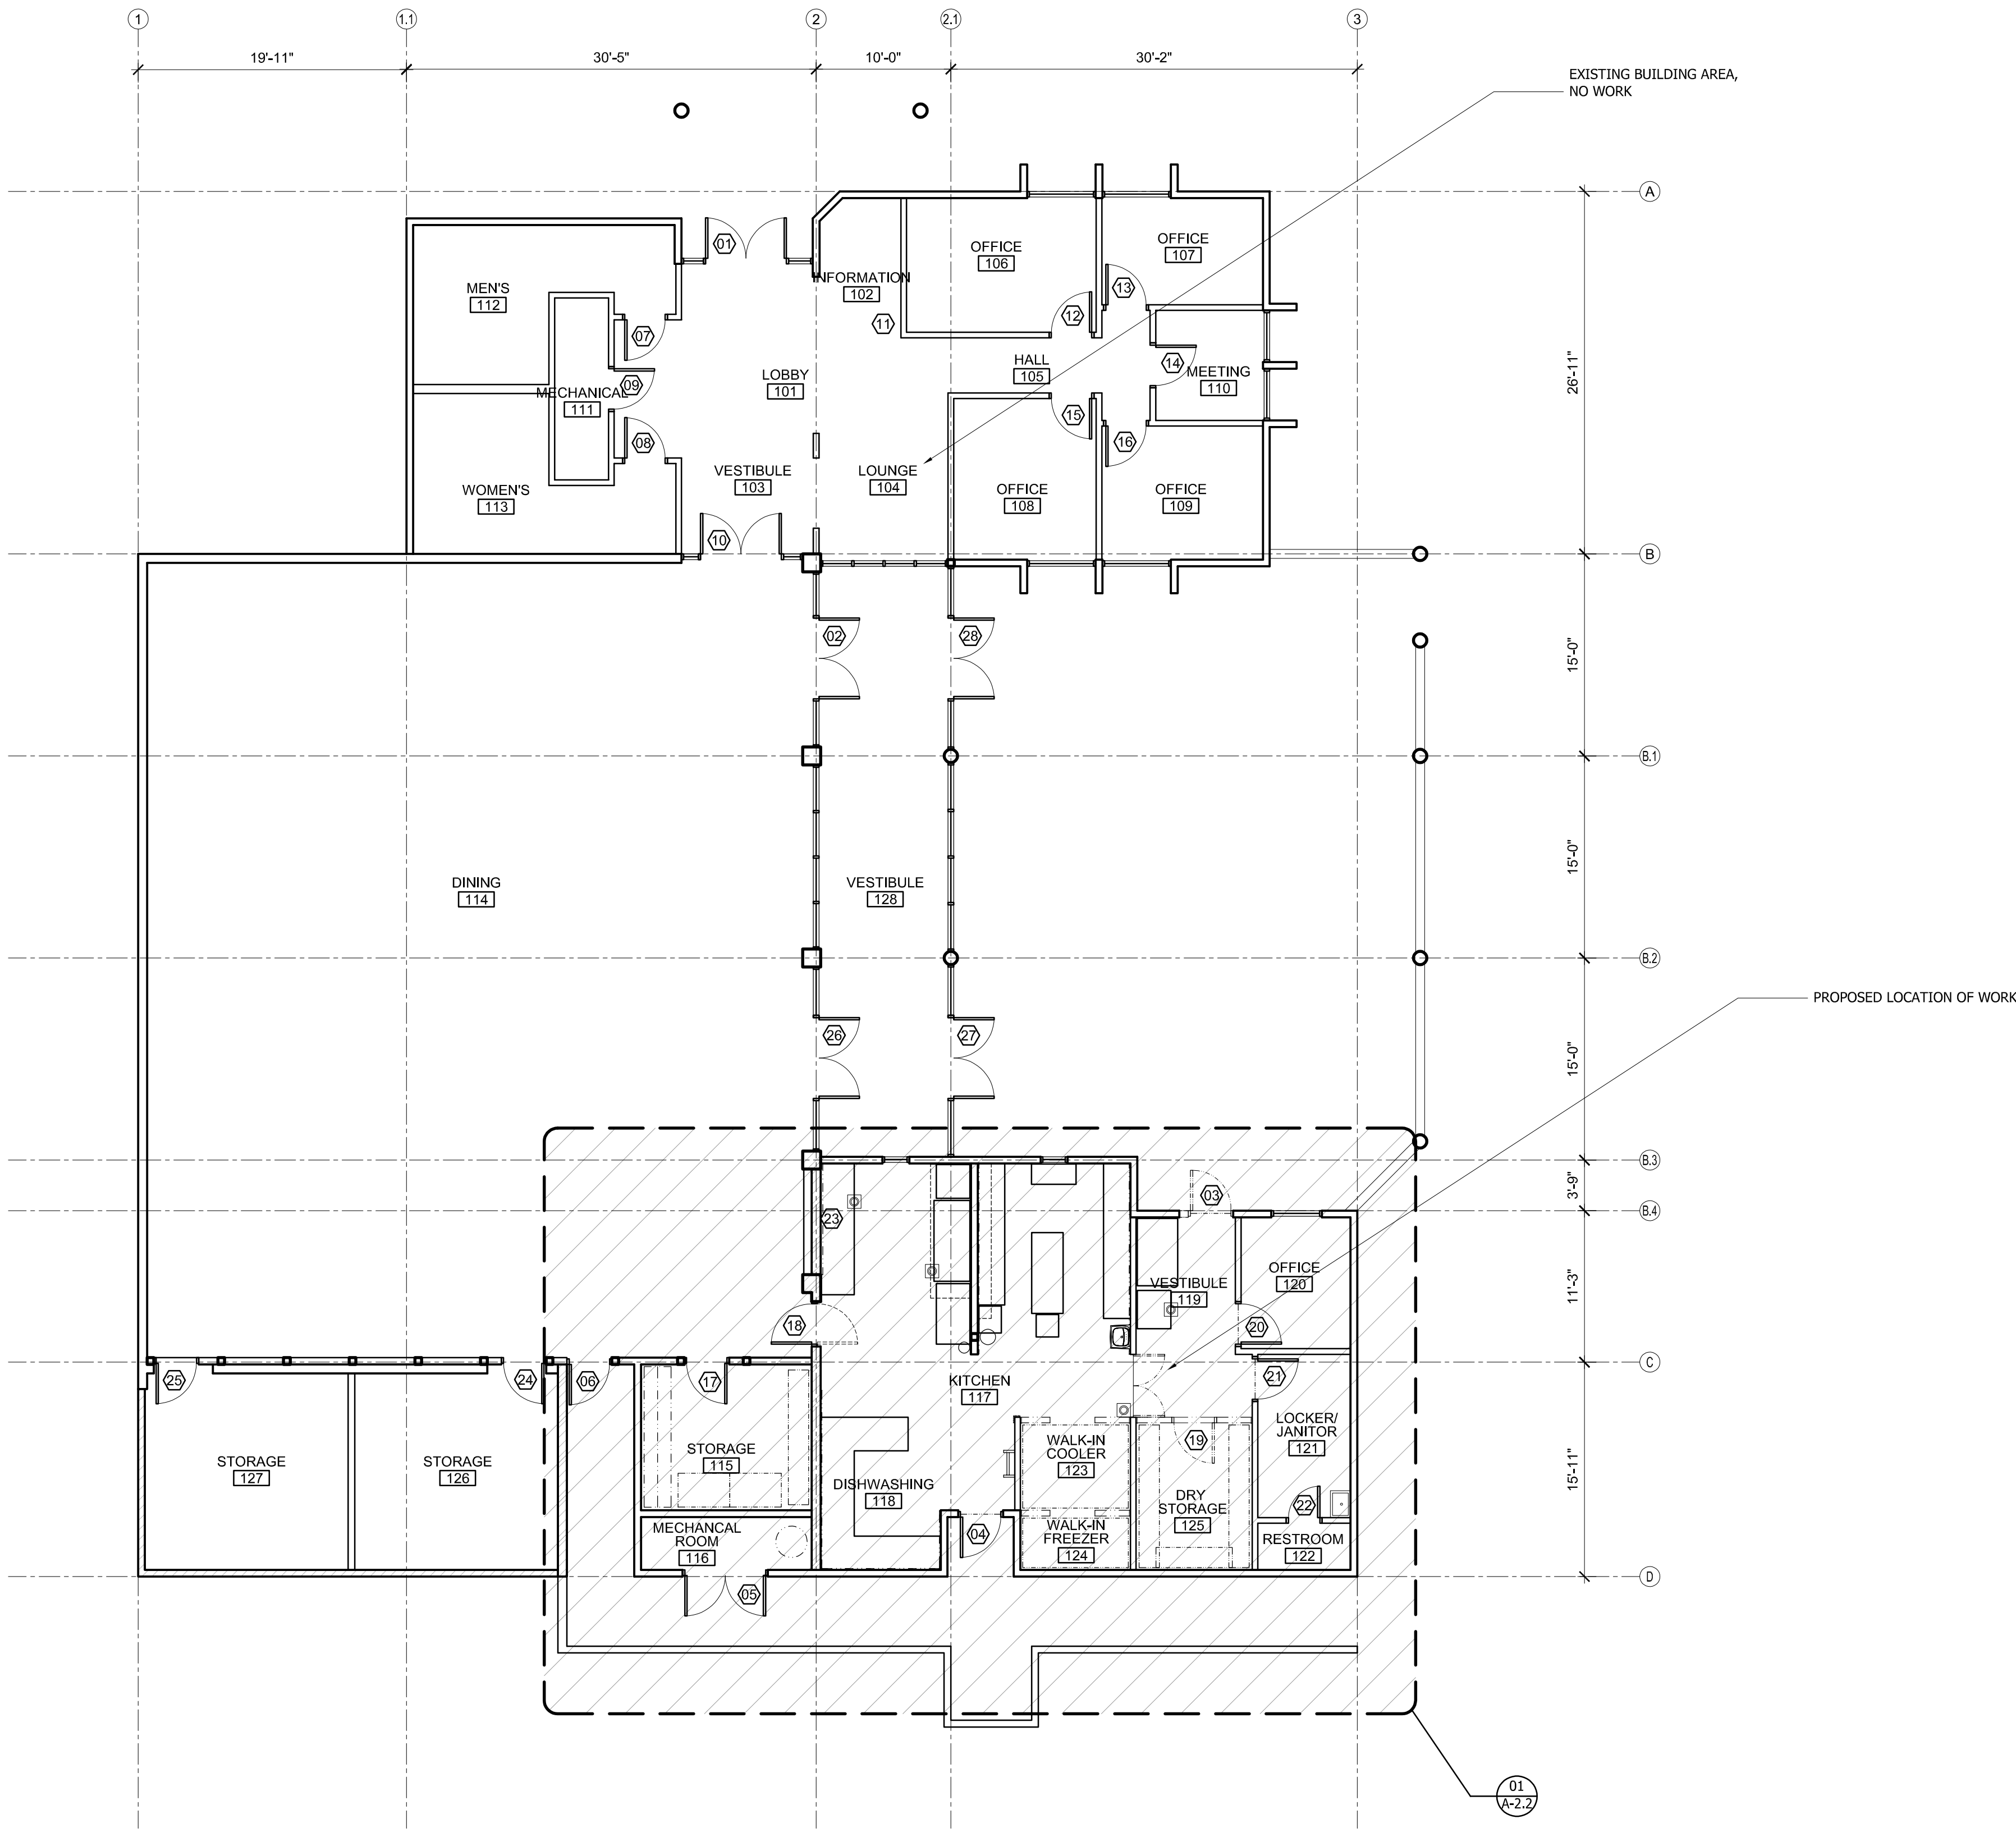
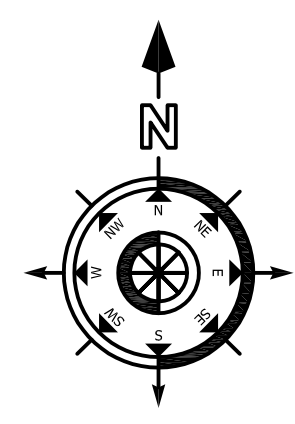
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SCALE: 1/8" = 1'-0"

FLOOR PLAN - OVERALL EXISTING
TOWN OF YUCCA VALLEY
Senior Center - Kitchen Equipment Upgrades

A-2.1



01 FLOOR PLAN - OVERALL EXISTING
A-2.1 Scale: 1/8" = 1'-0"

KEYNOTES:

- 01 REMOVE EXISTING STAINLESS STEEL COUNTERTOP
- 02 REMOVE EXISTING OVERHEAD COILING DOOR
- 03 REMOVE (1) ONE COURSE OF 8" CMU BLOCK @ PASS-THROUGH
- 04 CLEAN EXISTING CONCRETE FLOOR. PREP, ABRABE, GRIND AS REQUIRED BY NEW FLOORING MANUFACTURER
- 05 FIRE SUPPRESSION SYSTEM TO REMAIN, PROTECT IN-PLACE
- 06 REMOVE EXISTING BASE, TYPICAL
- 07 EXISTING FINISH TO REMAIN, PROTECT IN-PLACE
- 08 REMOVE ALL FLOOR FINISHES/BASE
- 09 REMOVE AND REPLACE ALUMINUM THRESHOLD
- 10 REMOVE AND REPLACE THRESHOLD
- 11 EXISTING DOOR AND FRAME TO BE REMOVED


- 12 EXISTING GYPSUM BOARD WALL TO BE REMOVED
- 13 EXISTING CASEWORK AND SHELF TO BE REMOVED. PATCH AND REPAIR WALL
- 14 EXISTING ROOF ACCESS LADDER TO REMAIN, PROTECT IN-PLACE
- 15 EXISTING FLOOR SINK TO REMAIN, PROTECT IN-PLACE, TYPICAL
- 16 EXISTING LAVATORY SINK TO REMAIN, PROTECT IN-PLACE
- 17 EXISTING WATER HEATER TO BE REMOVED AND REPLACED
- 18 EXISTING TOPPING SLAB AND RIGID INSULATION TO BE REMOVED, SEE DETAIL 11 & 13 ON SHEET A-7.2
- 19 EXISTING S.S. WALL PANEL TO REMAIN, PROTECT IN-PLACE

- 20 EXISTING METAL GATE TO BE REMOVED, PATCH AND REPAIR WALL
- 21 EXISTING BEARING/SHEAR WALL AND FOOTING TO REMAIN, PROTECT IN-PLACE
- 22 PATCH & REPAIR WALL. INSTALL GYPSUM BOARD, PRIME AND PAINT
- 23 CLEAN, PATCH, GRIND & REPAIR EXISTING CONCRETE FLOOR TO RECEIVE NEW WALK-IN EQUIPMENT AND FLOOR FINISH.
- 24 EXISTING SERVICE SINK TO REMAIN, PROTECT IN-PLACE
- 25 REMOVE EXISTING WALL COVERING (TILE/FRP), PREP AND PRIME WALLS PRIOR TO INSTALLING NEW FRP SYSTEM
- 26 TEMPORARILY AND CAREFULLY REMOVE EXISTING DOOR AND FRAME. STORE IN PROTECTED LOCATION PRIOR TO RE-INSTALLATION


LEGEND:

- EXISTING WALL TO REMAIN
- EXISTING CMU WALL TO REMAIN
- EXISTING WALL/DOOR TO BE REMOVED
- DOOR TO REMAIN/TO BE ALTERED, SEE SHEET A-5.1 FOR ADDITIONAL INFO
- EXISTING DOOR TO BE REMOVED

NOTE:
SEE SHEET A-2.4 FOR EXISTING FURNITURE TO BE TEMPORARILY REMOVED/RE-INSTALLED

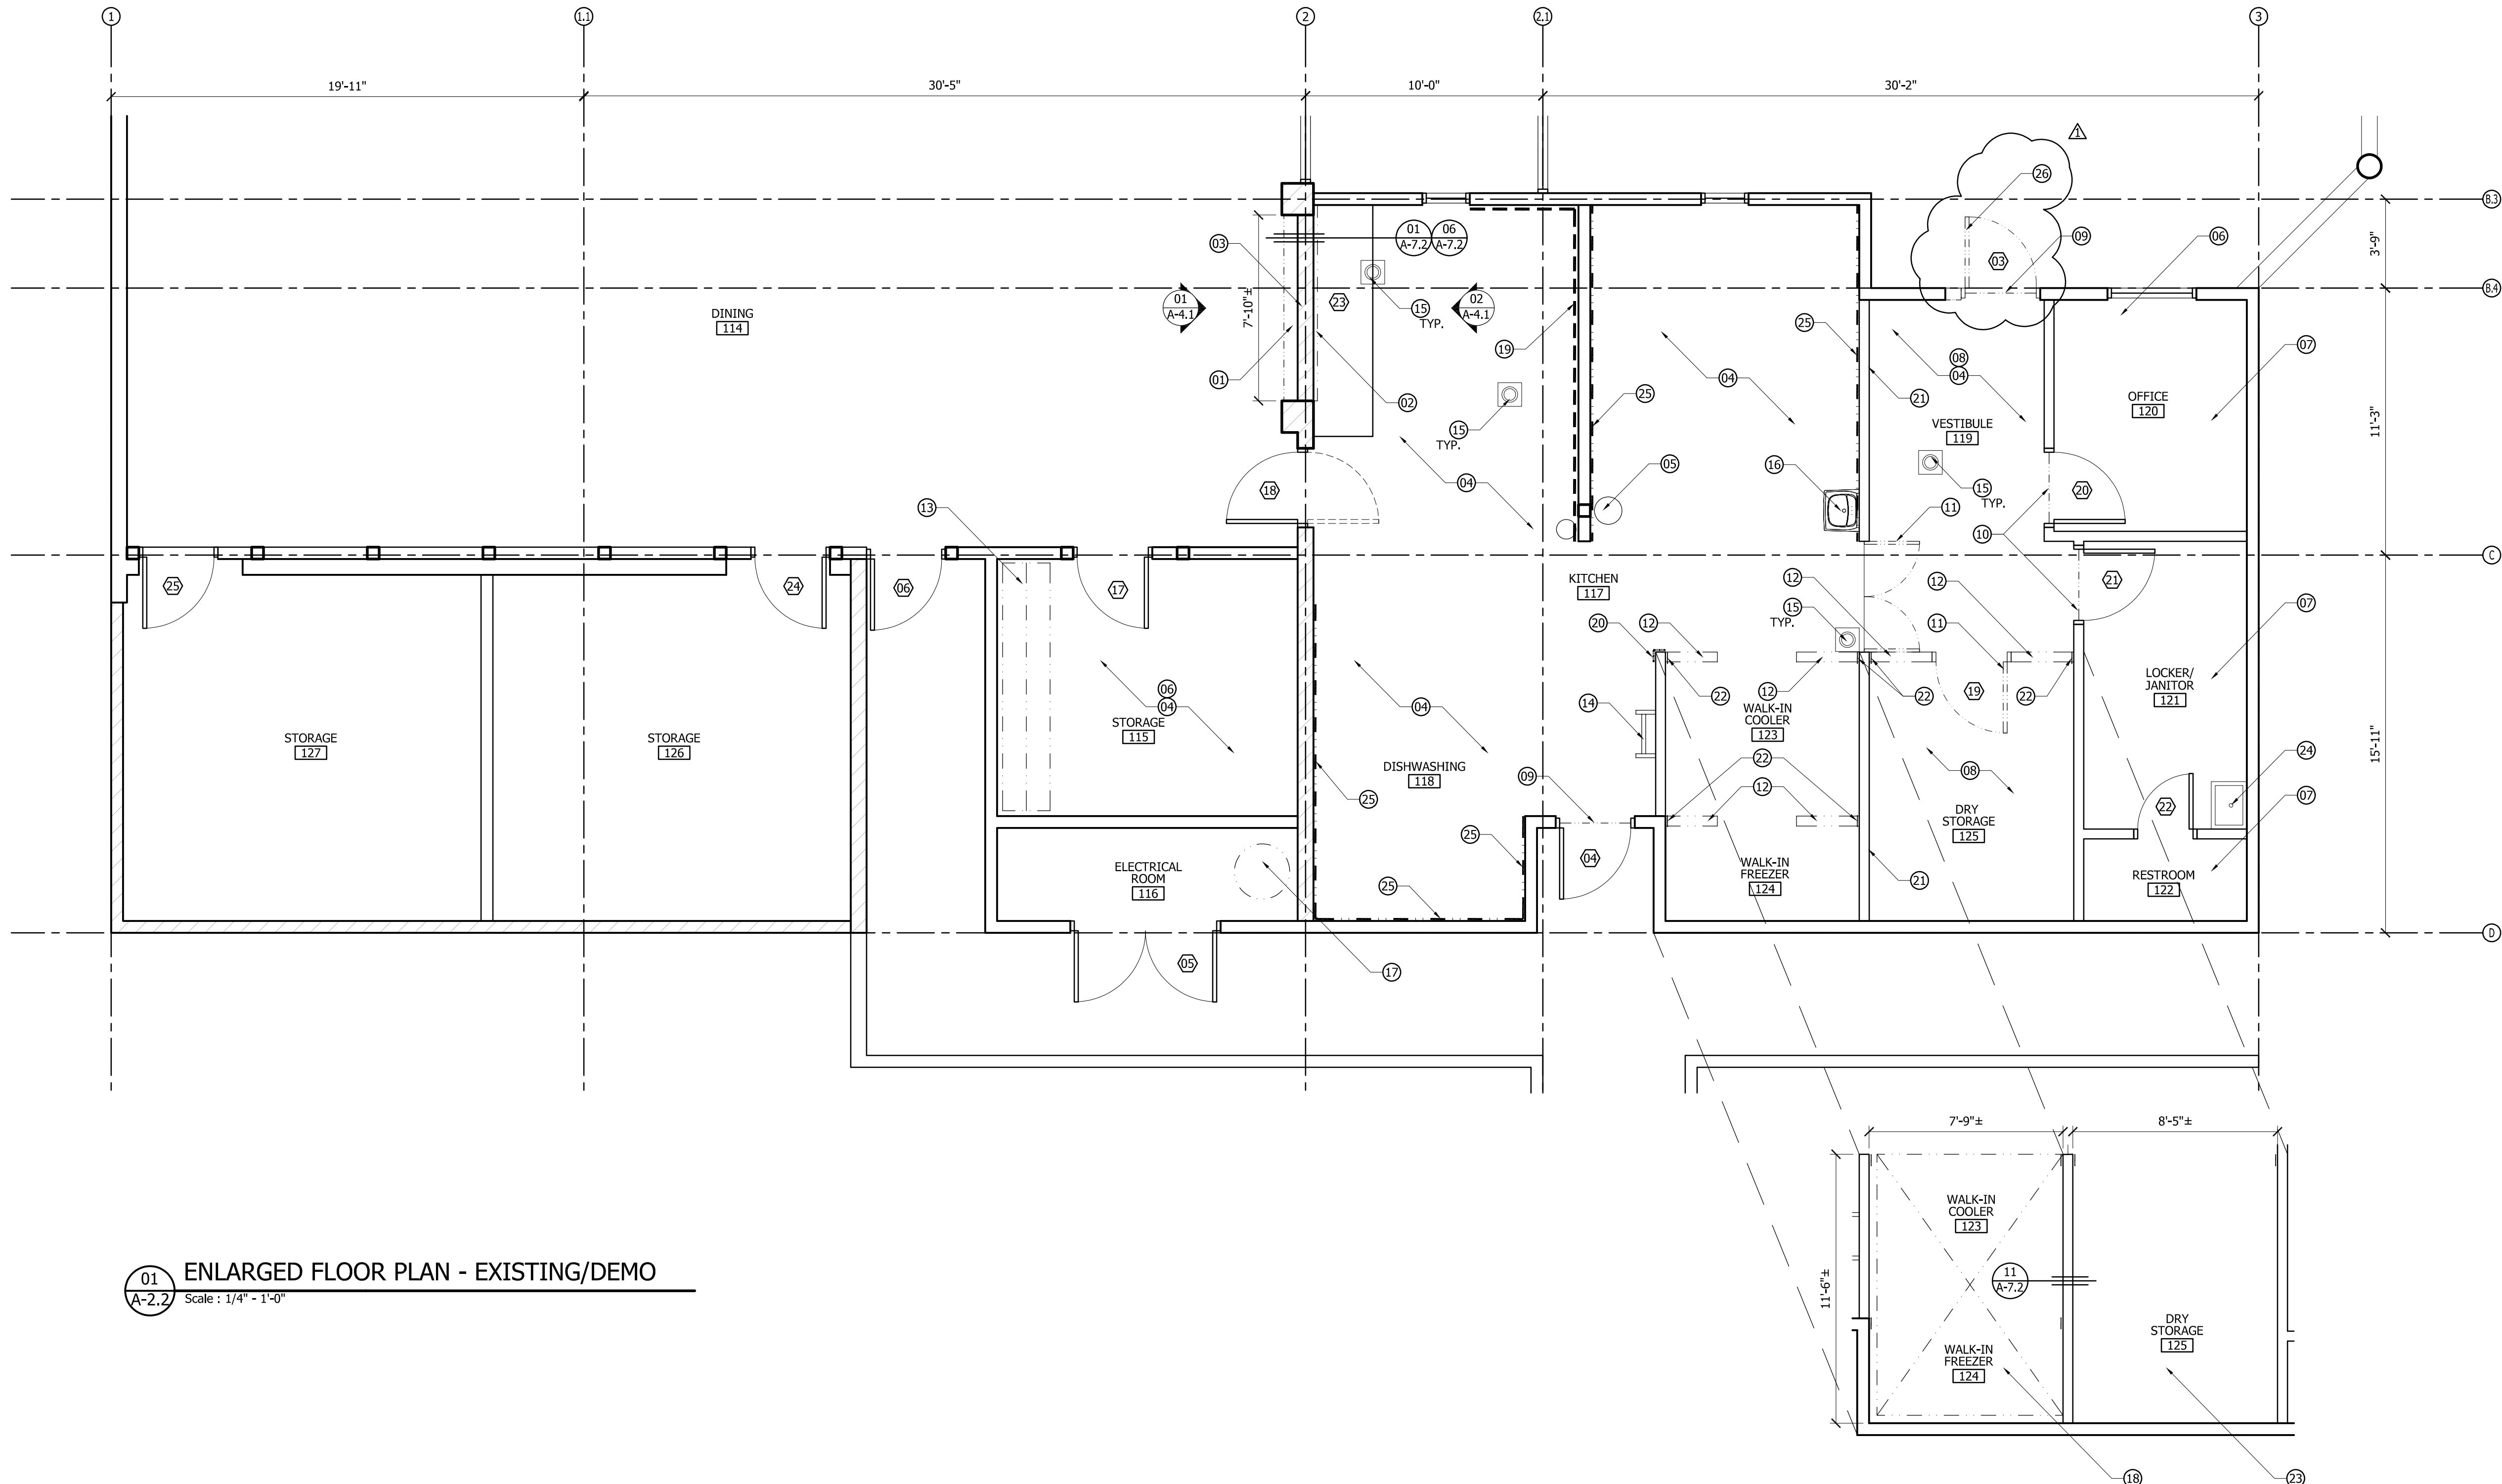

01 ENLARGED FLOOR PLAN - EXISTING/DEMO
A-2.2 Scale: 1/4" = 1'-0"

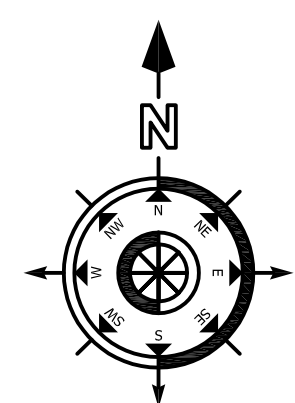

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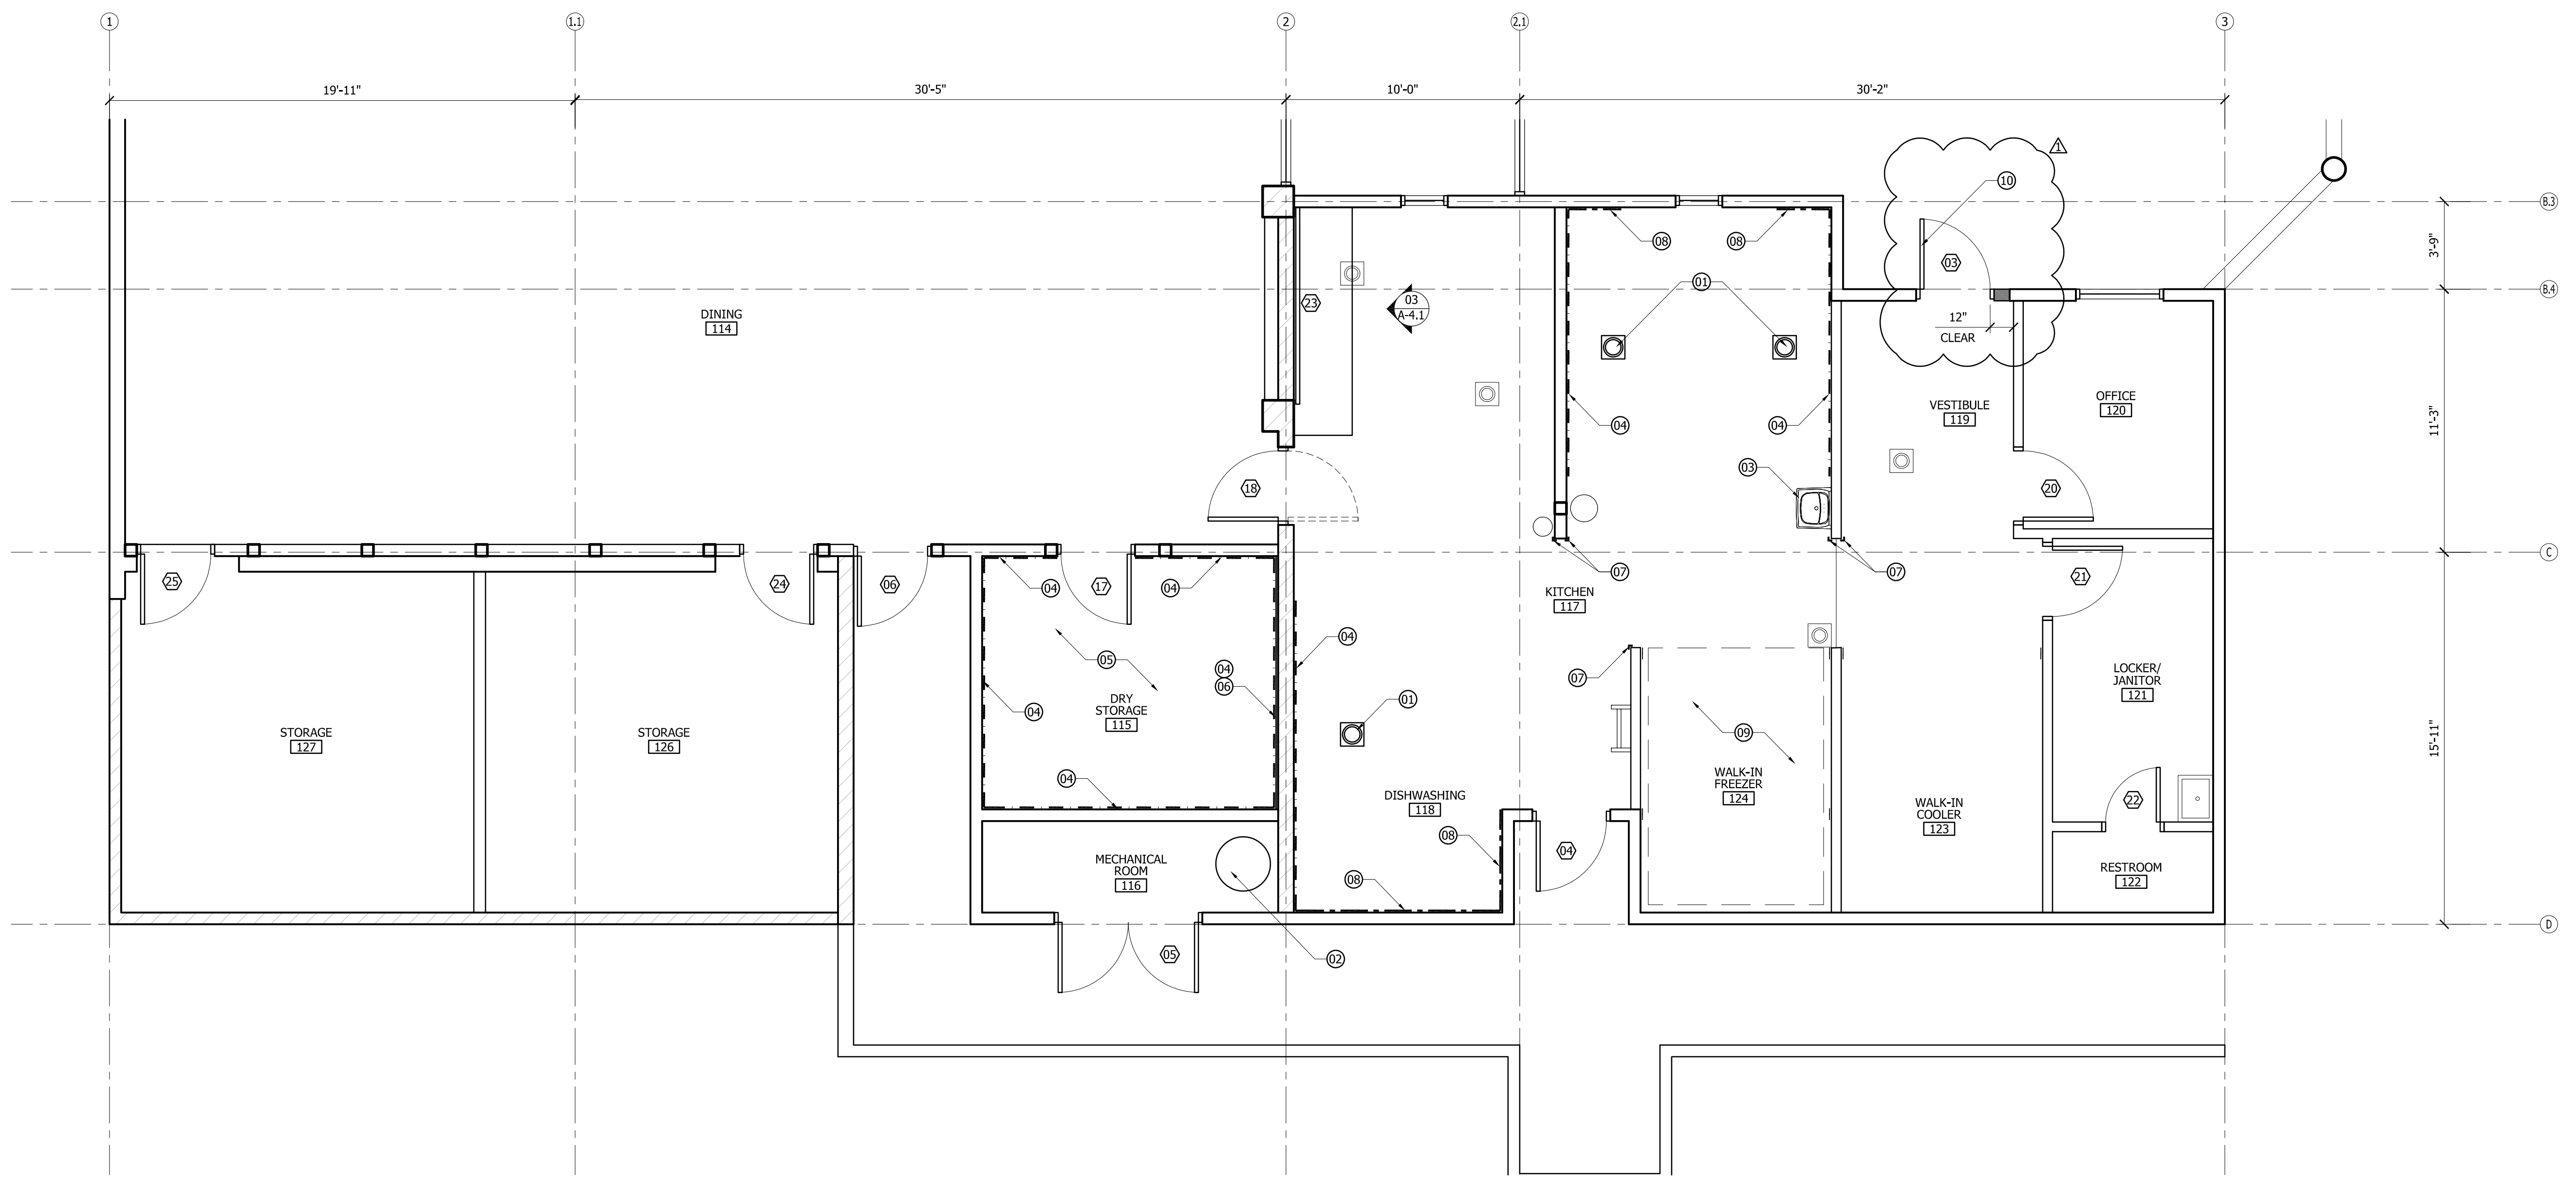
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ENLARGED FLOOR PLAN - EX./DEMO
TOWN OF YUCCA VALLEY
Senior Center - Kitchen Equipment Upgrades


- KEYNOTES:**
- 01 NEW FLOOR SINK, SEE PLUMBING DRAWINGS. COORDINATE LOCATION WITH EXISTING SINKS AND DRAINS (AND NEW WASTE LINES @ EACH PLUMBING FIXTURES)
 - 02 NEW WATER HEATER, SEE MECHANICAL DRAWINGS
 - 03 PROVIDE AND INSTALL NEW DRAIN PIPE INSULATION (TRUBRO, MOLDED VINYL TRAP/P-TRAP, AND VALVE COVERS OR APPROVED EQUAL)
 - 04 NEW FULL HEIGHT FRP PANEL (TYPICAL)
 - 05 NEW COVED BASE, SEE FINISH FLOOR PLANS A-5.1
 - 06 NEW 1/2" RIGID POLYISO INSULATION Z-CHANNELS AND NEW 5/8" GYPSUM BOARD @ EXISTING EXPOSED CMU WALL (PRIME NEW GYPSUM BOARD TO RECEIVE FRP SYSTEM)
 - 07 NEW 2" X 2" X 18 GA. (48") STAINLESS STEEL CORNER GUARDS
 - 08 NEW FRP PANELING FROM TOP OF COVED BASE TO 4'-6" A.F.F.
 - 09 NEW INFILL RECESSED CONCRETE TOPPING SLAB, SEE DETAIL 13/A-7.2
 - 10 RE-INSTALL EXISTING DOOR (SHIFT TO WEST APPROXIMATELY 8")

LEGEND:

	EXISTING WALL TO REMAIN
	EXISTING CMU WALL TO REMAIN
	NEW GYPSUM BOARD FURRED WALL
	SEE SHEET A-5.1 FOR DOOR SCHEDULE
	NEW FULL HEIGHT FRP PANELS
	NEW FRP PANELS, 4'-6" A.F.F.



01 ENLARGED FLOOR PLAN - PROPOSED
 A-2.3 Scale: 1/4" = 1'-0"

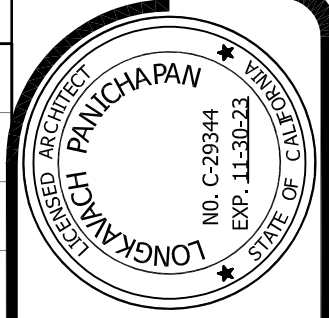

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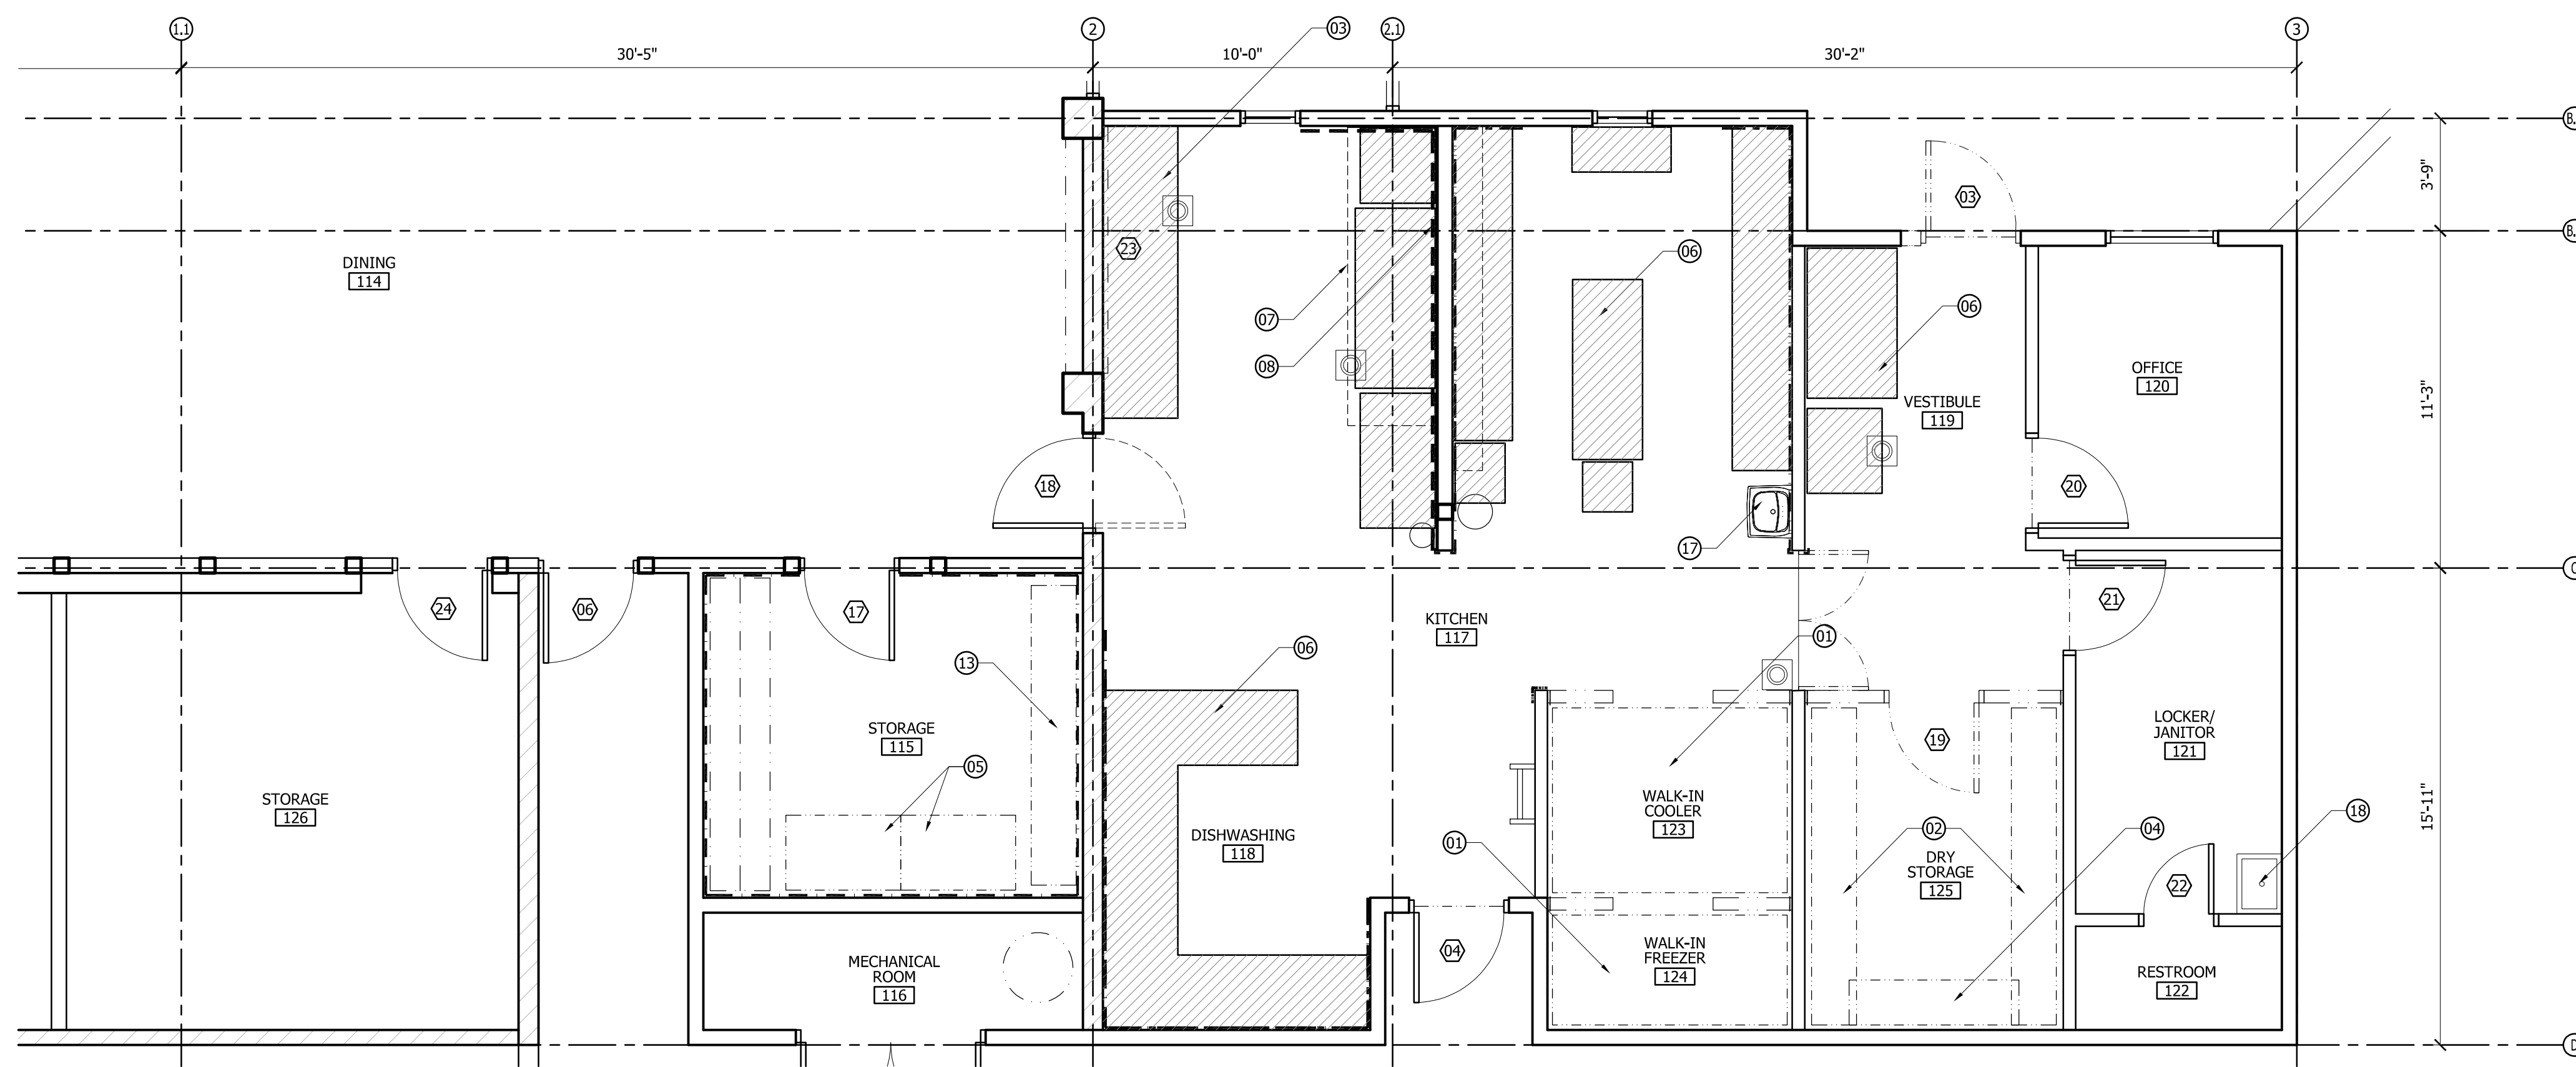
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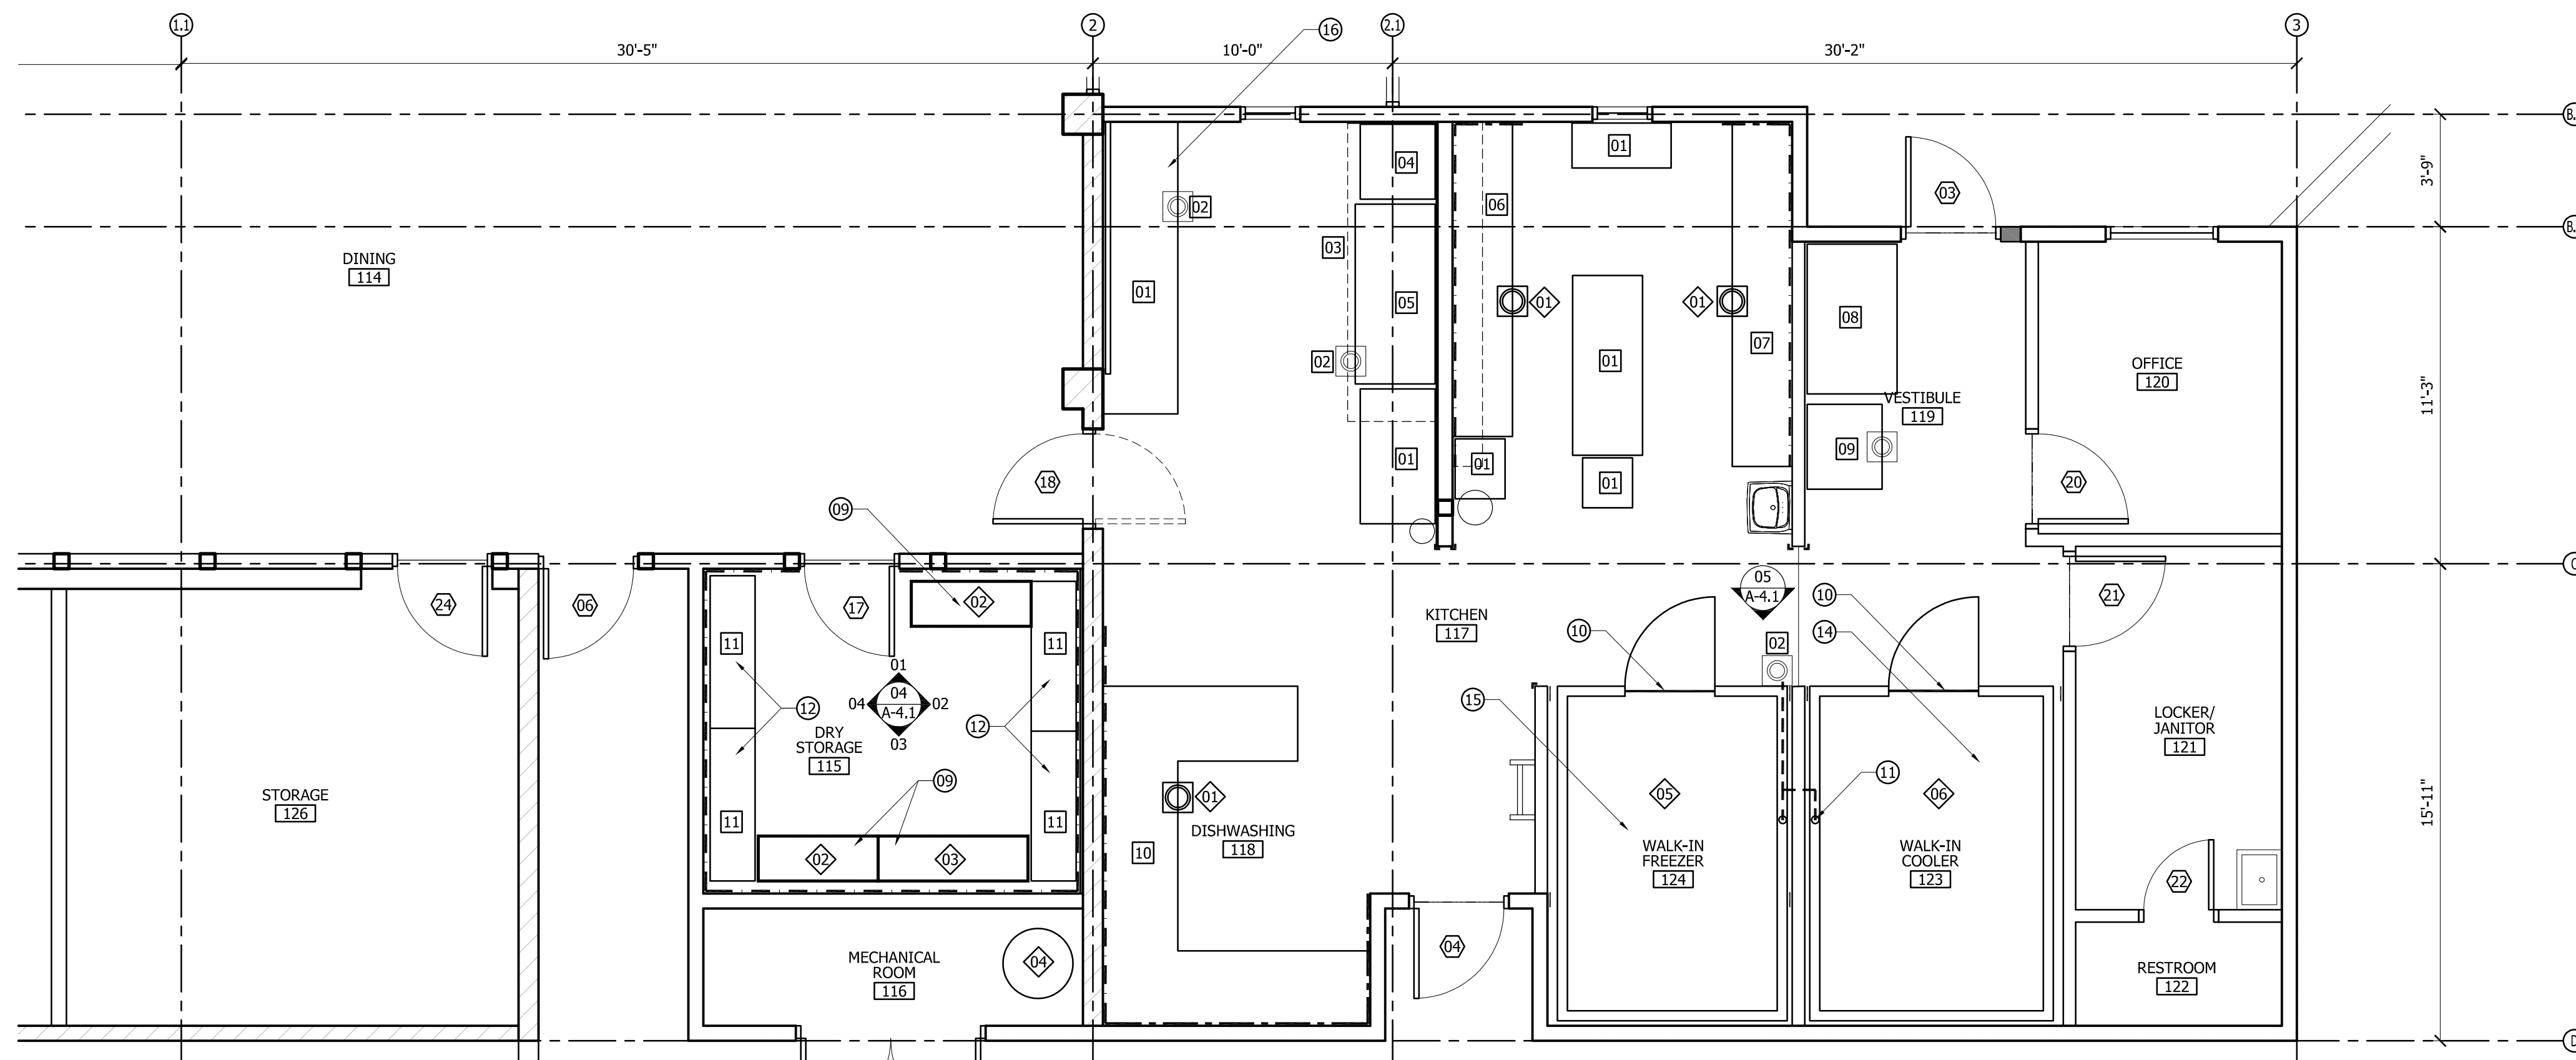
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ENLARGED FLOOR PLAN - PROPOSED
TOWN OF YUCCA VALLEY
 Senior Center - Kitchen Equipment Upgrades



01 ENLARGED EQUIPMENT PLAN - EXISTING/DEMO
A-2.4 Scale: 1/4" = 1'-0"



02 ENLARGED EQUIPMENT PLAN - PROPOSED
A-2.4 Scale: 1/4" = 1'-0"

EXISTING FURNITURE/EQUIPMENT:

1. PRIOR TO REMOVING ANY EQUIPMENT, CONTRACTOR IS TO PHOTOGRAPH EXACT LOCATION AND LAYOUT OF EQUIPMENT.
2. CAREFULLY AND TEMPORARILY REMOVE THE EXISTING EQUIPMENT AS SHOWN AND AS NEEDED TO FACILITATE THE INSTALLATION OF THE NEW FLOORING AND COVERED BASE.
3. PROTECT WHILE STORED. LOCATION OF TEMPORARY STORAGE TO BE COORDINATED WITH OWNER.
4. AFTER ALL FINISHES ARE INSTALLED AND DRY/CURED, INSTALL/REPLACE EQUIPMENT BACK TO ORIGINAL LOCATION.

KEYNOTES:

- 01 EXISTING EQUIPMENT TO BE REMOVED
- 02 EXISTING SHELVING RACKS TO BE REMOVED, RELOCATED TO NEW DRY STORAGE ROOM 115
- 03 EXISTING S.S. COUNTER TO BE REMOVED, MODIFIED/ADJUSTED
- 04 EXISTING WOOD SHELVING TO BE REMOVED
- 05 REMOVE AND RELOCATE EXISTING EQUIPMENT (PER OWNER)
- 06 TEMPORARILY REMOVE AND RE-INSTALL EQUIPMENT (TYP.)
- 07 EXISTING HOOD TO REMAIN, PROTECT IN-PLACE (CLEAN OUTSIDE)
- 08 EXISTING STAINLESS STEEL PANEL WALL TO REMAIN (CLEAN)
- 09 NEW STAINLESS STEEL RACK SHELVING (BY OTHERS)
- 10 PROVIDE AND INSTALL NEW STAINLESS STEEL THRESHOLD PLATE @ EACH DOOR
- 11 NEW COPPER/INSULATED CONDENSATE DRAIN TO AIR GAP AT FLOOR DRAIN
- 12 RELOCATED STORAGE RACKS
- 13 EXISTING SHELVING RACKS TO BE REMOVED, RELOCATION TO BE DETERMINED BY OWNER
- 14 NEW WALK-IN REFRIGERATOR
- 15 NEW WALK-IN FREEZER
- 16 RE-INSTALL MODIFIED S.S. COUNTER
- 17 EXISTING LAVATORY SINK
- 18 EXISTING SERVICE SINK

LEGEND:

- EXISTING WALL TO REMAIN
- EXISTING CMU WALL TO REMAIN
- NEW GYPSUM BOARD FURRED WALL
- SEE SHEET A-5.1 FOR DOOR SCHEDULE

*** CONTRACTOR TO REPLACE EXISTING SINK WASTE DRAIN LINE AND PROVIDE NEW AND RE-ROUTE TO AIR GAP AT NEW FLOOR SINK. SEE DETAIL 3/P-0.2. CAP WALL SEWER LINE

EXISTING EQUIPMENT:



- | | |
|----|-----------------------------------|
| 01 | STAINLESS STEEL TABLE/COUNTER |
| 02 | FLOOR SINK |
| 03 | HOOD |
| 04 | OVEN |
| 05 | OVEN/RANGE |
| 06 | 2 COMPARTMENT SINK *** |
| 07 | 3 COMPARTMENT SINK *** |
| 08 | DRINK COOLER |
| 09 | ICE MAKER |
| 10 | COMMERCIAL DISHWASHER MACHINE *** |
| 11 | STAINLESS STEEL STORAGE RACK |

NEW EQUIPMENT:

- | | |
|----|--|
| 01 | FLOOR SINK - ZURN #1900-25 SANI-FLOOR RECEPTOR |
| 02 | 4' STAINLESS STEEL STORAGE RACK - REGENCY MODEL NO. 460SW1848KIT |
| 03 | 5' STAINLESS STEEL STORAGE RACK - REGENCY MODEL NO. 460SW1860KIT |
| 04 | WATER HEATER - A.O. SMITH BTH-199 |
| 05 | WALK-IN FREEZER - U.S. COOLER, |
| 06 | WALK-IN COOLER - U.S. COOLER, |

FINISHES:

- DRY STORAGE 115:
- WALLS - FRP (NEW)
 - CEILING - DRYWALL (EXISTING W/ NEW SEMI-GLOSS PAINT)
 - FLOOR - EPOXY COATING SYSTEM AND COVERED BASE (NEW)
- KITCHEN 117, DISHWASHING 118, & VESTIBULE 119:
- WALLS - TILE (EXISTING)
 - STAINLESS STEEL (EXISTING)
 - DRYWALL (EXISTING W/ NEW SEMI-GLOSS PAINT)
 - CEILING - DRYWALL (EXISTING W/ NEW SEMI-GLOSS PAINT)
 - FLOOR - EPOXY COATING SYSTEM AND COVERED BASE (NEW)

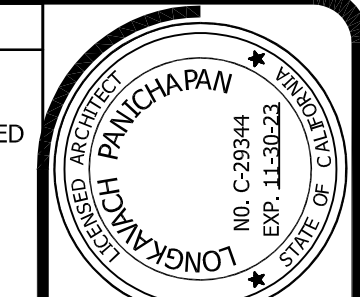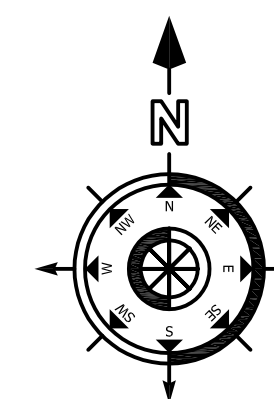


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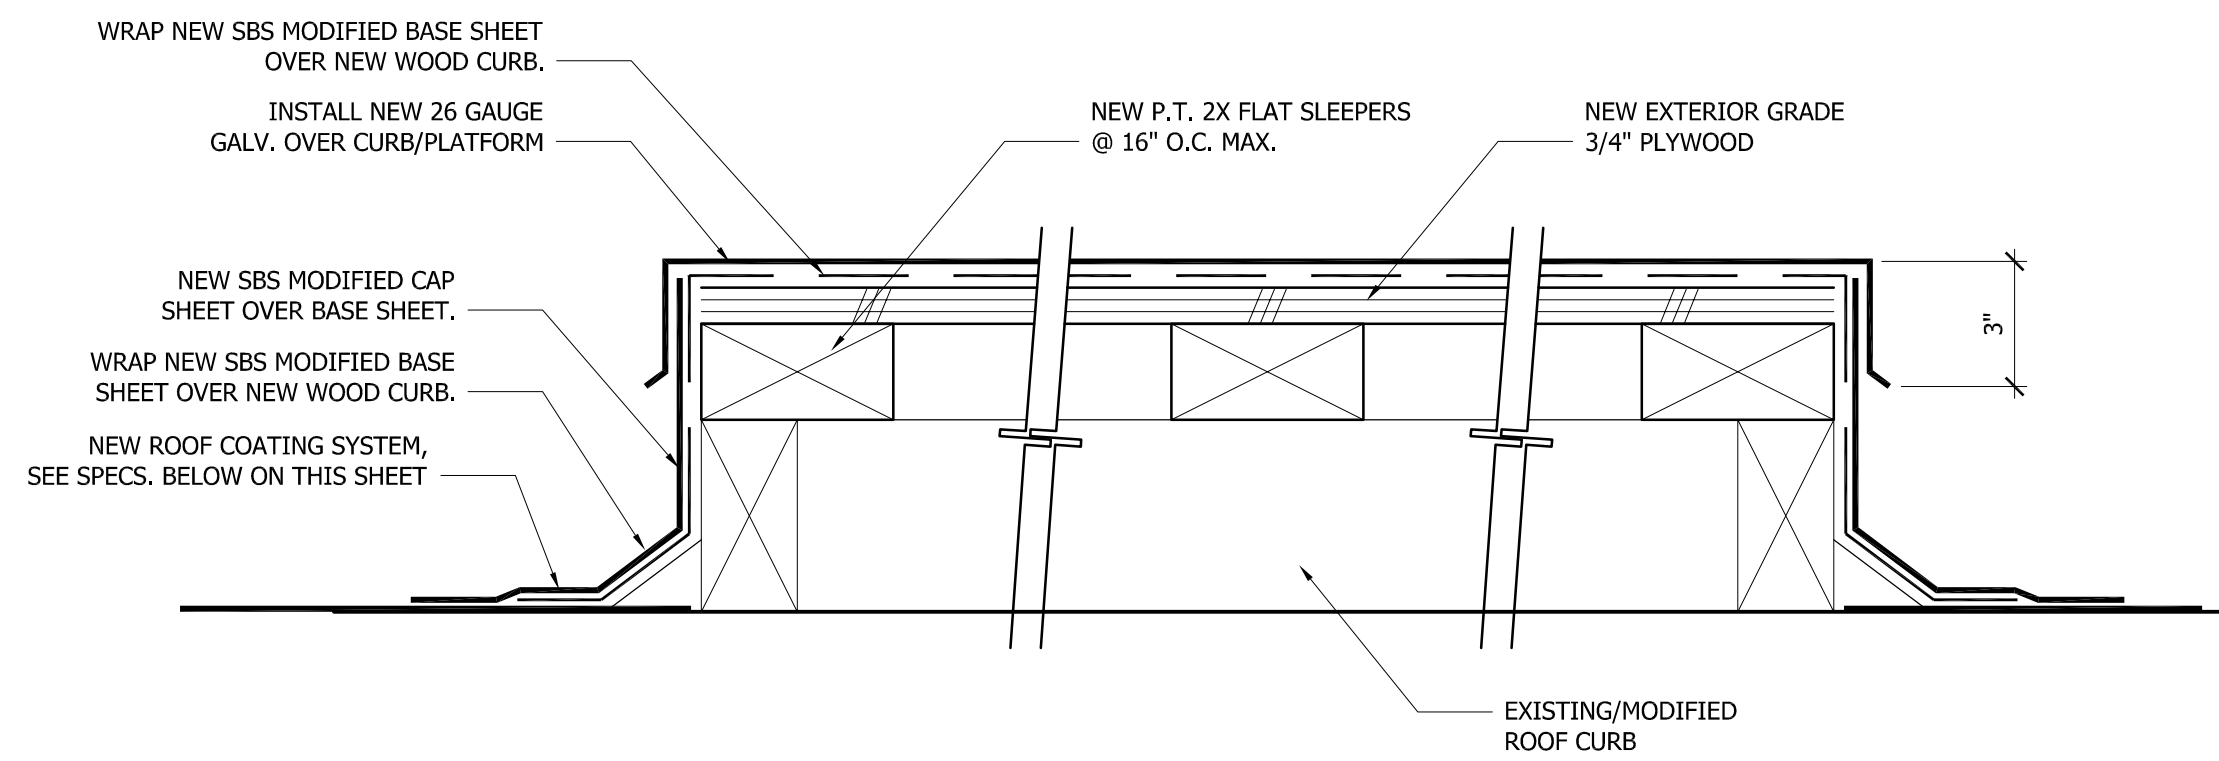
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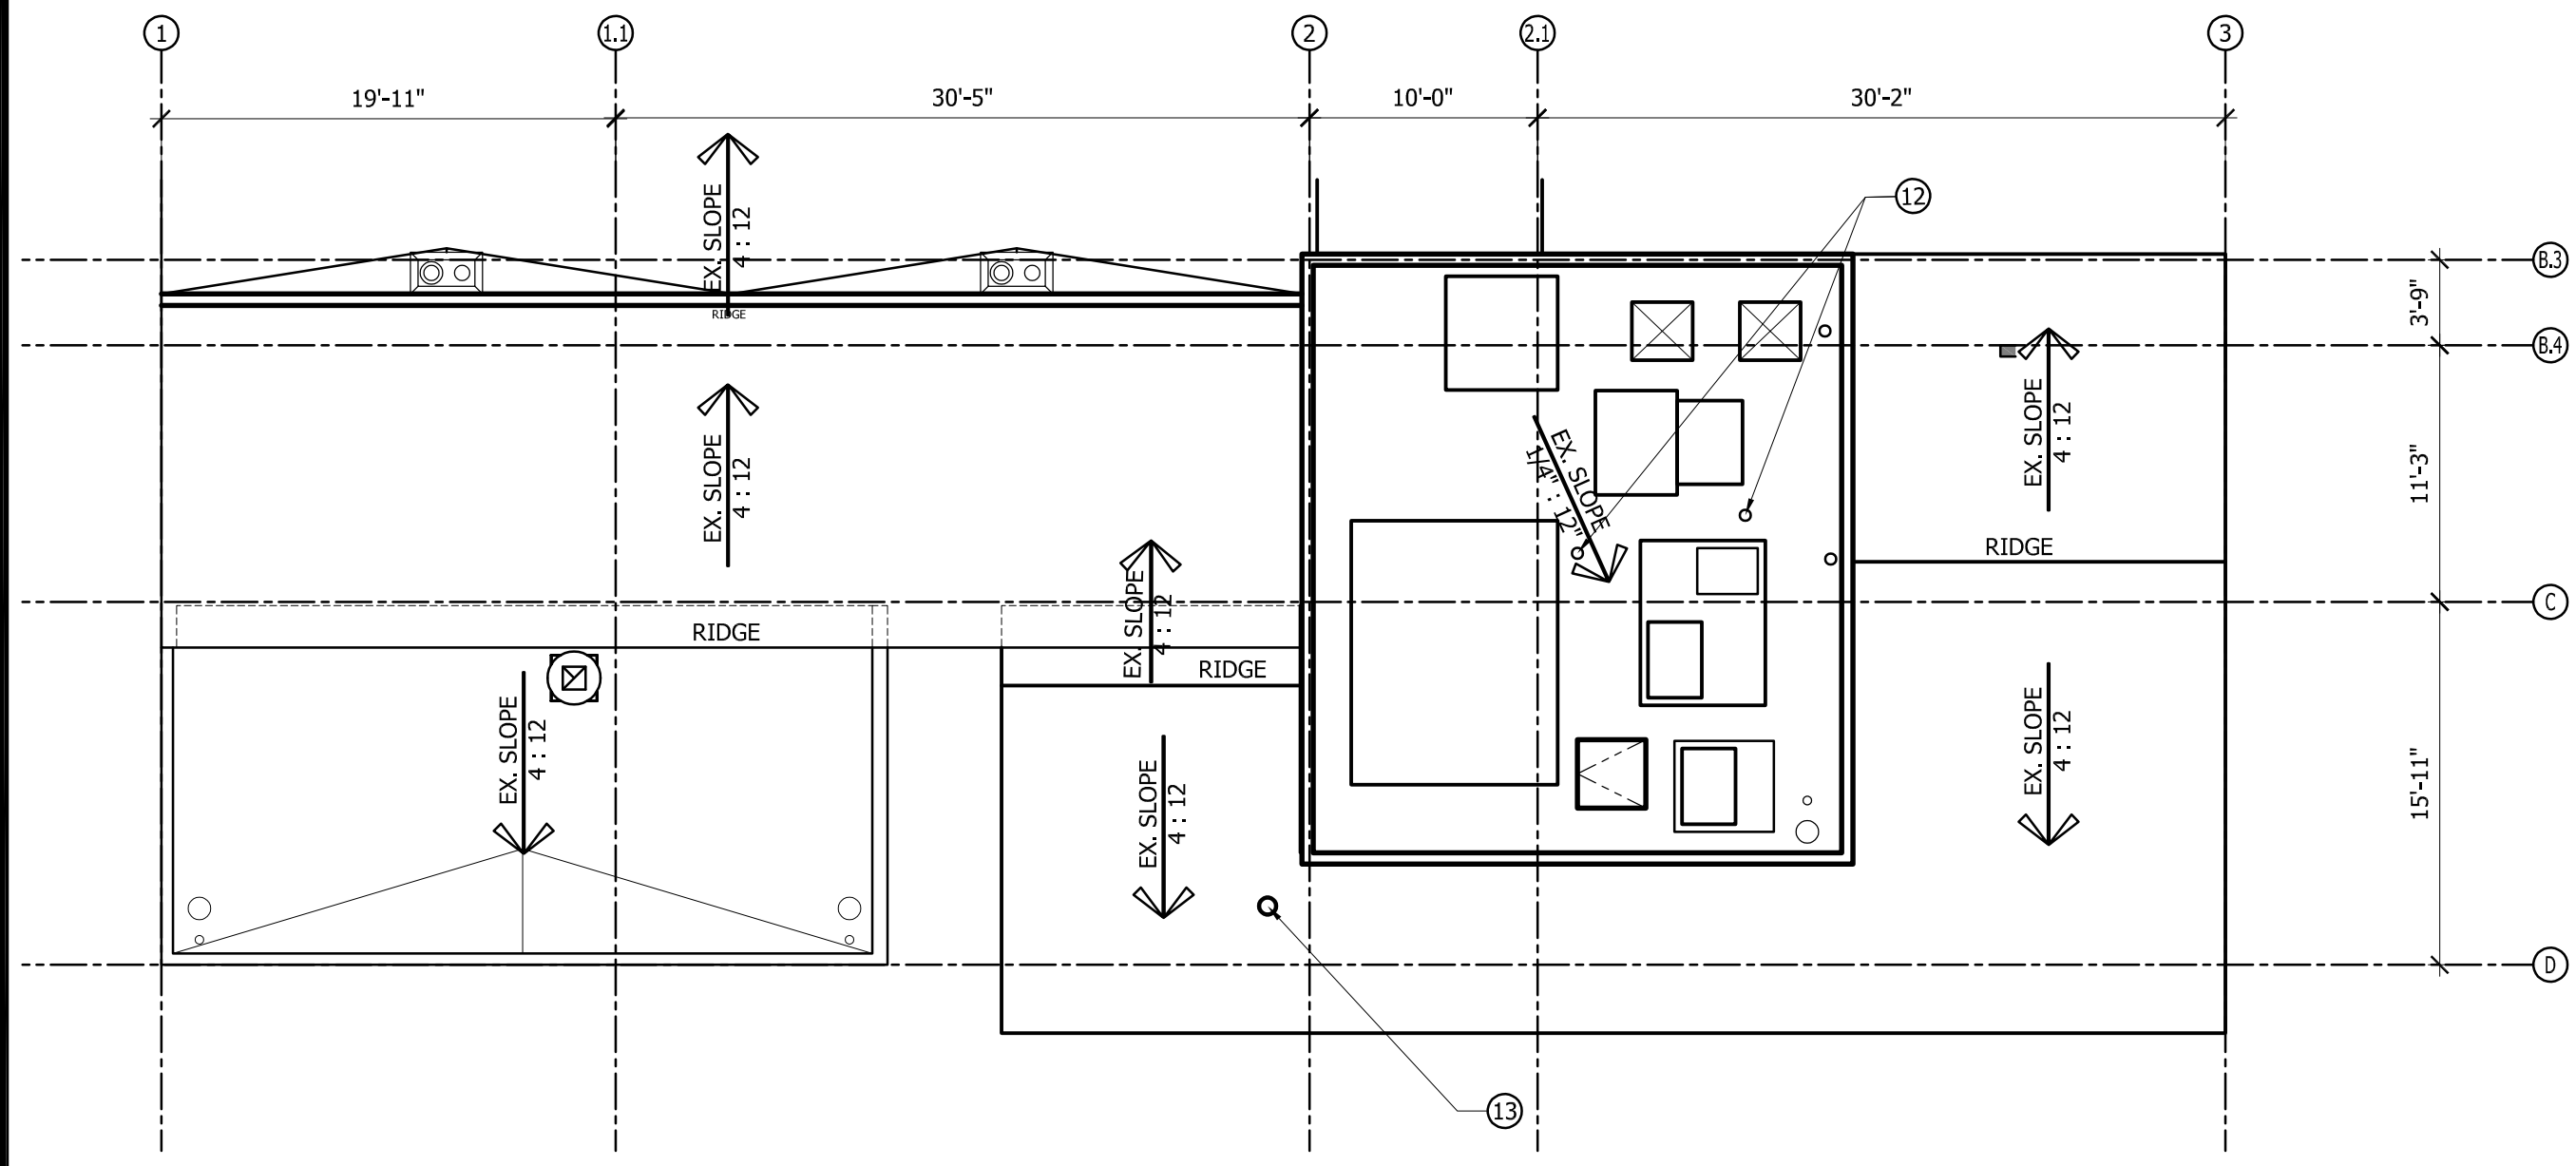
ENLARGED EQUIP. PLAN - EX./DEMO & PROPOSED
TOWN OF YUCCA VALLEY
Senior Center - Kitchen Equipment Upgrades




01 ENLARGED PARTIAL ROOF PLAN - EXISTING/DEMO
A-3.1 Scale : 1/8" - 1'-0"



04 EX./MODIFIED ROOF CURB
A-3.1 Scale : N.T.S.

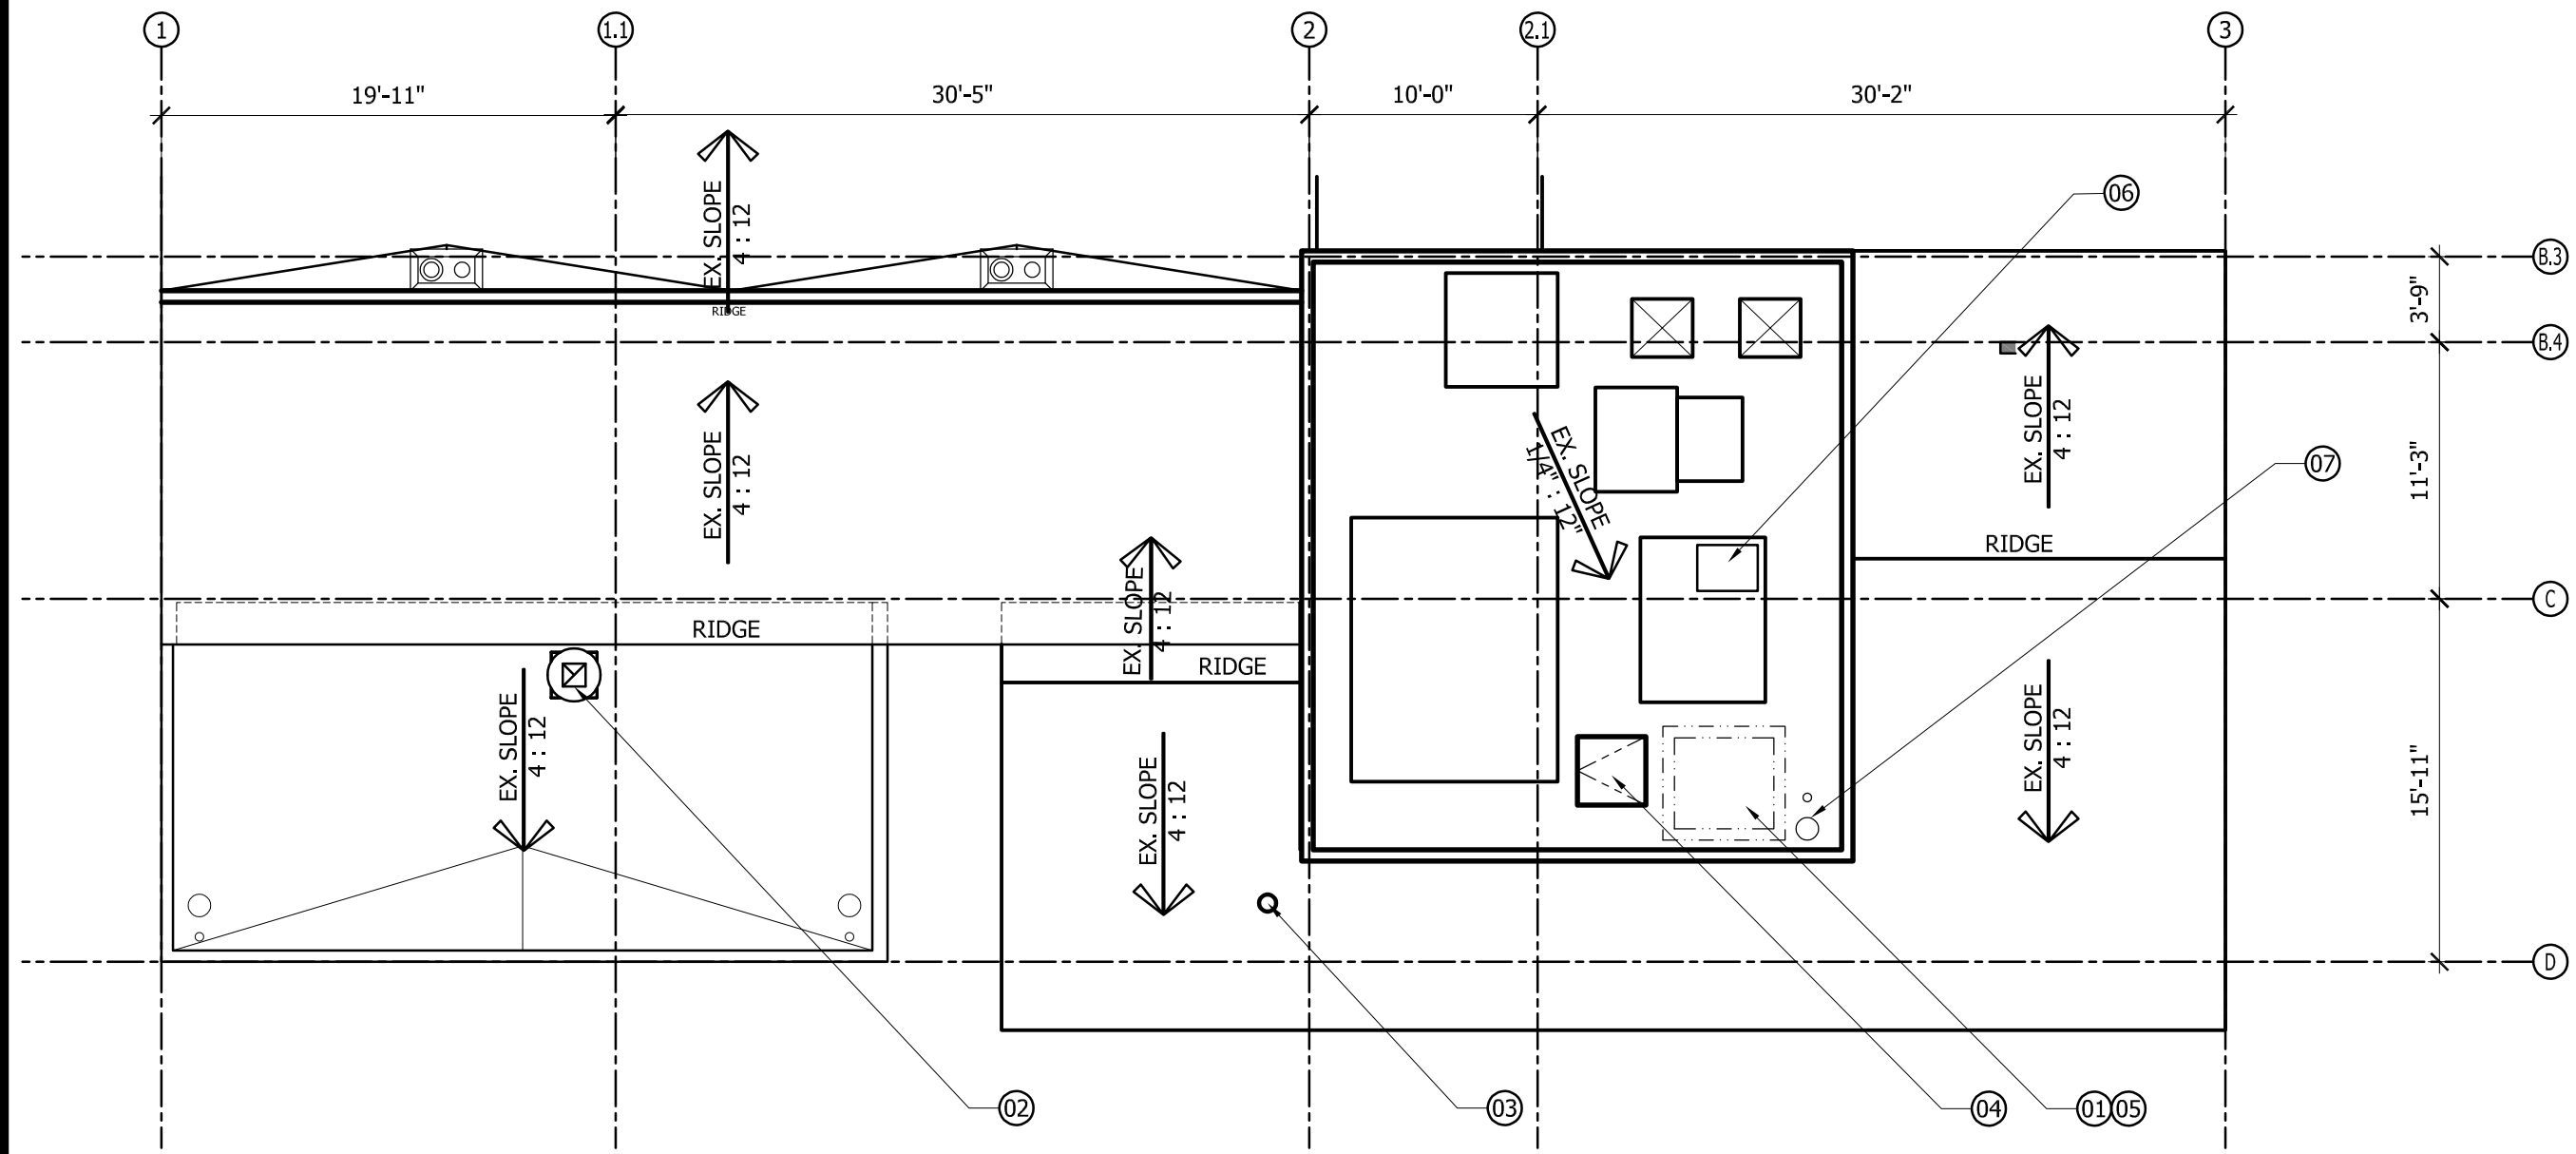


02 ENLARGED PARTIAL ROOF PLAN - PROPOSED
A-3.1 Scale : 1/8" - 1'-0"

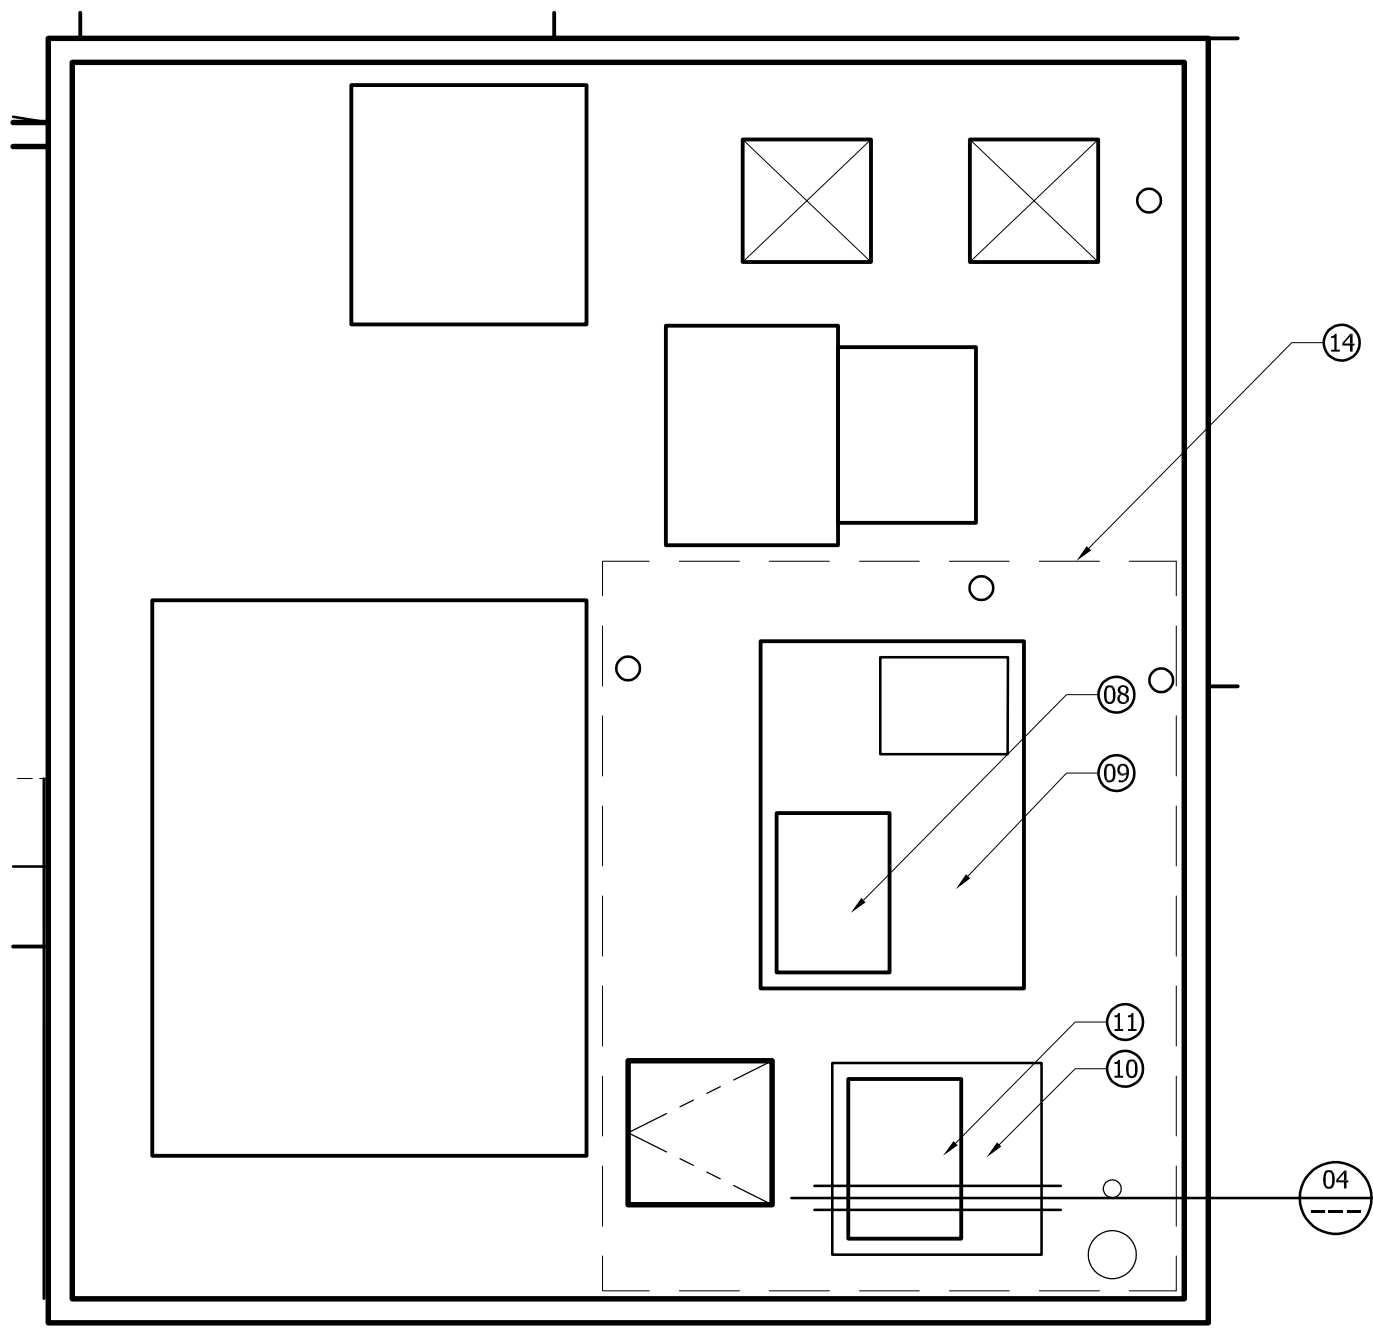


03 ENLARGED PARTIAL ROOF PLAN - PROPOSED EQUIPMENT
A-3.1 Scale : 1/4" - 1'-0"

ROOF COATING SYSTEM:
-HENRY, 100% SILICONE
-WHITE (TROI-COOL)
-INSTALLED OVER NEW/MODIFIED BUILT-UP ROOF SYSTEM

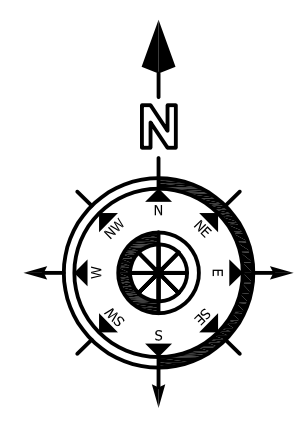

- KEYNOTES:
- 01 EXISTING METAL CORRUGATED AWNING AND SUPPORTS TO BE REMOVED
 - 02 EXISTING EXHAUST FAN TO REMAIN, PROTECT IN-PLACE
 - 03 EXISTING VENT PIPE TO BE REPLACED
 - 04 EXISTING ROOF HATCH TO REMAIN, PROTECT IN-PLACE
 - 05 EXISTING FREEZER/COOLER EQUIPMENT TO BE REMOVED. REMOVE EXISTING SHEET METAL CURB FLASHING
 - 06 EXISTING CONDENSER TO REMAIN, PROTECT IN-PLACE
 - 07 EXISTING ROOF DRAIN TO REMAIN. CLEAN AND INSTALL NEW FIBERGLASS GRATE
 - 08 NEW FREEZER CONDENSER, SET ON NEW ISOLATION PADS. SEAL ALL NEW FASTENER/PENETRATIONS
 - 09 CLEAN AND RE-COAT EXISTING CURB FLASHING
 - 10 INSTALL NEW 26 GAUGE GALV. OVER CURB/PLATFORM
 - 11 NEW COOLER CONDENSER, SET ON NEW ISOLATION PADS. SEAL ALL NEW FASTENER/PENETRATIONS.
 - 12 NEW GAS HOSE PER CALIFORNIA PLUMBING CODE (C.P.C.)
 - 13 NEW/REPLACED ROOF VENT AND JACK FOR HOT WATER HEATER (NEW CONCENTRIC VENT PIPE)
 - 14 APPROXIMATE AREA WITH NEW ROOF COATING SYSTEM

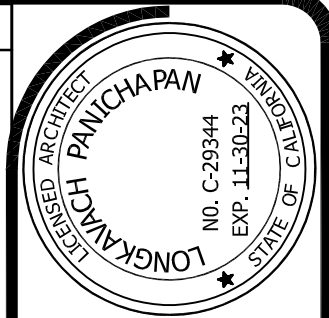

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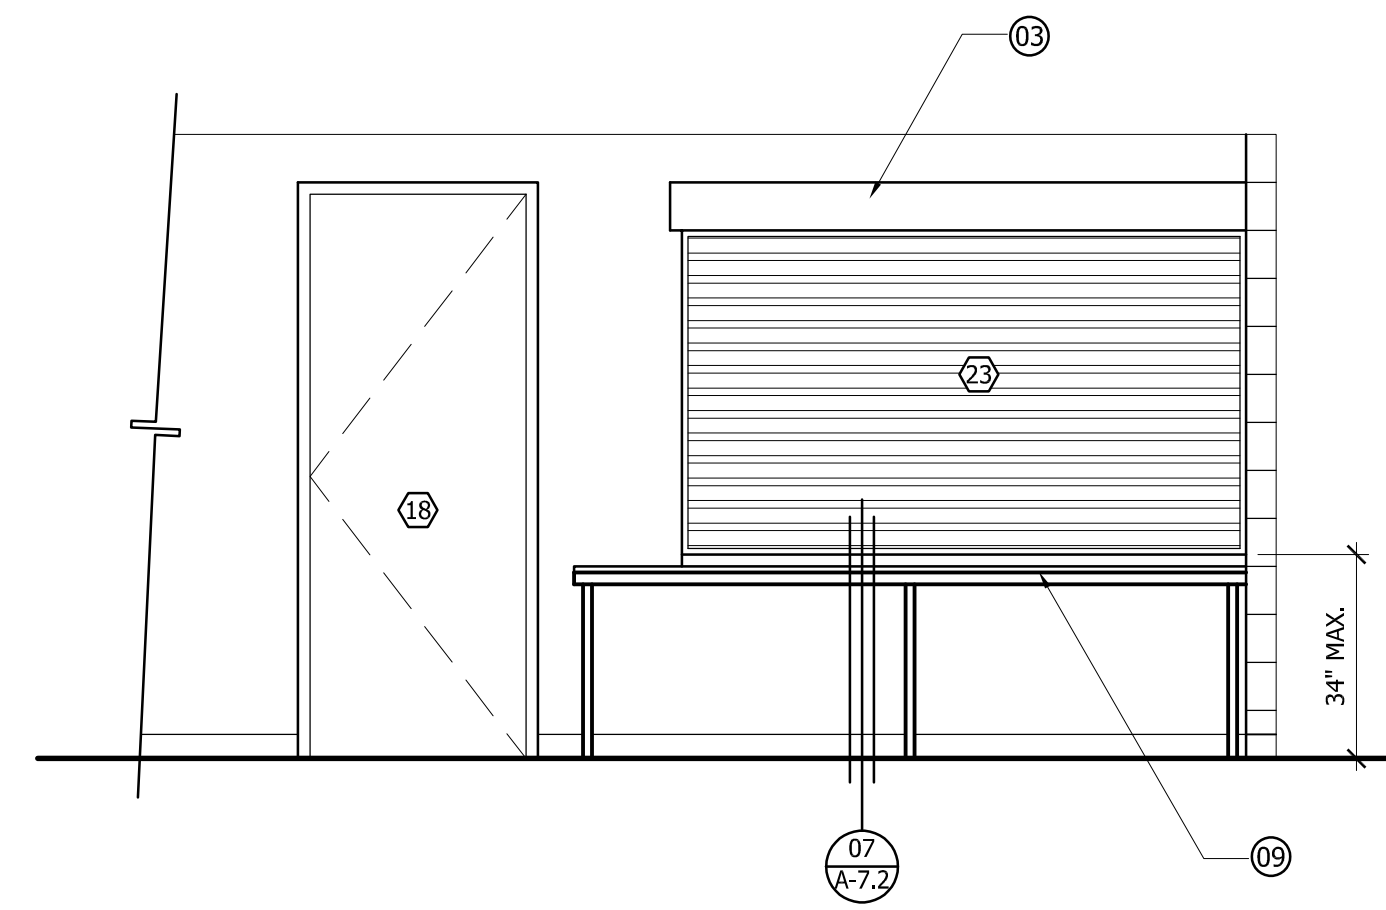
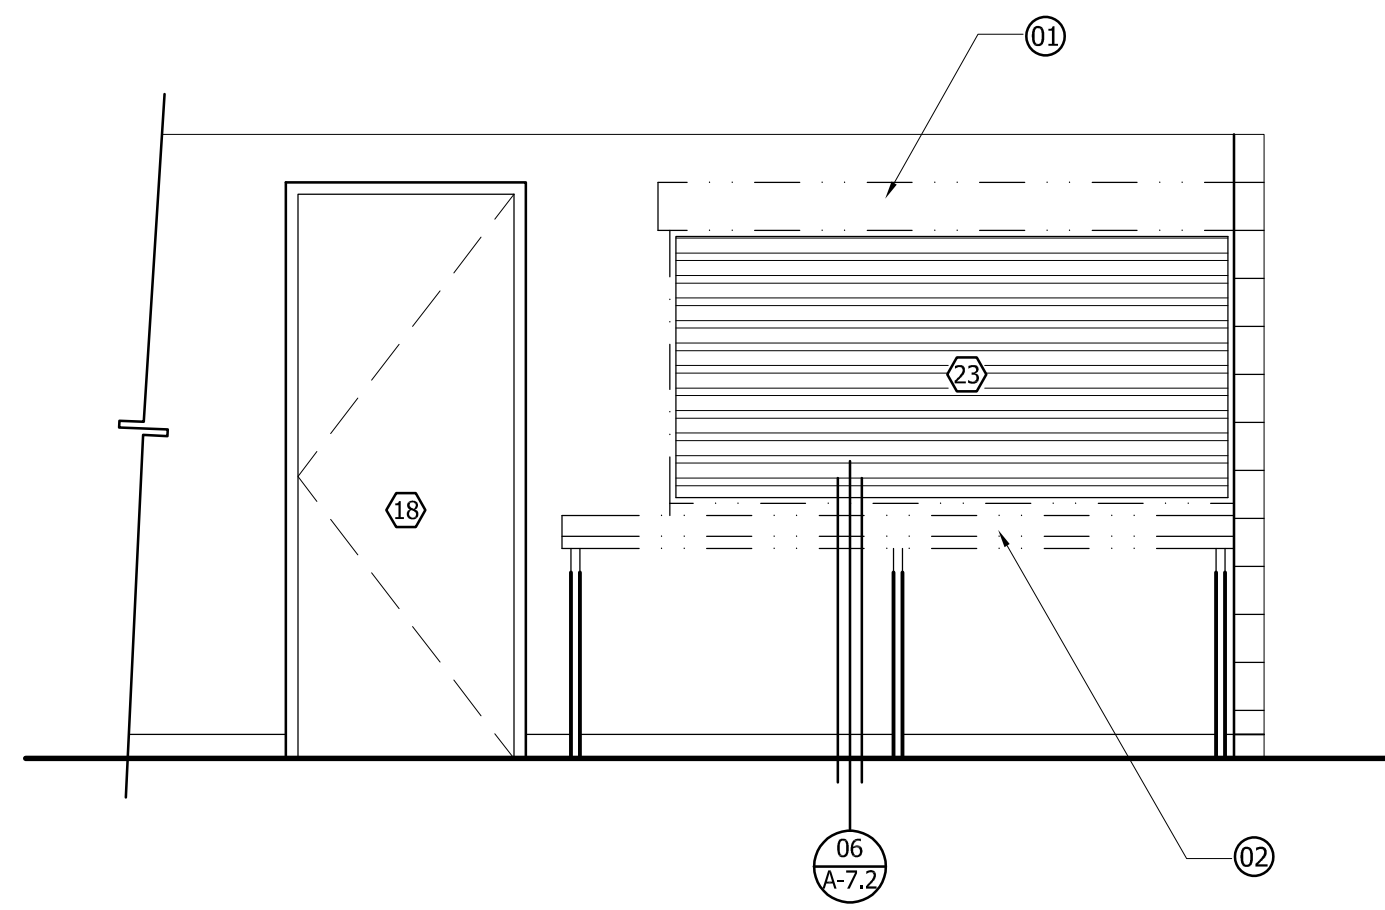
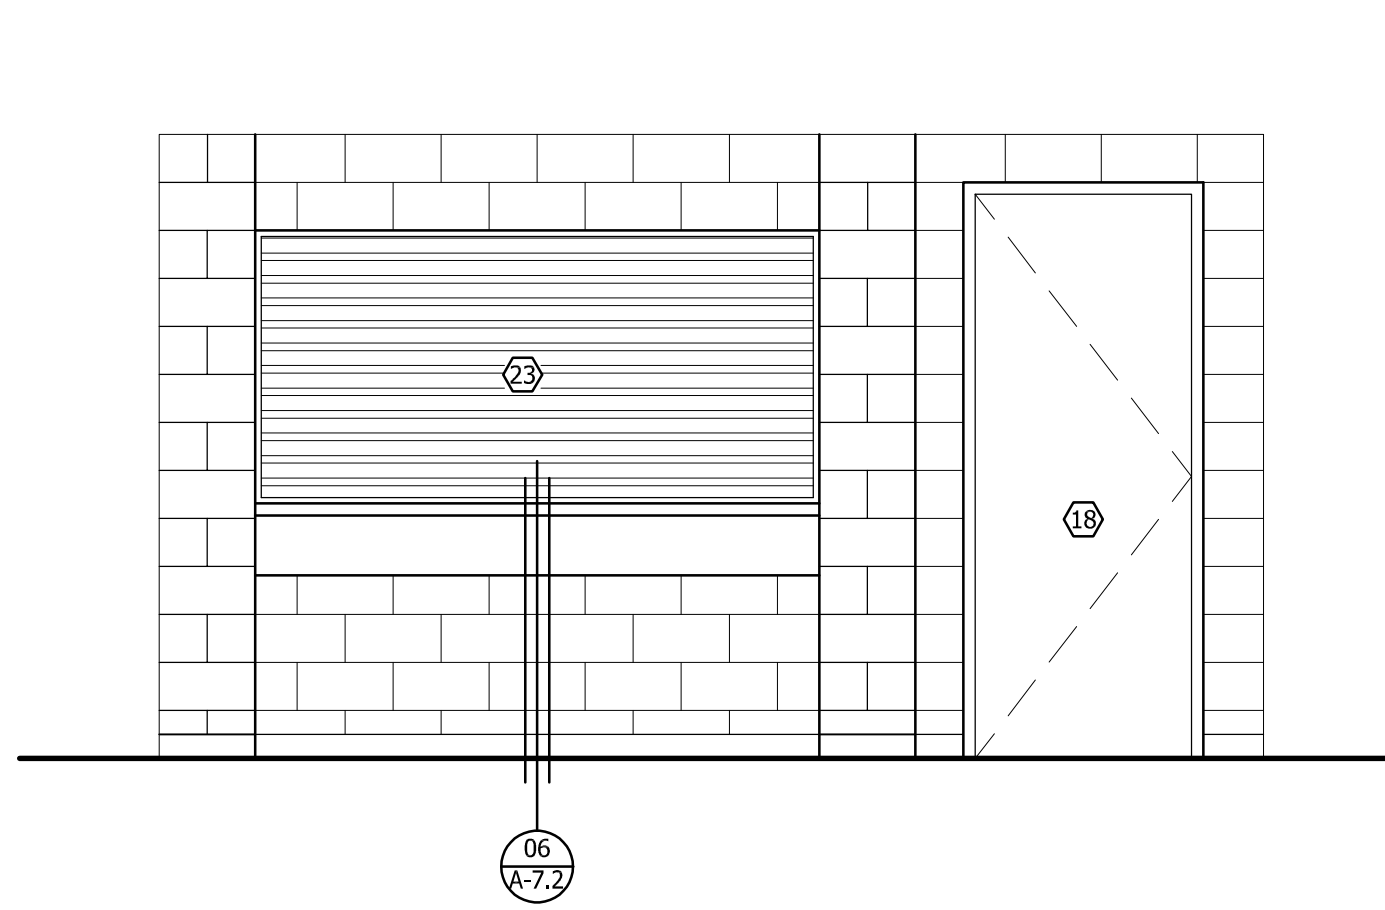
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ENLRGD. PARTIAL ROOF PLAN - EX./DEMO & PROPOSED
TOWN OF YUCCA VALLEY
Senior Center - Kitchen Equipment Upgrades



KEYNOTES:

- 01 DEMO EXISTING COILING DOOR
- 02 EXISTING STAINLESS STEEL COUNTER TO BE MODIFIED
- 03 NEW RATED COILING COUNTER DOOR
- 04 RELOCATED/NEW WIRE RACK DRY DRY STORAGE SHELVING SYSTEM
- 05 REMOVABLE STAINLESS STEEL PANEL TO ACCESS A.C. EQUIPMENT
- 06 NEW FREEZER/REFRIGERATOR EQUIPMENT
- 07 22 GAUGE MIN. INFILL STAINLESS STEEL PANEL TYPICAL. PROVIDE SHOP DRAWINGS SHOWING DETAILS/INFO FOR PROPOSED LAYOUT AND METHOD OF ATTACHMENT (S.S. FASTENERS)
- 08 REMOVABLE STAINLESS STEEL PANEL TO ACCESS A.C. EQUIPMENT
- 09 MODIFIED AND RE-INSTALL STAINLESS STEEL COUNTER TOP

LEGEND:

- XX SEE SHEET A-5.1 FOR DOOR SCHEDULE







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01 INTERIOR ELEVATION - EX./DEMO
A-4.1 Scale: 3/8" - 1'-0"

02 INTERIOR ELEVATION - EX./DEMO
A-4.1 Scale: 3/8" - 1'-0"




03 INTERIOR ELEVATION - PROPOSED
A-4.1 Scale: 3/8" - 1'-0"



04 INTERIOR ELEVATION - DRY STORAGE 2 - #115
A-4.1 Scale: 3/8" - 1'-0"

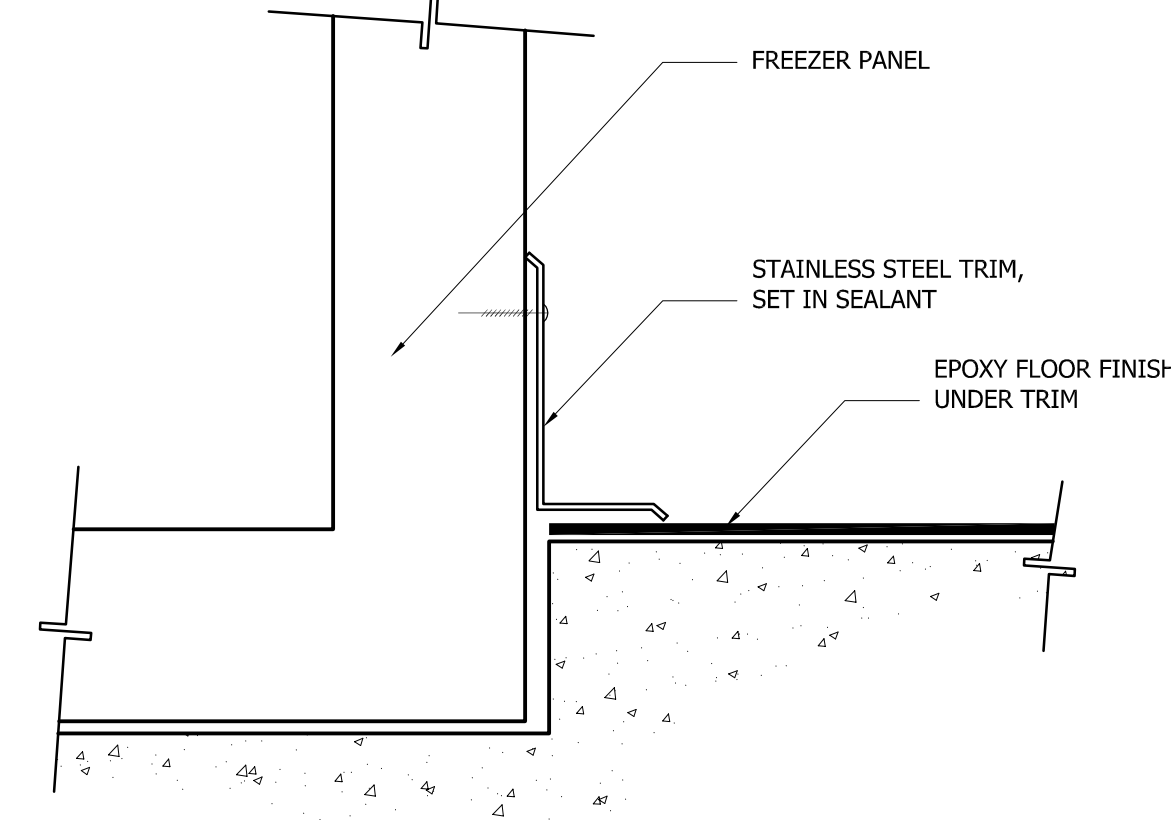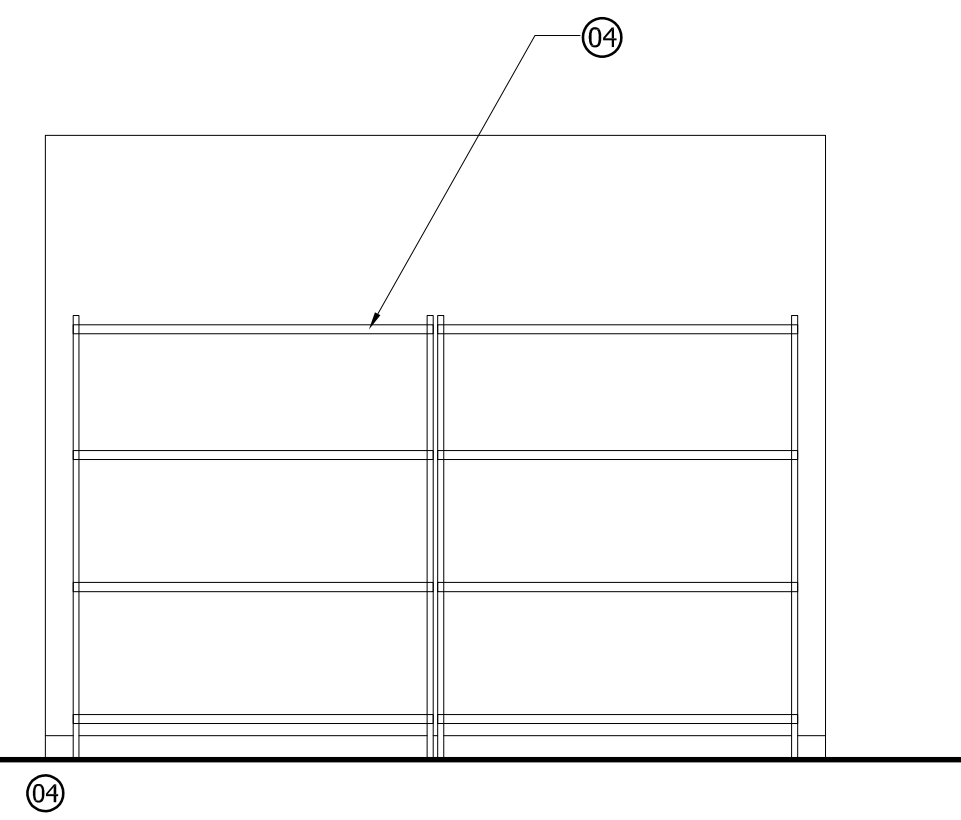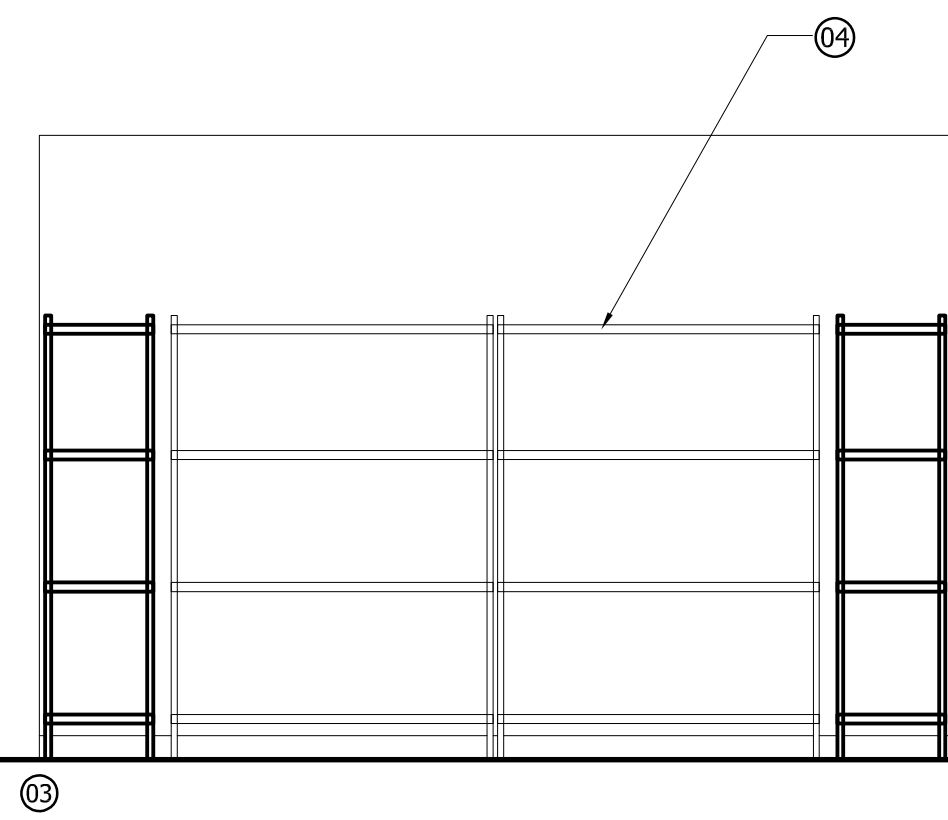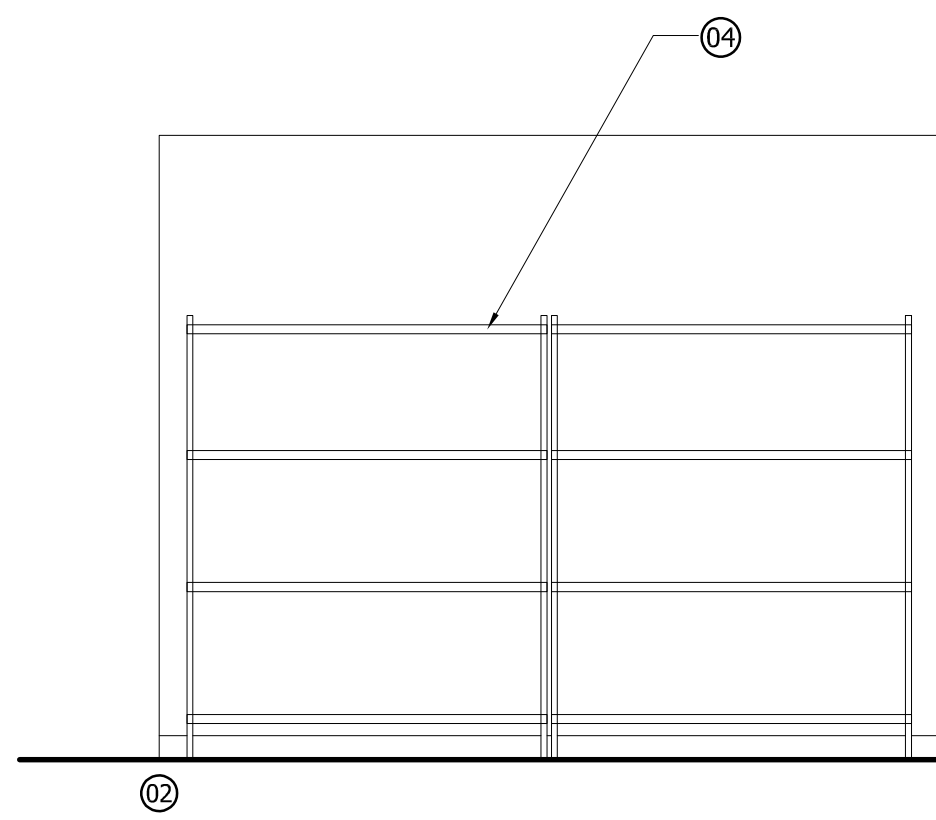DRY STORAGE SHELVING RACKS:
NEW - 13 LINEAR FEET MINIMUM
EXISTING/RELOCATED - 20 LINEAR FEET MINIMUM
MANUFACTURER (NEW) - REGENCY MODEL NO. 460SW1848KIT & 460SW1860KIT

06 ENCLOSURE TRIM & FLASHING
A-4.1 Scale: 3" - 1'-0"

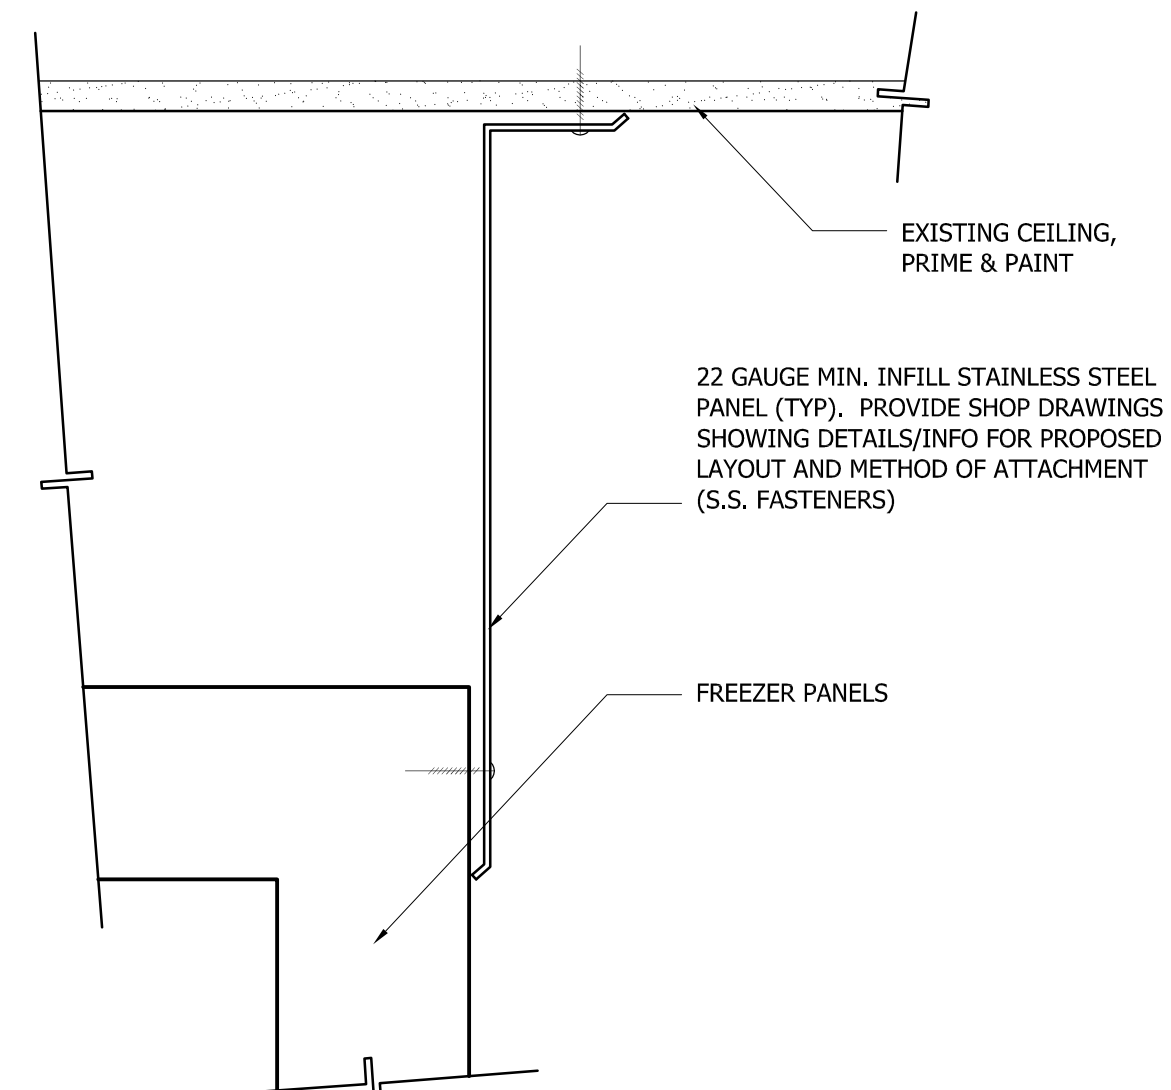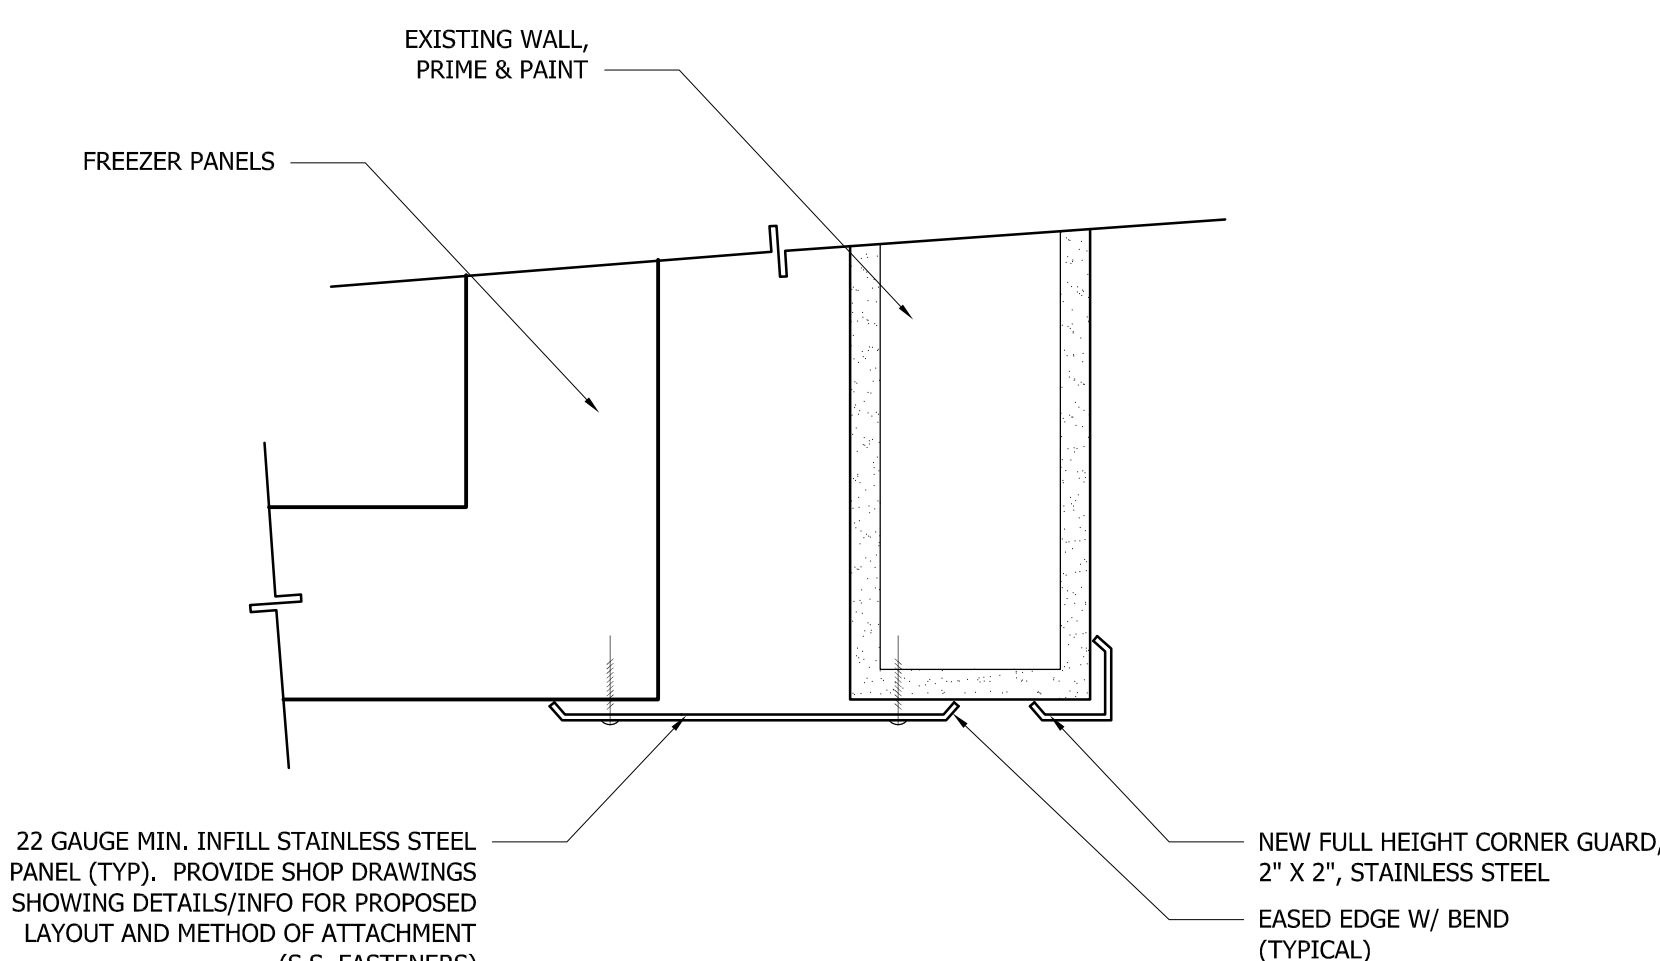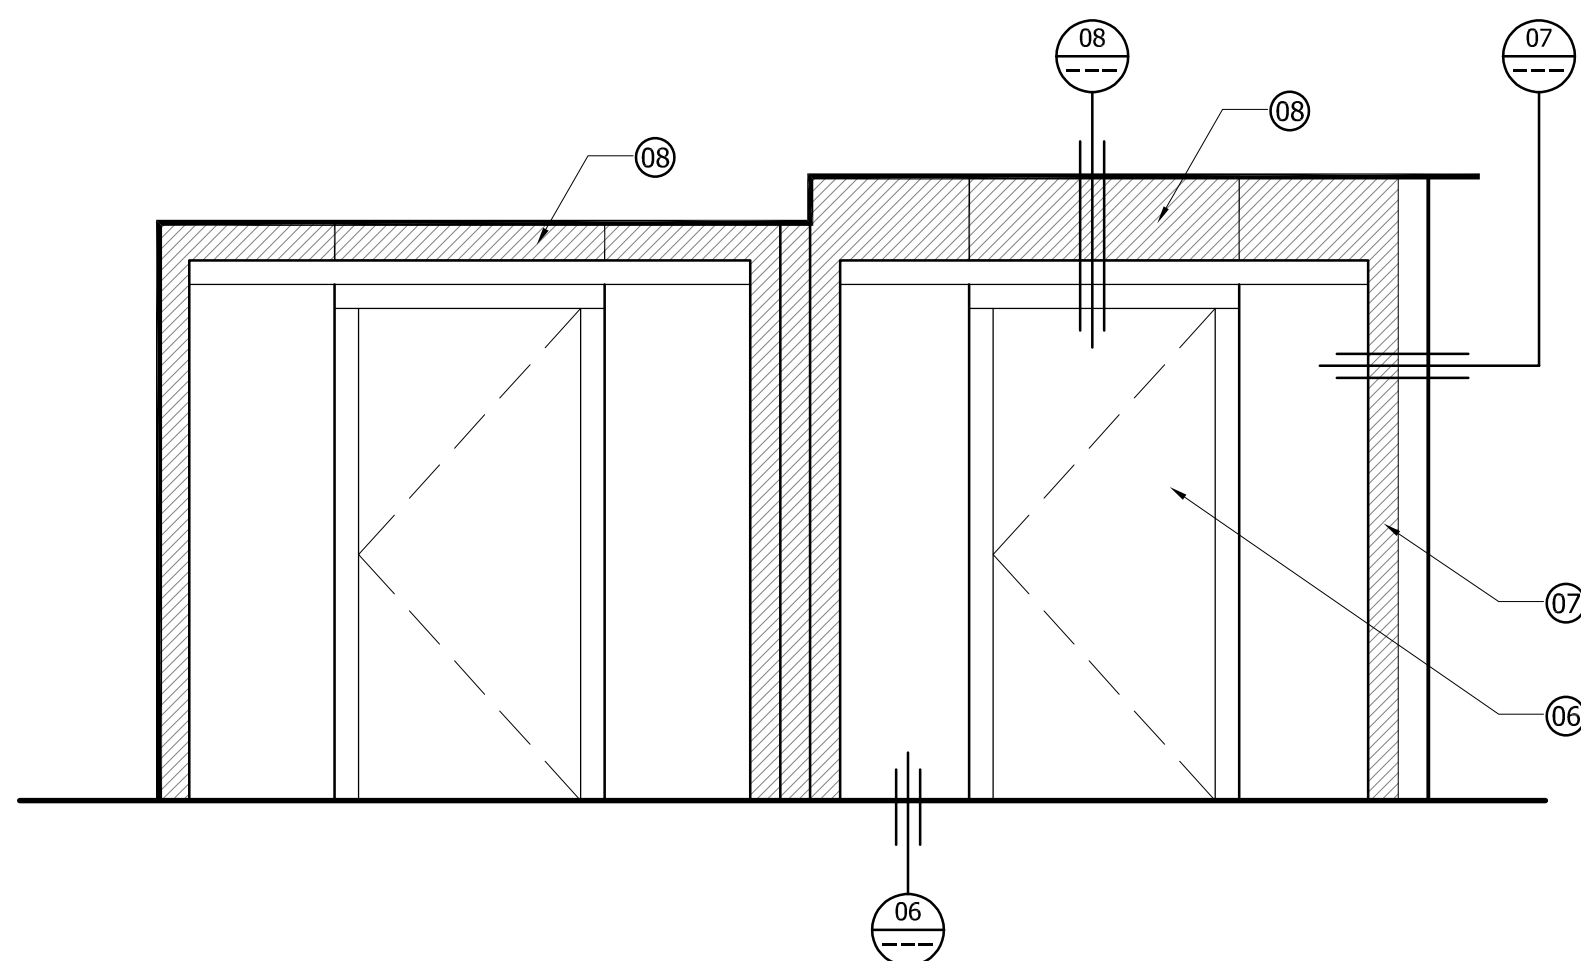

05 INTERIOR ELEVATION - WALK-IN COOLER 123 & WALK-IN FREEZER 124
A-4.1 Scale: 3/8" - 1'-0"

07 ENCLOSURE TRIM & FLASHING
A-4.1 Scale: 3" - 1'-0"

08 ENCLOSURE TRIM & FLASHING
A-4.1 Scale: 3" - 1'-0"

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INTERIOR ELEVATIONS
TOWN OF YUCCA VALLEY
Senior Center - Kitchen Equipment Upgrades

DOOR SCHEDULE

DOOR NUMBER	LOCATION (ROOM NUMBER)	SIZE	TYPE	HARDWARE	THICKNESS	CORE	DOOR		FRAME		DOOR/RM. SIGNS	DETAILS			CLOSER	HINGES	SEALS	DOOR STOP	DOOR BOTTOM	10" S.S. KICK PLATE	THRESHOLD	RATING (MINUTES)	NOTES:
							MATERIAL	FINISH	MATERIAL	FINISH		HEAD	JAMB	THRESHOLD									
03	119	EXISTING																					REMARKS
04	118	EXISTING																					SEE DOOR NOTES BELOW
05	116	EXISTING																					
06	114	EXISTING																					
17	115	3'-0"W X 7'-0"H	B		1 3/4"	HM																	PROVIDE AND INSTALL NEW 12" X 12" S.S. LOUVER PATCH, FILL, PRIME, AND PAINT (REMOVE HARDWARE PRIOR TO PAINTING)
18	117	EXISTING	A			WD																	
19	125																						
20	120	EXISTING																					
21	121	EXISTING																					
22	122	EXISTING																					
23	117																						
24	126	3'-0"W X 7'-0"H																					
25	127	EXISTING																					

NOTES

GENERAL NOTES: (ALL DOORS)

A. MAXIMUM EFFORT TO OPERATE DOORS APPLIED AT RIGHT ANGLES TO HINGED DOORS OR AT CENTER PLANE, PER CBC SECTION 404.2.9 WILL BE:

a.) ≤ 5 LB. AT EXTERIOR DOORS
 b.) ≤ 5 LB. AT INTERIOR DOORS
 c.) ≤ 15 LB. WHERE FIRE DOORS ARE REQUIRED.

B. ALL DOORS SHALL COMPLY WITH CBC CHAPTER 10 DOORS.

C. DOORS SHALL BE EQUIPPED ONLY WITH NO-KNOWLEDGE, SINGLE-ACTION HARDWARE. LOCKS THAT REQUIRE KEYS OR ADDITIONAL ACTIONS TO OPERATE (SUCH AS MANUAL BOLTS) ARE NOT PERMITTED, CBC 1010.1.9. ALL DOOR HARDWARE SHALL BE LEVER TYPE, PUSH-PULL ACTIVATING BARS OR PANIC HARDWARE THAT DOES NOT REQUIRE TIGHT GRASPING, PINCHING, OR TWISTING OF THE WRIST TO OPERATE. (PER CBC 11B-309.4)

D. DOORS WITH GLAZING SHALL BE PROVIDED WITH 10" HIGH SMOOTH METAL PANEL AT THE BOTTOM. (PER CBC 11B-404.2.10)

E. BOTTOM OF DOOR TO BE SMOOTH AND UNINTERRUPTED, TO ALLOW DOOR TO BE OPENED BY WHEELCHAIR FOOTREST. SEC. 11B-404.2.10.

F. PROVIDE SIGN AT MAIN EXIT DOORS INDICATING: "THIS DOOR MUST REMAIN UNLOCKED WHEN BUILDING IS OCCUPIED" PER CBC 1010.1.9.3. ALL OTHER DOORS SHALL BE OPENABLE FROM INSIDE WITHOUT THE USE OF A KEY OR ANY SPECIAL KNOWLEDGE OR EFFORT.

G. ALL HOLLOW METAL DOORS STILES AND TOP RAILS SHALL BE 5" MINIMUM. (U.N.O.)

H. ALL ALUMINUM DOORS STILES AND TOP RAILS SHALL BE 5" U.N.O. ALL GLASS TYPES AND THICKNESS SHALL COMPLY WITH USC TABLE 24-A AND GRAPH 24.1

I. SEE SPECIFICATIONS FOR ADDITIONAL DOOR HARDWARE INFORMATION. REFER TO FLOOR PLANS FOR DOOR HARDWARE FUNCTION FOR REQUIREMENTS.

J. COMPLY WITH SEC. 2406 FOR REQUIRED SAFETY GLAZING.

K. DOOR, GATES, AND SIDE LIGHTS ADJACENT TO DOORS OR GATES, CONTAINING ONE OR MORE GLAZING PANELS THAT PERMIT VIEWING THROUGH THE PANELS SHALL HAVE THE BOTTOM OF AT LEAST ONE OF THE GLAZED PANEL LOCATED 43 INCHES MAXIMUM ABOVE THE FINISHED FLOOR. (PER CBC 11B-404.2.11)


DOOR SIGNAGE LEGEND:

S1 - VERIFY ROOM NAME WITH OWNER
 S2 - TOILET ROOM SIGNAGE "MEN"
 S3 - TOILET ROOM SIGNAGE "WOMEN"
 S4 - ACCESSIBLE ENTRANCE SIGN
 S5 - TOILET ROOM SIGNAGE "ALL GENDER"

DOOR ABBREVIATIONS:

HM - HOLLOW METAL
 PL - PLASTIC LAMINATE
 PT - PAINT
 AL - ALUMINUM
 SC - SOLID CORE
 MT - METAL
 WD - WOOD

DOOR TYPES

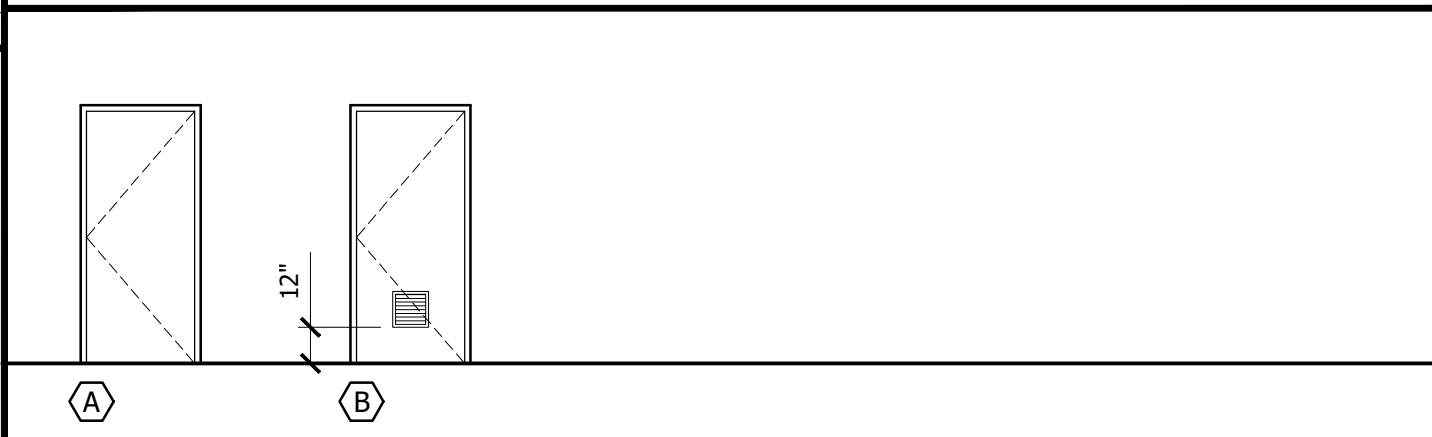


FINISH SCHEDULE

ROOM	FLOOR	BASE	WALLS	CEILING	LEGEND	REMARKS
114	DINING				SKIM COAT/PAINT	
115	DRY STORAGE					
116	MECHANICAL ROOM					
117	KITCHEN					
118	DISHWASHING					
119	VESTIBULE					
120	OFFICE					
121	LOCKER/JANITOR					
122	RESTROOM					
123	WALK-IN COOLER					
124	WALK-IN FREEZER					
126	STORAGE					
127	STORAGE					

DOOR NO. 03 NOTES:

1. RECONFIGURE EXISTING 2X4 STUD WALL AT EXISTING OPENING (P.T. SILL WITH POWER DRIVEN ANCHORS).
2. PROVIDE NEW 4X8 HEADER SPANNING BETWEEN EXISTING FULL HEIGHT STUDS (HEADER SPAN ~48"+). INSTALL NEW JACK STUDS AT JAMBS.
3. INTERIOR: INSTALL NEW GYPSUM BOARD TO MATCH EXISTING.
4. EXTERIOR: INSTALL PLYWOOD, WATERPROOF MEMBRANE (2 LAYERS OF NEW BUILDING PAPER) AND NEW PLASTER TO MATCH EXISTING TEXTURE.
5. PROVIDE AND INSTALL NEW ALUMINUM DRIP AT H.M. DOOR FRAME.
6. RE-INSTALL ALL EXISTING DOOR SYSTEMS TO EXISTING FUNCTION.

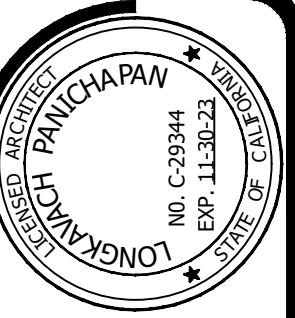


Gillis + Panichapan Architects, Inc.
 2900 BRISTOL STREET, COSTA MESA, CALIFORNIA 92626
 TEL: (714) 666-4265 FAX: (714) 666-4266

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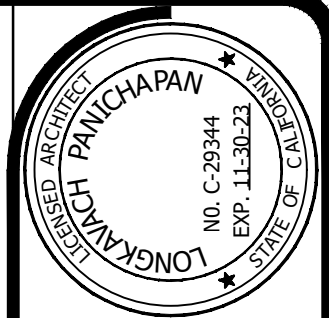
CONSTRUCTION SET

DATE: 01/13/2022
 BLDG. DEPT. CORRECT.
 JOB NO.: 4107
 DRAWN BY: STAFF
 CHECKED BY: LP
 SCALE: AS NOTED

DOOR & FINISH FLOOR SCHEDULES - F.S. 53
 TOWN OF YUCCA VALLEY
 Senior Center - Kitchen Equipment Upgrades

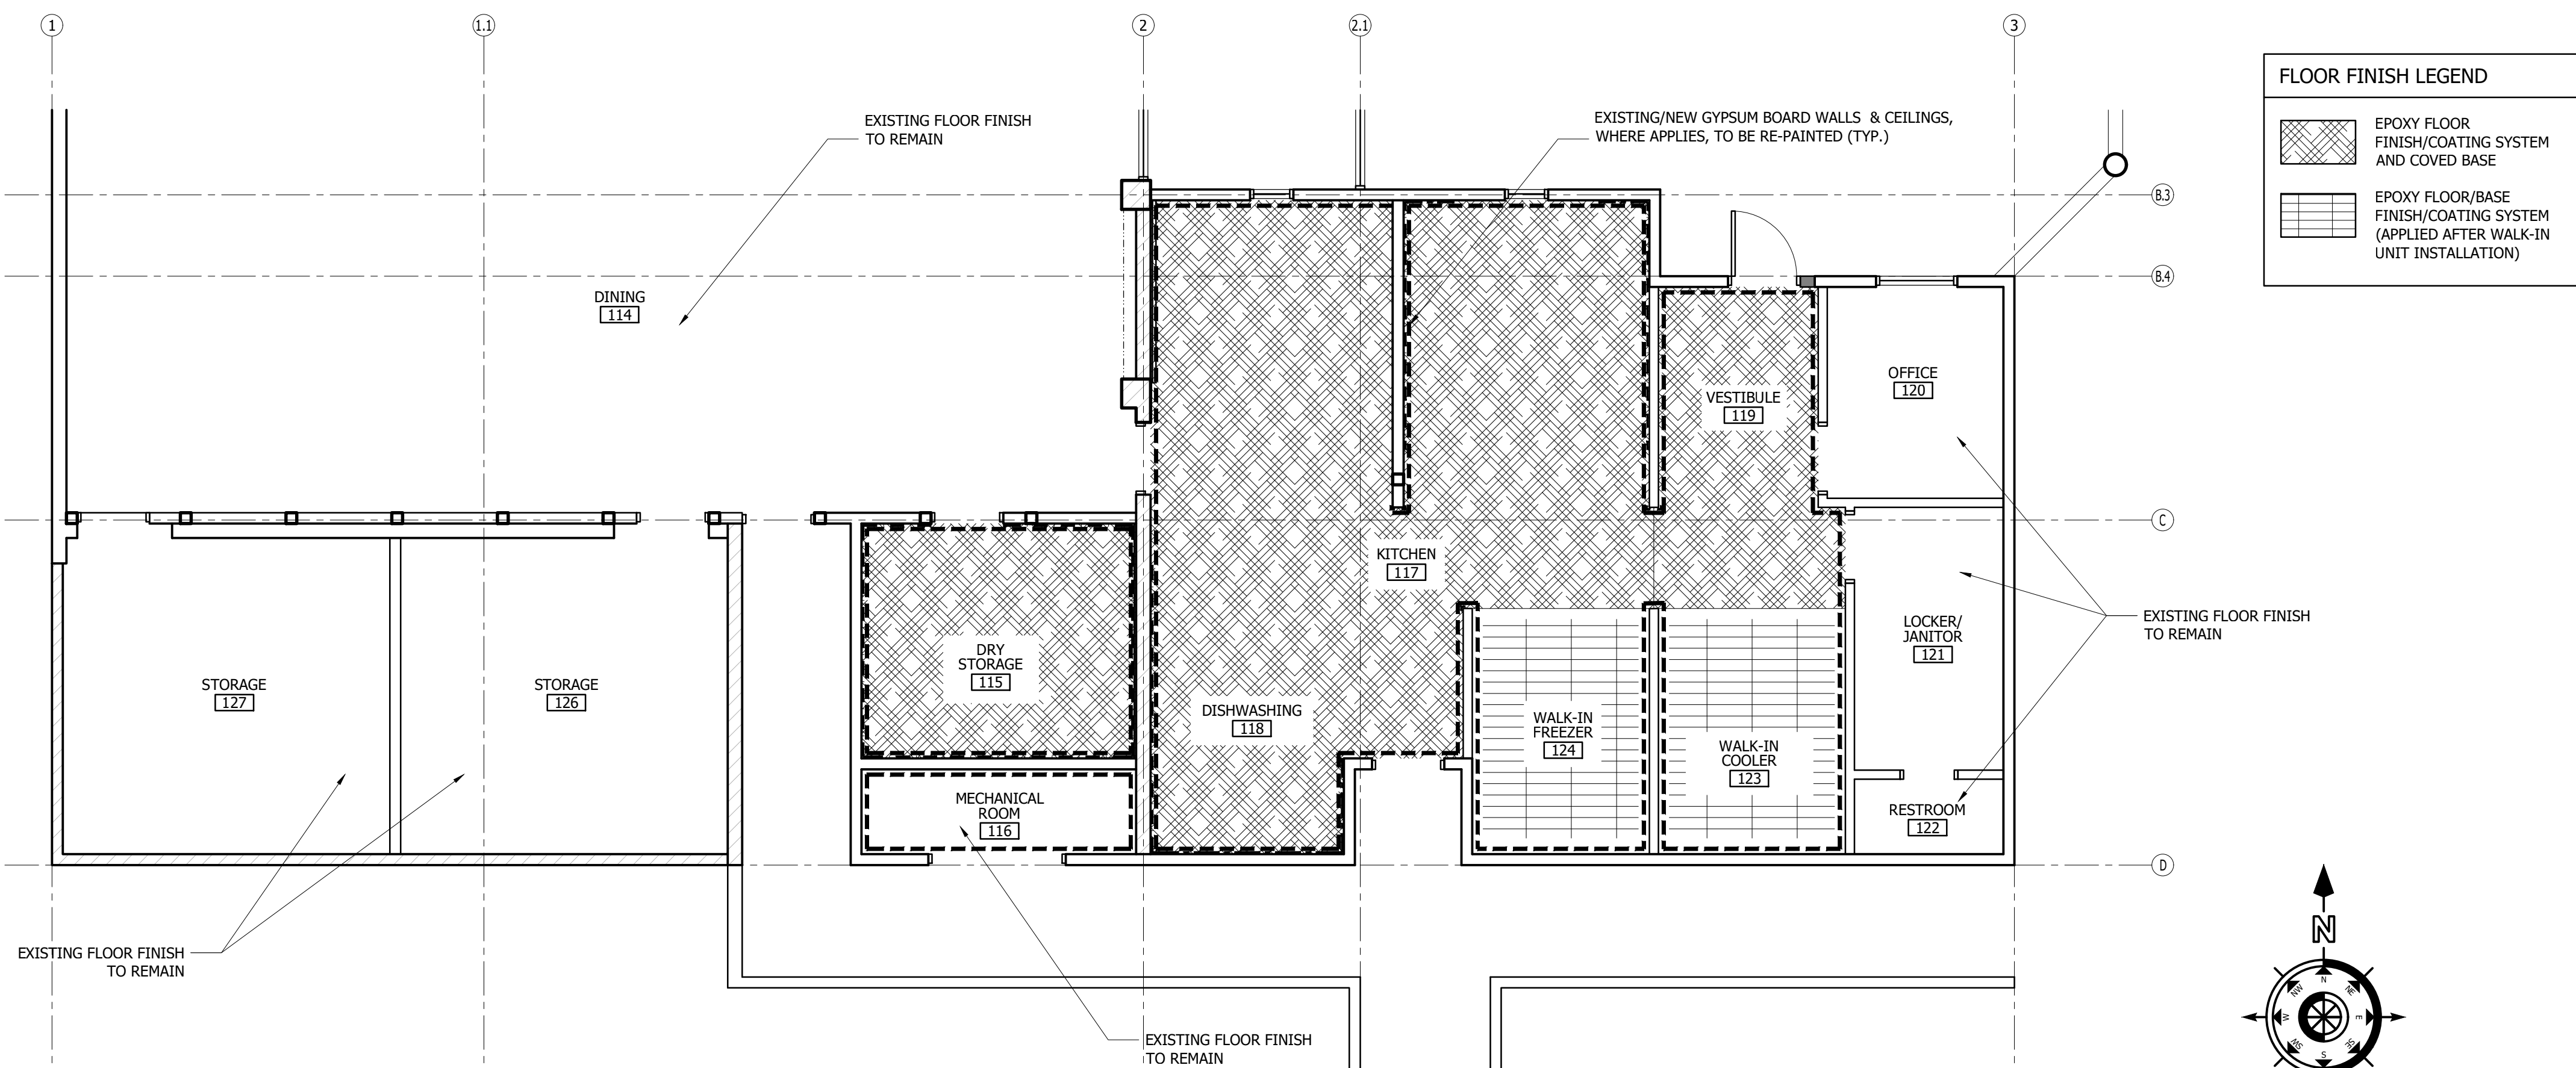

01 FINISH FLOOR PLAN
 Scale: 3/16" = 1'-0"



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interior

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2900 BRISTOL STREET COSTA MESA CALIFORNIA 92626
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CONSTRUCTION SET

DATE: 01/13/2022
DATE: 12/09/21
DATE: 12/09/21
DATE: 12/09/21

BLDG. DEPT. CORRECT.	
JOB NO.: 4107	
DRAWN BY: STAFF	
CHECKED BY: LP	
SCALE: N.T.S.	

REFERENCE SHEET

TOWN OF YUCCA VALLEY
Senior Center - Kitchen Equipment Upgrades

A-6.1

BARMANIAN WOLFE*LANG CHRISTOPHER ARCHITECTS



Yucca Valley Senior Center

CONSULTANT
J. S. Mueller
LMAD
MECHANICAL & ELECTRICAL
DESIGN CONSULTANTS

APPROVED

APPROVED

NO DATE BY REVISION REMARKS


SCHEDULE, 1/4" PLANS

DRAWN: [Signature]
CHECKED: CAJ
DATE: [Blank]
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JOB NO: 01-034


M-2

EQUIPMENT SCHEDULE


SYSTEM 1 AIR CONDITIONING UNIT AC-1 "LENNOX" GC53-1853-275, 275,000 BTU/HR INPUT, 206,250 BTU/HR OUTPUT HEATING CAPACITY, 175,500 BTU/HR COOLING CAPACITY @15°F, ENTERING CONDENSER COIL AND 62°F, W.B./80°F, D.B., ENTERING EVAPORATOR COIL, 208 VOLT - 3 PHASE - 60 CYCLE 50 AMP FULL LOAD AMPS AND 5 HORSEPOWER BLOWER MOTOR TO DELIVER 6500 CFM OF AIR AT 780 R.P.M. AND 1/2 INCH STATIC PRESSURE. UNIT COMPLETE WITH POWER SAVER, 3200 LBS. OPERATING WEIGHT.
SYSTEM 2 FURNACE F-1 "LENNOX" #G12 04E-50, 50,000 BTU/HR INPUT - 40,000 BTU/HR OUTPUT HEATING CAPACITY, 172 HORSEPOWER, 120 VOLT - 1 PHASE - 60 CYCLE BLOWER MOTOR TO DELIVER 1265 C.F.M. OF AIR AT 40 INCH STATIC PRESSURE. COOLING COIL CC-1 "LENNOX" #CS-620FF CONDENSING UNIT CU-1 "LENNOX" #HS14-413V, 9.6 EER, 3690 TOTAL UNIT WATTS, 35,400 BTU/HR COOLING CAPACITY AT HIGH SPEED, 208 VOLT - 3 PHASE - 60 CYCLE 11.8 FULL LOAD AMPS.
SYSTEM 3 FURNACE F-2 "LENNOX" #G1204E-50, 1000 C.F.M. (TYPICAL TO F-1) COOLING COIL CC-2 "LENNOX" #CS-620FF CONDENSING UNIT CU-2 "LENNOX" #HS14-413V, (TYPICAL TO CU-1)
KITCHEN EXHAUST SYSTEM HOOD EXHAUST EH-1 "BRIEDERT" LQ-SET LQ-3055 6200 C.F.M. @ 5" EXTERNAL STATIC PRESSURE, R.P.M. 14950 TIP SPEED, 1-1/2" MOTOR HORSEPOWER 3 - PHASE - 60 CYCLE BLOWER MOTOR 9.4 FULL LOAD AMPS, 1000 LBS OPERATING WEIGHT, 4000 BTU/HR INPUT. MAKE-UP AIR UNIT MA-1 "ESSICK" #400, 7400 C.F.M. OF AIR AT .4 INCH STATIC PRESSURE, 625 R.P.M. AND 40°F, TEMPERATURE RISE, 3 HORSEPOWER 208 VOLT 3 - PHASE - 60 CYCLE BLOWER MOTOR 9.4 FULL LOAD AMPS, 1000 LBS OPERATING WEIGHT, 4000 BTU/HR INPUT. EXHAUST FAN EF-1 "PACE" #CRE-BF (SKYCAP), 600 C.F.M. OF AIR AT .375 EXTERNAL STATIC PRESSURE, 1280 R.P.M., 1600 F.P.M., 1/3 HORSEPOWER 120 VOLT - 1 PHASE - 60 CYCLE BLOWER MOTOR COMPLETE WITH STANDARD CURB AND BIRD SCREENS. EXHAUST FAN EF-2 "PACE" #CRE-BF (SKYCAP) (TYPICAL TO EF-1)
TOILET ROOM EXHAUST FANS EXHAUST FAN EF-3 "PACE" #DD-450G, 400 C.F.M. OF AIR AT .20 INCH STATIC PRESSURE 1/10 HORSEPOWER 120 VOLT - 1 PHASE - 60 CYCLE BLOWER MOTOR, WITH STYLE 80 FACE PLATE. EXHAUST FAN EF-4 "PACE" #DD-450G, (TYPICAL TO EF-3) EXHAUST FAN EF-5 "PACE" #DD-200G, 130 C.F.M. OF AIR AT .20 INCH STATIC PRESSURE 1/30 HORSEPOWER 120 VOLT - 1 PHASE - 60 CYCLE BLOWER MOTOR, WITH STYLE 80 FACE PLATE. EXHAUST FAN EF-6 & EF-7 "PACE" #DD-200G, (TYPICAL TO EF-5)

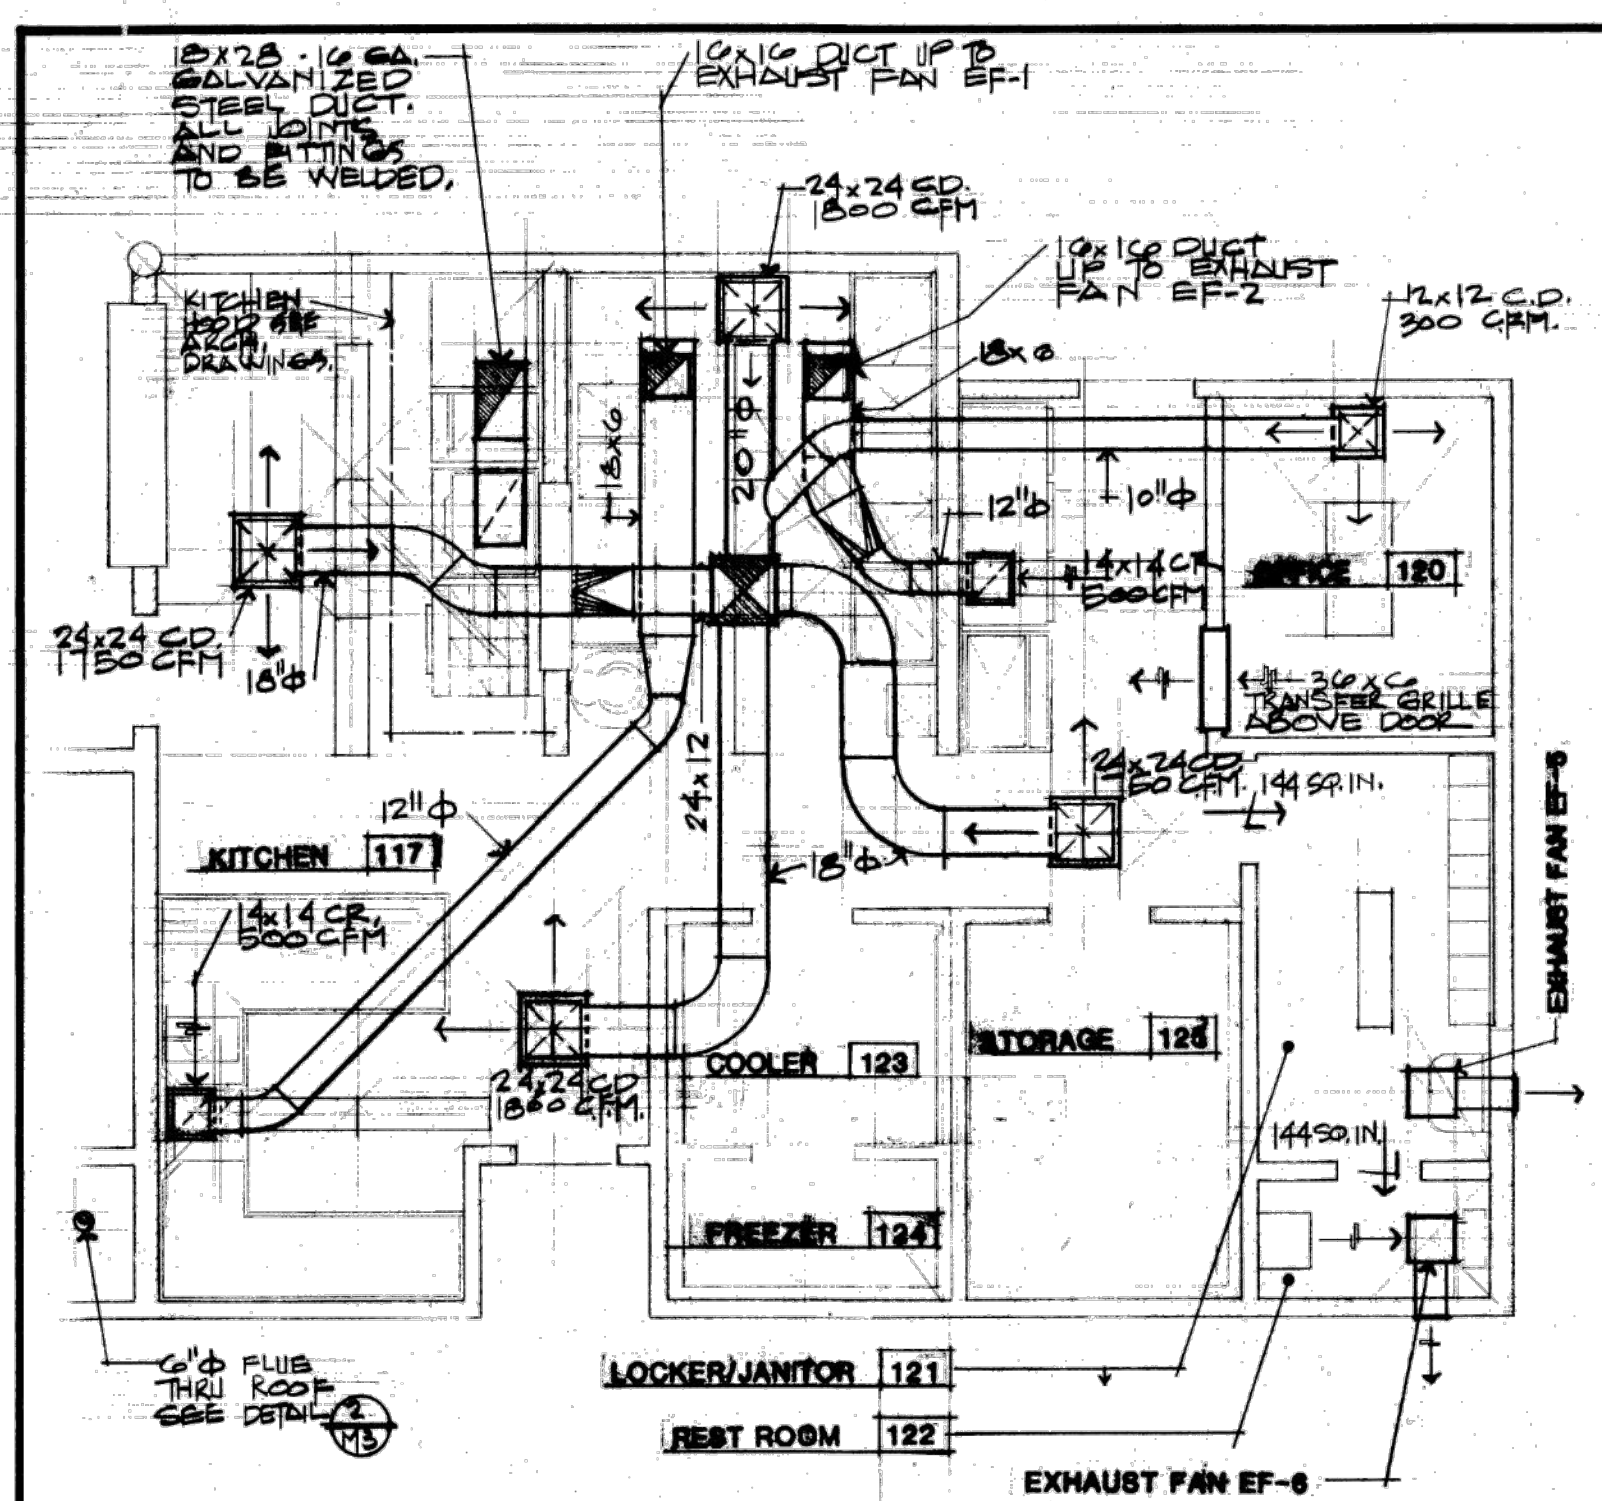



KITCHEN PLAN 1/4":1'0" 1

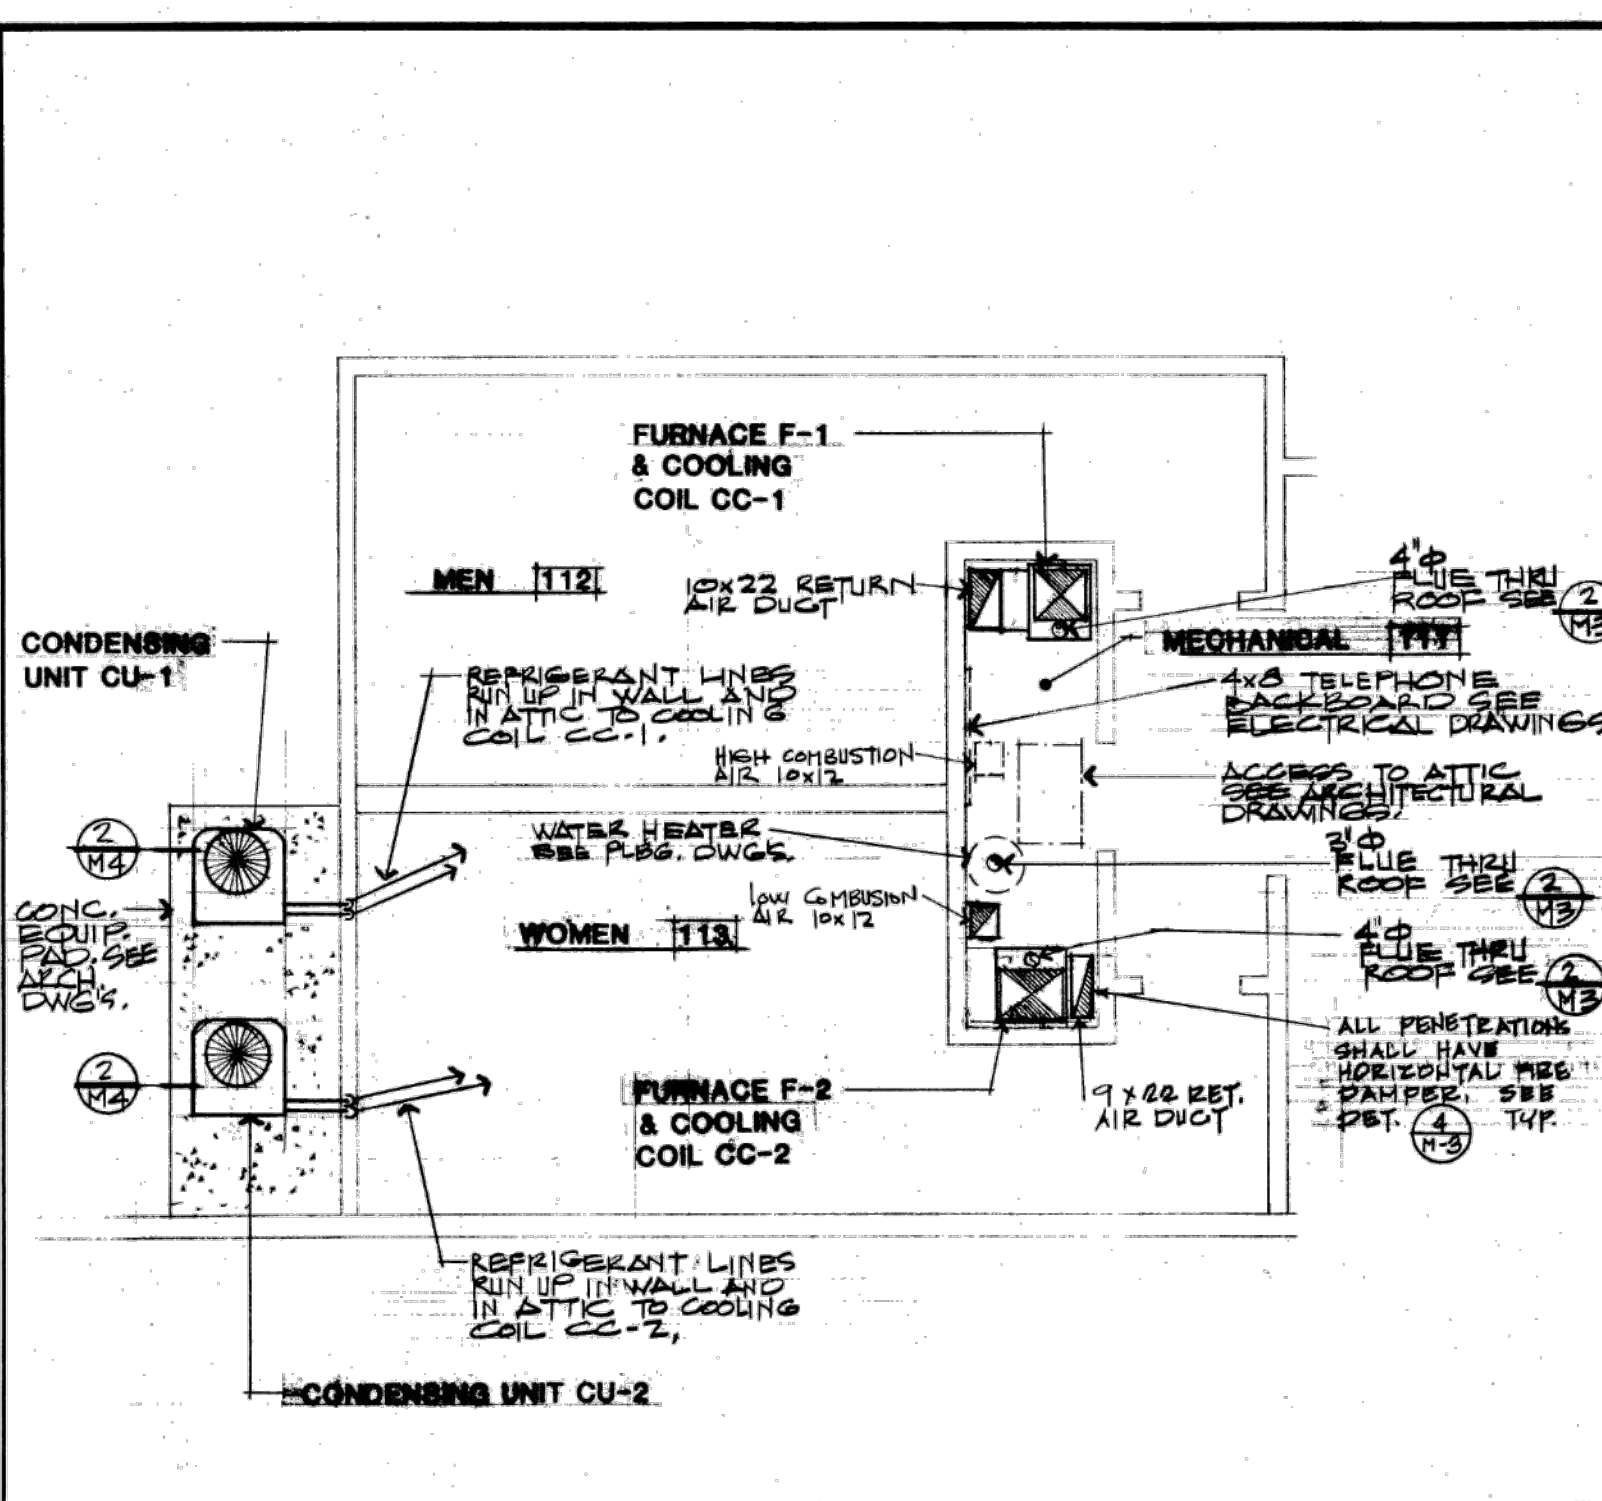



MECHANICAL ROOM 111 PLAN 1/4":1'0" 2

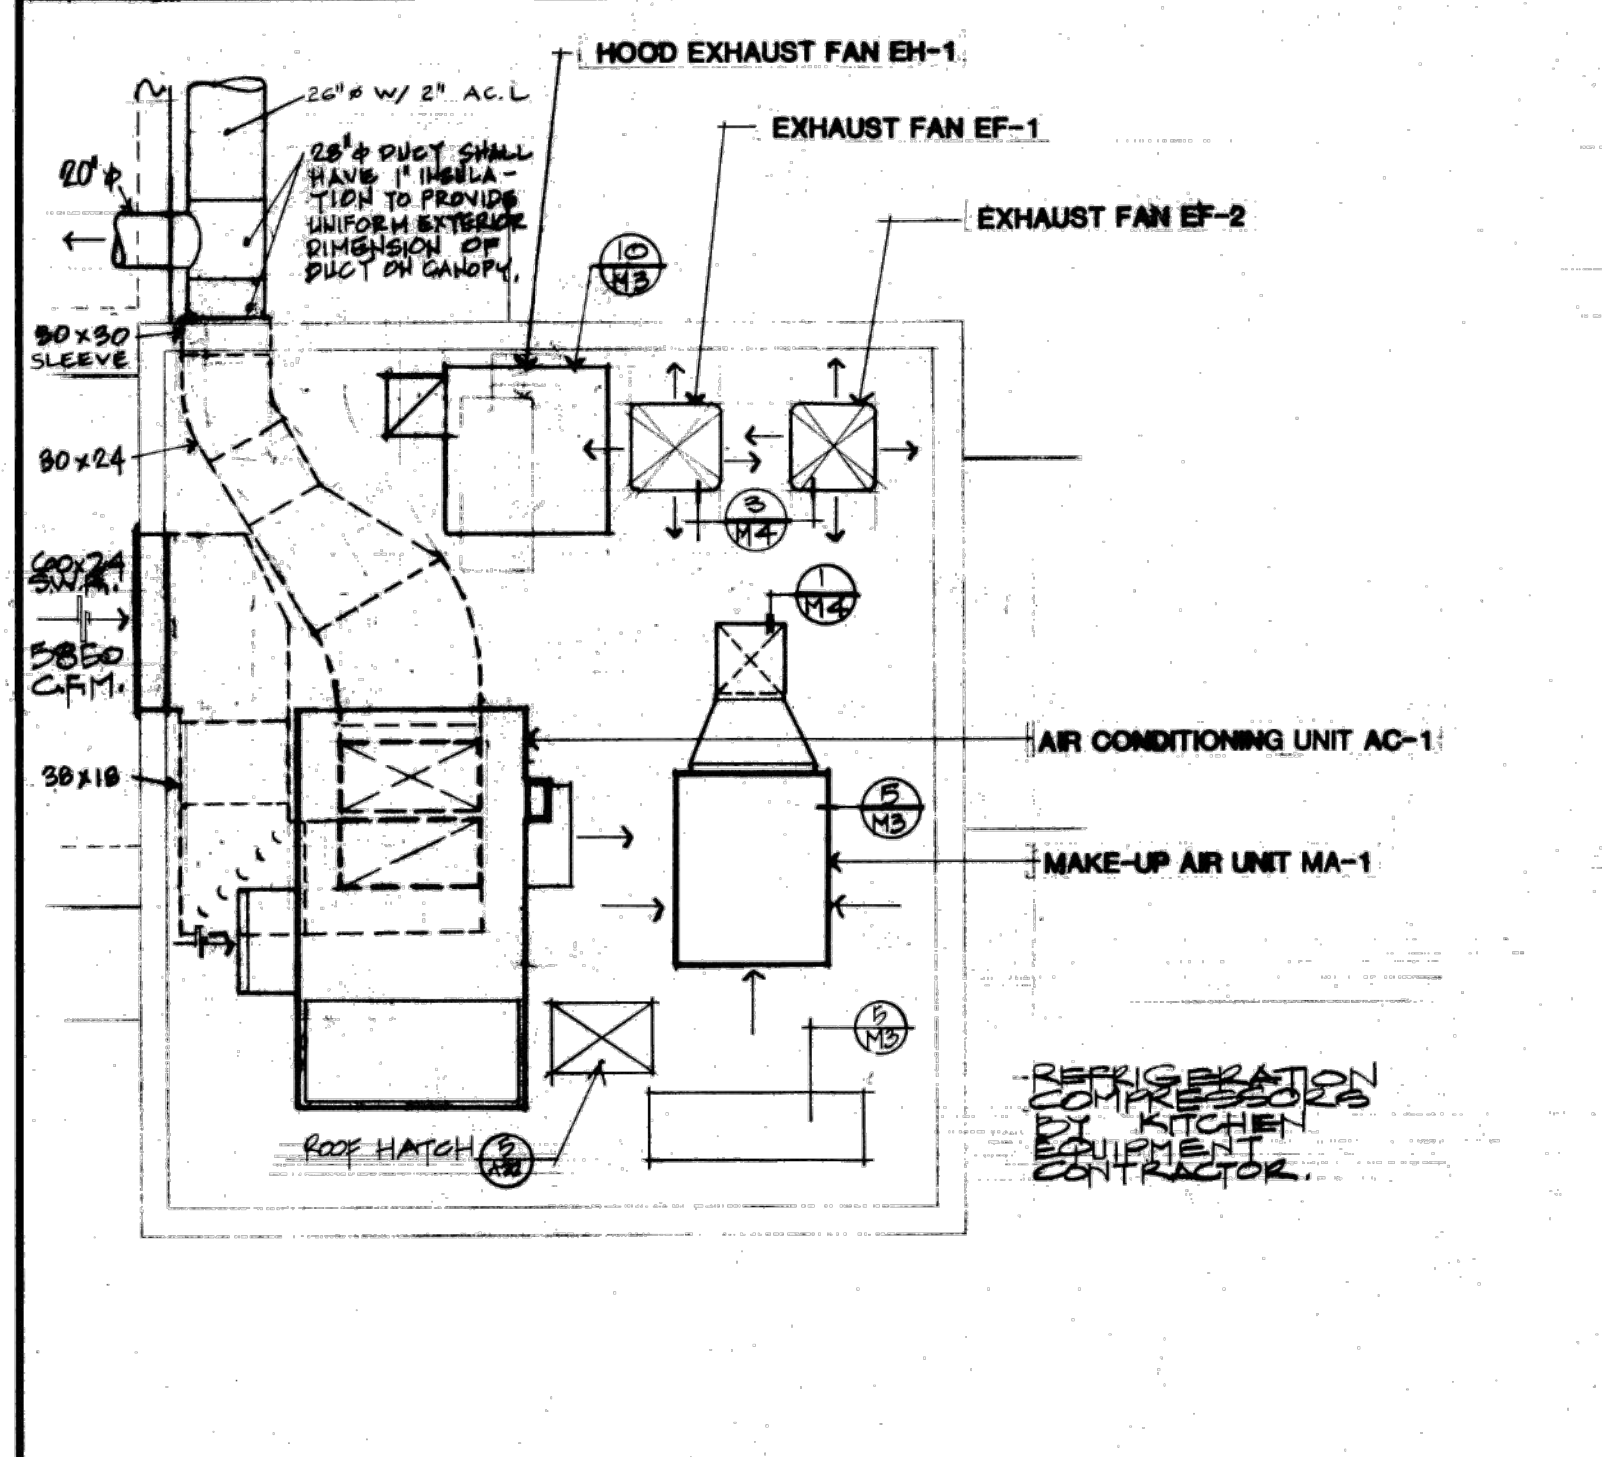

ROOF PLAN 1/4":1'0" 3

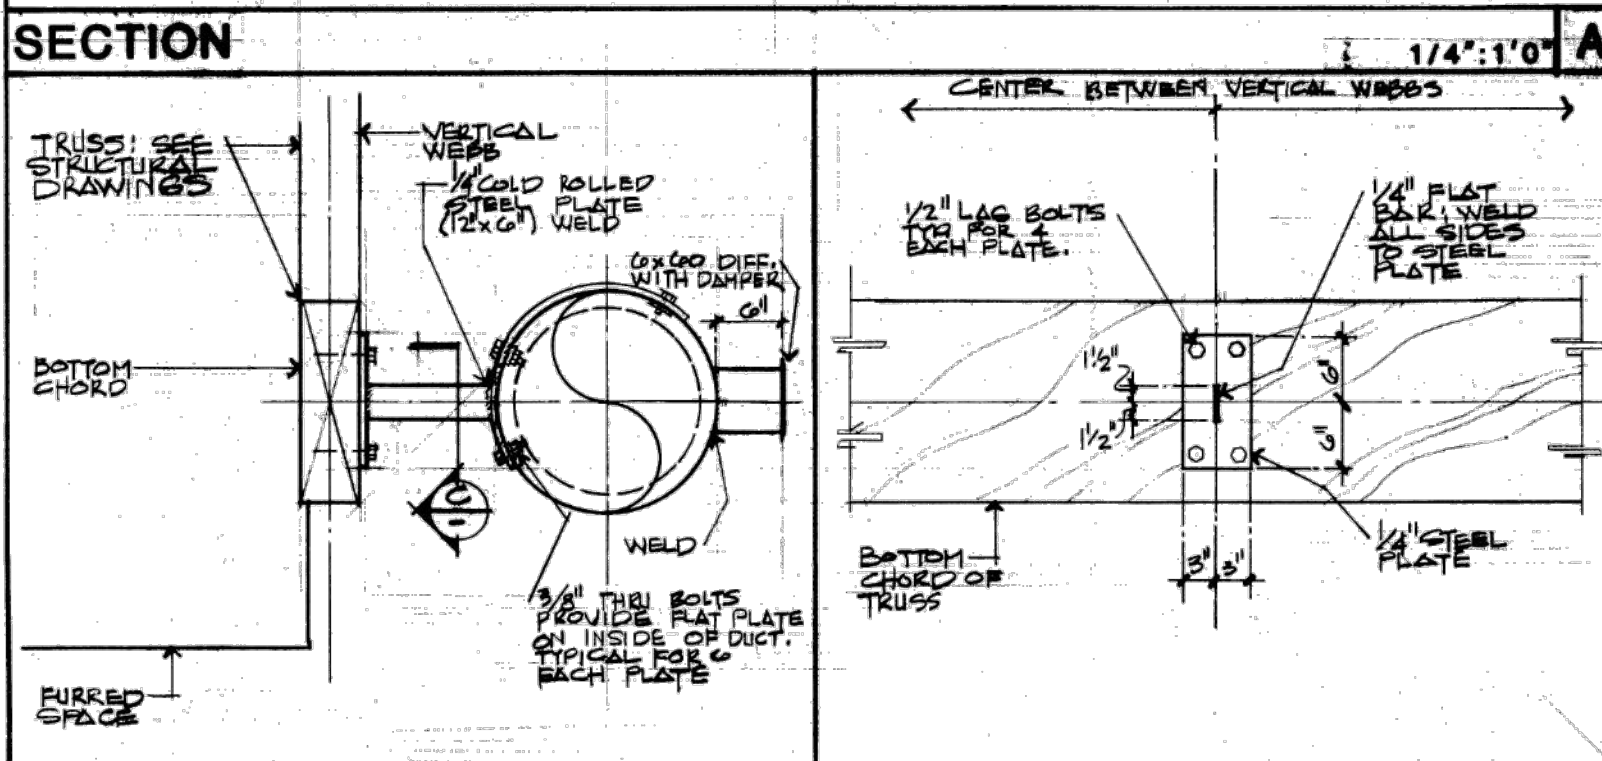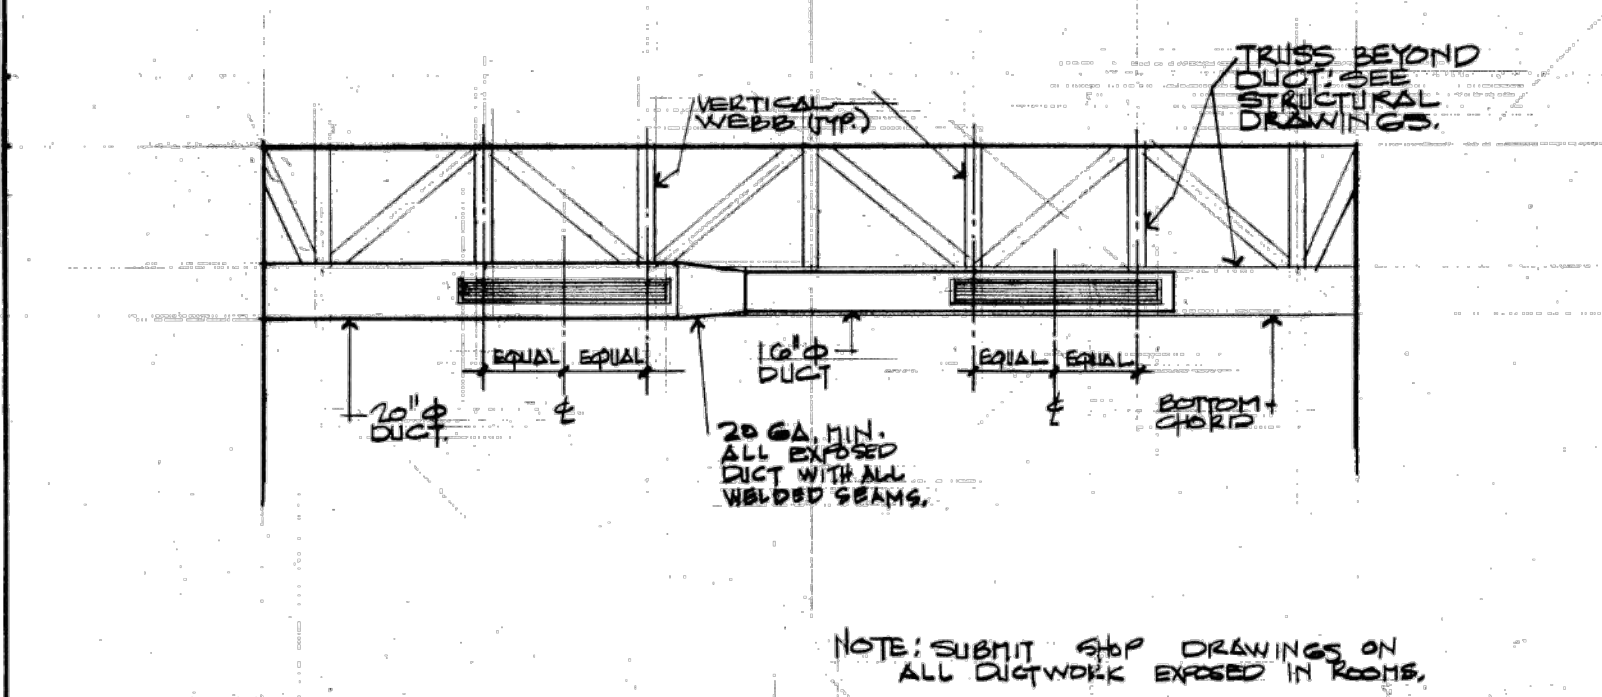

SECTION 1":1'0" B

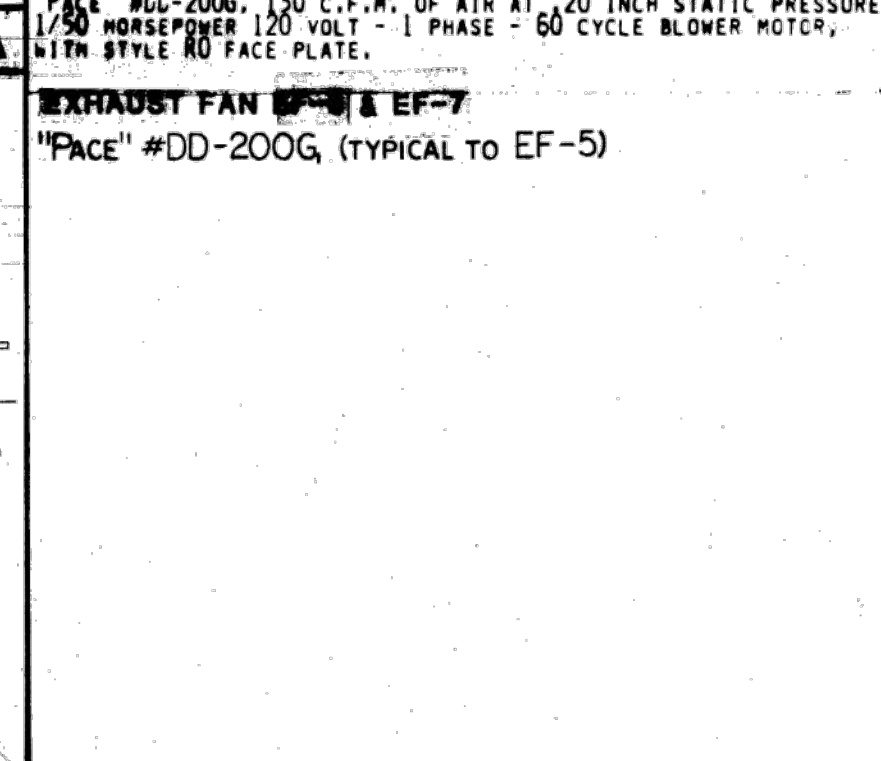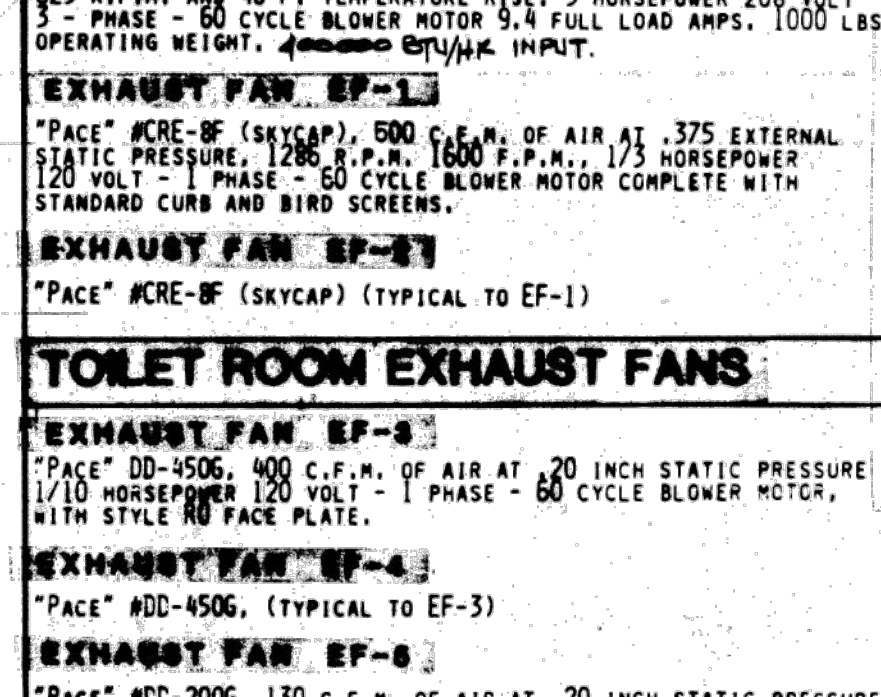


SECTION 1":1'0" C

SHEAR WALL SCHEDULE		
WALL	DESCRIPTION	ANCHORAGE HOLDDOWN
1	DELIMITED SECTION ONE (N/S) EXPOSED IN ALL FLOOR SLAB DECKS	ANCHOR AD 6400# NO. 5 @ BA END
2	DELIMITED SECTION TWO (E/W) EXPOSED IN ALL FLOOR SLAB DECKS	ANCHOR AD 6400# NO. 5 @ BA END
3	DELIMITED SECTION THREE (S/E) EXPOSED IN ALL FLOOR SLAB DECKS	ANCHOR AD 6400# NO. 5 @ BA END
4	DELIMITED SECTION FOUR (S/W) EXPOSED IN ALL FLOOR SLAB DECKS	ANCHOR AD 6400# NO. 5 @ BA END
5	DELIMITED SECTION FIVE (N/S) EXPOSED IN ALL FLOOR SLAB DECKS	ANCHOR AD 6400# NO. 5 @ BA END
6	DELIMITED SECTION SIX (E/W) EXPOSED IN ALL FLOOR SLAB DECKS	ANCHOR AD 6400# NO. 5 @ BA END
7	DELIMITED SECTION SEVEN (S/E) EXPOSED IN ALL FLOOR SLAB DECKS	ANCHOR AD 6400# NO. 5 @ BA END
8	DELIMITED SECTION EIGHT (S/W) EXPOSED IN ALL FLOOR SLAB DECKS	ANCHOR AD 6400# NO. 5 @ BA END
9	DELIMITED SECTION NINE (N/S) EXPOSED IN ALL FLOOR SLAB DECKS	ANCHOR AD 6400# NO. 5 @ BA END
10	DELIMITED SECTION TEN (E/W) EXPOSED IN ALL FLOOR SLAB DECKS	ANCHOR AD 6400# NO. 5 @ BA END
11	DELIMITED SECTION ELEVEN (S/E) EXPOSED IN ALL FLOOR SLAB DECKS	ANCHOR AD 6400# NO. 5 @ BA END
12	DELIMITED SECTION TWELVE (S/W) EXPOSED IN ALL FLOOR SLAB DECKS	ANCHOR AD 6400# NO. 5 @ BA END
13	DELIMITED SECTION THIRTEEN (N/S) EXPOSED IN ALL FLOOR SLAB DECKS	ANCHOR AD 6400# NO. 5 @ BA END
14	DELIMITED SECTION FOURTEEN (E/W) EXPOSED IN ALL FLOOR SLAB DECKS	ANCHOR AD 6400# NO. 5 @ BA END
15	DELIMITED SECTION FIFTEEN (S/E) EXPOSED IN ALL FLOOR SLAB DECKS	ANCHOR AD 6400# NO. 5 @ BA END
16	DELIMITED SECTION SIXTEEN (S/W) EXPOSED IN ALL FLOOR SLAB DECKS	ANCHOR AD 6400# NO. 5 @ BA END
17	DELIMITED SECTION SEVENTEEN (N/S) EXPOSED IN ALL FLOOR SLAB DECKS	ANCHOR AD 6400# NO. 5 @ BA END
18	DELIMITED SECTION EIGHTEEN (E/W) EXPOSED IN ALL FLOOR SLAB DECKS	ANCHOR AD 6400# NO. 5 @ BA END
19	DELIMITED SECTION NINETEEN (S/E) EXPOSED IN ALL FLOOR SLAB DECKS	ANCHOR AD 6400# NO. 5 @ BA END
20	DELIMITED SECTION TWENTY (S/W) EXPOSED IN ALL FLOOR SLAB DECKS	ANCHOR AD 6400# NO. 5 @ BA END
21	DELIMITED SECTION TWENTY-ONE (N/S) EXPOSED IN ALL FLOOR SLAB DECKS	ANCHOR AD 6400# NO. 5 @ BA END
22	DELIMITED SECTION TWENTY-TWO (E/W) EXPOSED IN ALL FLOOR SLAB DECKS	ANCHOR AD 6400# NO. 5 @ BA END
23	DELIMITED SECTION TWENTY-THREE (S/E) EXPOSED IN ALL FLOOR SLAB DECKS	ANCHOR AD 6400# NO. 5 @ BA END
24	DELIMITED SECTION TWENTY-FOUR (S/W) EXPOSED IN ALL FLOOR SLAB DECKS	ANCHOR AD 6400# NO. 5 @ BA END
25	DELIMITED SECTION TWENTY-FIVE (N/S) EXPOSED IN ALL FLOOR SLAB DECKS	ANCHOR AD 6400# NO. 5 @ BA END
26	DELIMITED SECTION TWENTY-SIX (E/W) EXPOSED IN ALL FLOOR SLAB DECKS	ANCHOR AD 6400# NO. 5 @ BA END
27	DELIMITED SECTION TWENTY-SEVEN (S/E) EXPOSED IN ALL FLOOR SLAB DECKS	ANCHOR AD 6400# NO. 5 @ BA END
28	DELIMITED SECTION TWENTY-EIGHT (S/W) EXPOSED IN ALL FLOOR SLAB DECKS	ANCHOR AD 6400# NO. 5 @ BA END
29	DELIMITED SECTION TWENTY-NINE (N/S) EXPOSED IN ALL FLOOR SLAB DECKS	ANCHOR AD 6400# NO. 5 @ BA END
30	DELIMITED SECTION THIRTY (E/W) EXPOSED IN ALL FLOOR SLAB DECKS	ANCHOR AD 6400# NO. 5 @ BA END
31	DELIMITED SECTION THIRTY-ONE (S/E) EXPOSED IN ALL FLOOR SLAB DECKS	ANCHOR AD 6400# NO. 5 @ BA END
32	DELIMITED SECTION THIRTY-TWO (S/W) EXPOSED IN ALL FLOOR SLAB DECKS	ANCHOR AD 6400# NO. 5 @ BA END
33	DELIMITED SECTION THIRTY-THREE (N/S) EXPOSED IN ALL FLOOR SLAB DECKS	ANCHOR AD 6400# NO. 5 @ BA END
34	DELIMITED SECTION THIRTY-FOUR (E/W) EXPOSED IN ALL FLOOR SLAB DECKS	ANCHOR AD 6400# NO. 5 @ BA END
35	DELIMITED SECTION THIRTY-FIVE (S/E) EXPOSED IN ALL FLOOR SLAB DECKS	ANCHOR AD 6400# NO. 5 @ BA END
36	DELIMITED SECTION THIRTY-SIX (S/W) EXPOSED IN ALL FLOOR SLAB DECKS	ANCHOR AD 6400# NO. 5 @ BA END
37	DELIMITED SECTION THIRTY-SEVEN (N/S) EXPOSED IN ALL FLOOR SLAB DECKS	ANCHOR AD 6400# NO. 5 @ BA END
38	DELIMITED SECTION THIRTY-EIGHT (E/W) EXPOSED IN ALL FLOOR SLAB DECKS	ANCHOR AD 6400# NO. 5 @ BA END
39	DELIMITED SECTION THIRTY-NINE (S/E) EXPOSED IN ALL FLOOR SLAB DECKS	ANCHOR AD 6400# NO. 5 @ BA END
40	DELIMITED SECTION FORTY (S/W) EXPOSED IN ALL FLOOR SLAB DECKS	ANCHOR AD 6400# NO. 5 @ BA END
41	DELIMITED SECTION FORTY-ONE (N/S) EXPOSED IN ALL FLOOR SLAB DECKS	ANCHOR AD 6400# NO. 5 @ BA END
42	DELIMITED SECTION FORTY-TWO (E/W) EXPOSED IN ALL FLOOR SLAB DECKS	ANCHOR AD 6400# NO. 5 @ BA END
43	DELIMITED SECTION FORTY-THREE (S/E) EXPOSED IN ALL FLOOR SLAB DECKS	ANCHOR AD 6400# NO. 5 @ BA END
44	DELIMITED SECTION FORTY-FOUR (S/W) EXPOSED IN ALL FLOOR SLAB DECKS	ANCHOR AD 6400# NO. 5 @ BA END
45	DELIMITED SECTION FORTY-FIVE (N/S) EXPOSED IN ALL FLOOR SLAB DECKS	ANCHOR AD 6400# NO. 5 @ BA END
46	DELIMITED SECTION FORTY-SIX (E/W) EXPOSED IN ALL FLOOR SLAB DECKS	ANCHOR AD 6400# NO. 5 @ BA END
47	DELIMITED SECTION FORTY-SEVEN (S/E) EXPOSED IN ALL FLOOR SLAB DECKS	ANCHOR AD 6400# NO. 5 @ BA END
48	DELIMITED SECTION FORTY-EIGHT (S/W) EXPOSED IN ALL FLOOR SLAB DECKS	ANCHOR AD 6400# NO. 5 @ BA END
49	DELIMITED SECTION FORTY-NINE (N/S) EXPOSED IN ALL FLOOR SLAB DECKS	ANCHOR AD 6400# NO. 5 @ BA END
50	DELIMITED SECTION FIFTY (E/W) EXPOSED IN ALL FLOOR SLAB DECKS	ANCHOR AD 6400# NO. 5 @ BA END

FOOTING SCHEDULE			
FTG	SIZE	THICKNESS	REINFT
1	3'-0" x 3'-0"	15"	3-#4 @ BA WAY
2	3'-0" x 3'-0"	15"	4-#4 @ BA WAY
3	4'-0" x 4'-0"	15"	4-#4 @ BA WAY

FOUNDATION NOTES	
1.	PRIOR TO POURING CONCRETE, THE FOUNDATION EXCAVATIONS SHALL BE INSPECTED BY THE BUILDING DEPARTMENT INSPECTOR.
2.	SEE ARCHITECTURAL DRAWINGS FOR ALL SITE WORK.
3.	ALL SLEEVES BELOW FOOTINGS MUST BE POURED-IN-PLACE PRIOR TO POURING FOOTINGS.
4.	ALL ELECTRICAL AND PLUMBING LOCATIONS MUST BE VERIFIED WITH THE OWNER PRIOR TO POURING SLAB.
5.	FOR INTERIOR FLOOR SLAB DEPRESSIONS, FLOOR DRAINS, ETC. SEE ARCHITECTURAL DRAWINGS PRIOR TO POURING SLAB.
6.	ALL ELECTRICAL, PLUMBING AND OTHER UNDERGROUND WORK SHALL CONFORM TO DETAIL (S1).
7.	STEP FOOTINGS AS REQUIRED AS PER DETAIL (S2).
8.	PROVIDE INTERIOR SLAB CONTROL JOINTS AS PER DETAIL (S3).
9.	NO WOOD OR STEEL STAKES SHALL BE PERMITTED IN FOOTINGS.
10.	○ INDICATES FOOTING PAD; FOR SIZE AND REINFORCING REQUIRED, SEE FOOTING SCHEDULE ON THIS SHEET.
11.	ALL SITE PREPARATION, EXCAVATION AND COMPACTION SHALL BE DONE UNDER THE SUPERVISION OF THE SOILS ENGINEER.

FRAMING NOTES	
1.	FOR SIZE AND LOCATION OF ROOF OPENINGS, SEE ARCHITECTURAL AND MECHANICAL DRAWINGS.
2.	ALL STEEL EXPOSED TO WEATHER SHALL BE HOT-DIP GALVANIZED AFTER FABRICATION.
3.	ROOF TRUSS FABRICATOR SHALL SUBMIT FRAMING LAYOUT, DETAILS AND CALCULATIONS OF THE PROPOSED SYSTEM TO THE STRUCTURAL ENGINEER FOR REVIEW, AND TO THE BUILDING DEPARTMENT FOR APPROVAL. PRIOR TO THE FABRICATION, THE FRAMING LAYOUT, DETAILS AND CALCULATIONS SHALL BE SIGNED BY A CALIFORNIA REGISTERED CIVIL OR STRUCTURAL ENGINEER.
4.	ROOF TRUSS FABRICATOR SHALL VERIFY THE EXACT SIZE, WEIGHT, AND LOCATION OF ALL MECHANICAL EQUIPMENT. DETAILS SHALL BE SUBMITTED FOR THE METHOD OF SUPPORT FOR THE ADDITIONAL LOAD.
5.	FOR ROOF TRUSS DESIGN: ROOF DEAD LOAD IS $\frac{1}{2}$ PSF AND LIVE LOAD IS $\frac{1}{2}$ PSF.
6.	FOR ROOF OPENING SEE DETAIL (S4).
7.	FOR TOP PLATES SPLICE, SEE DETAIL (S5).

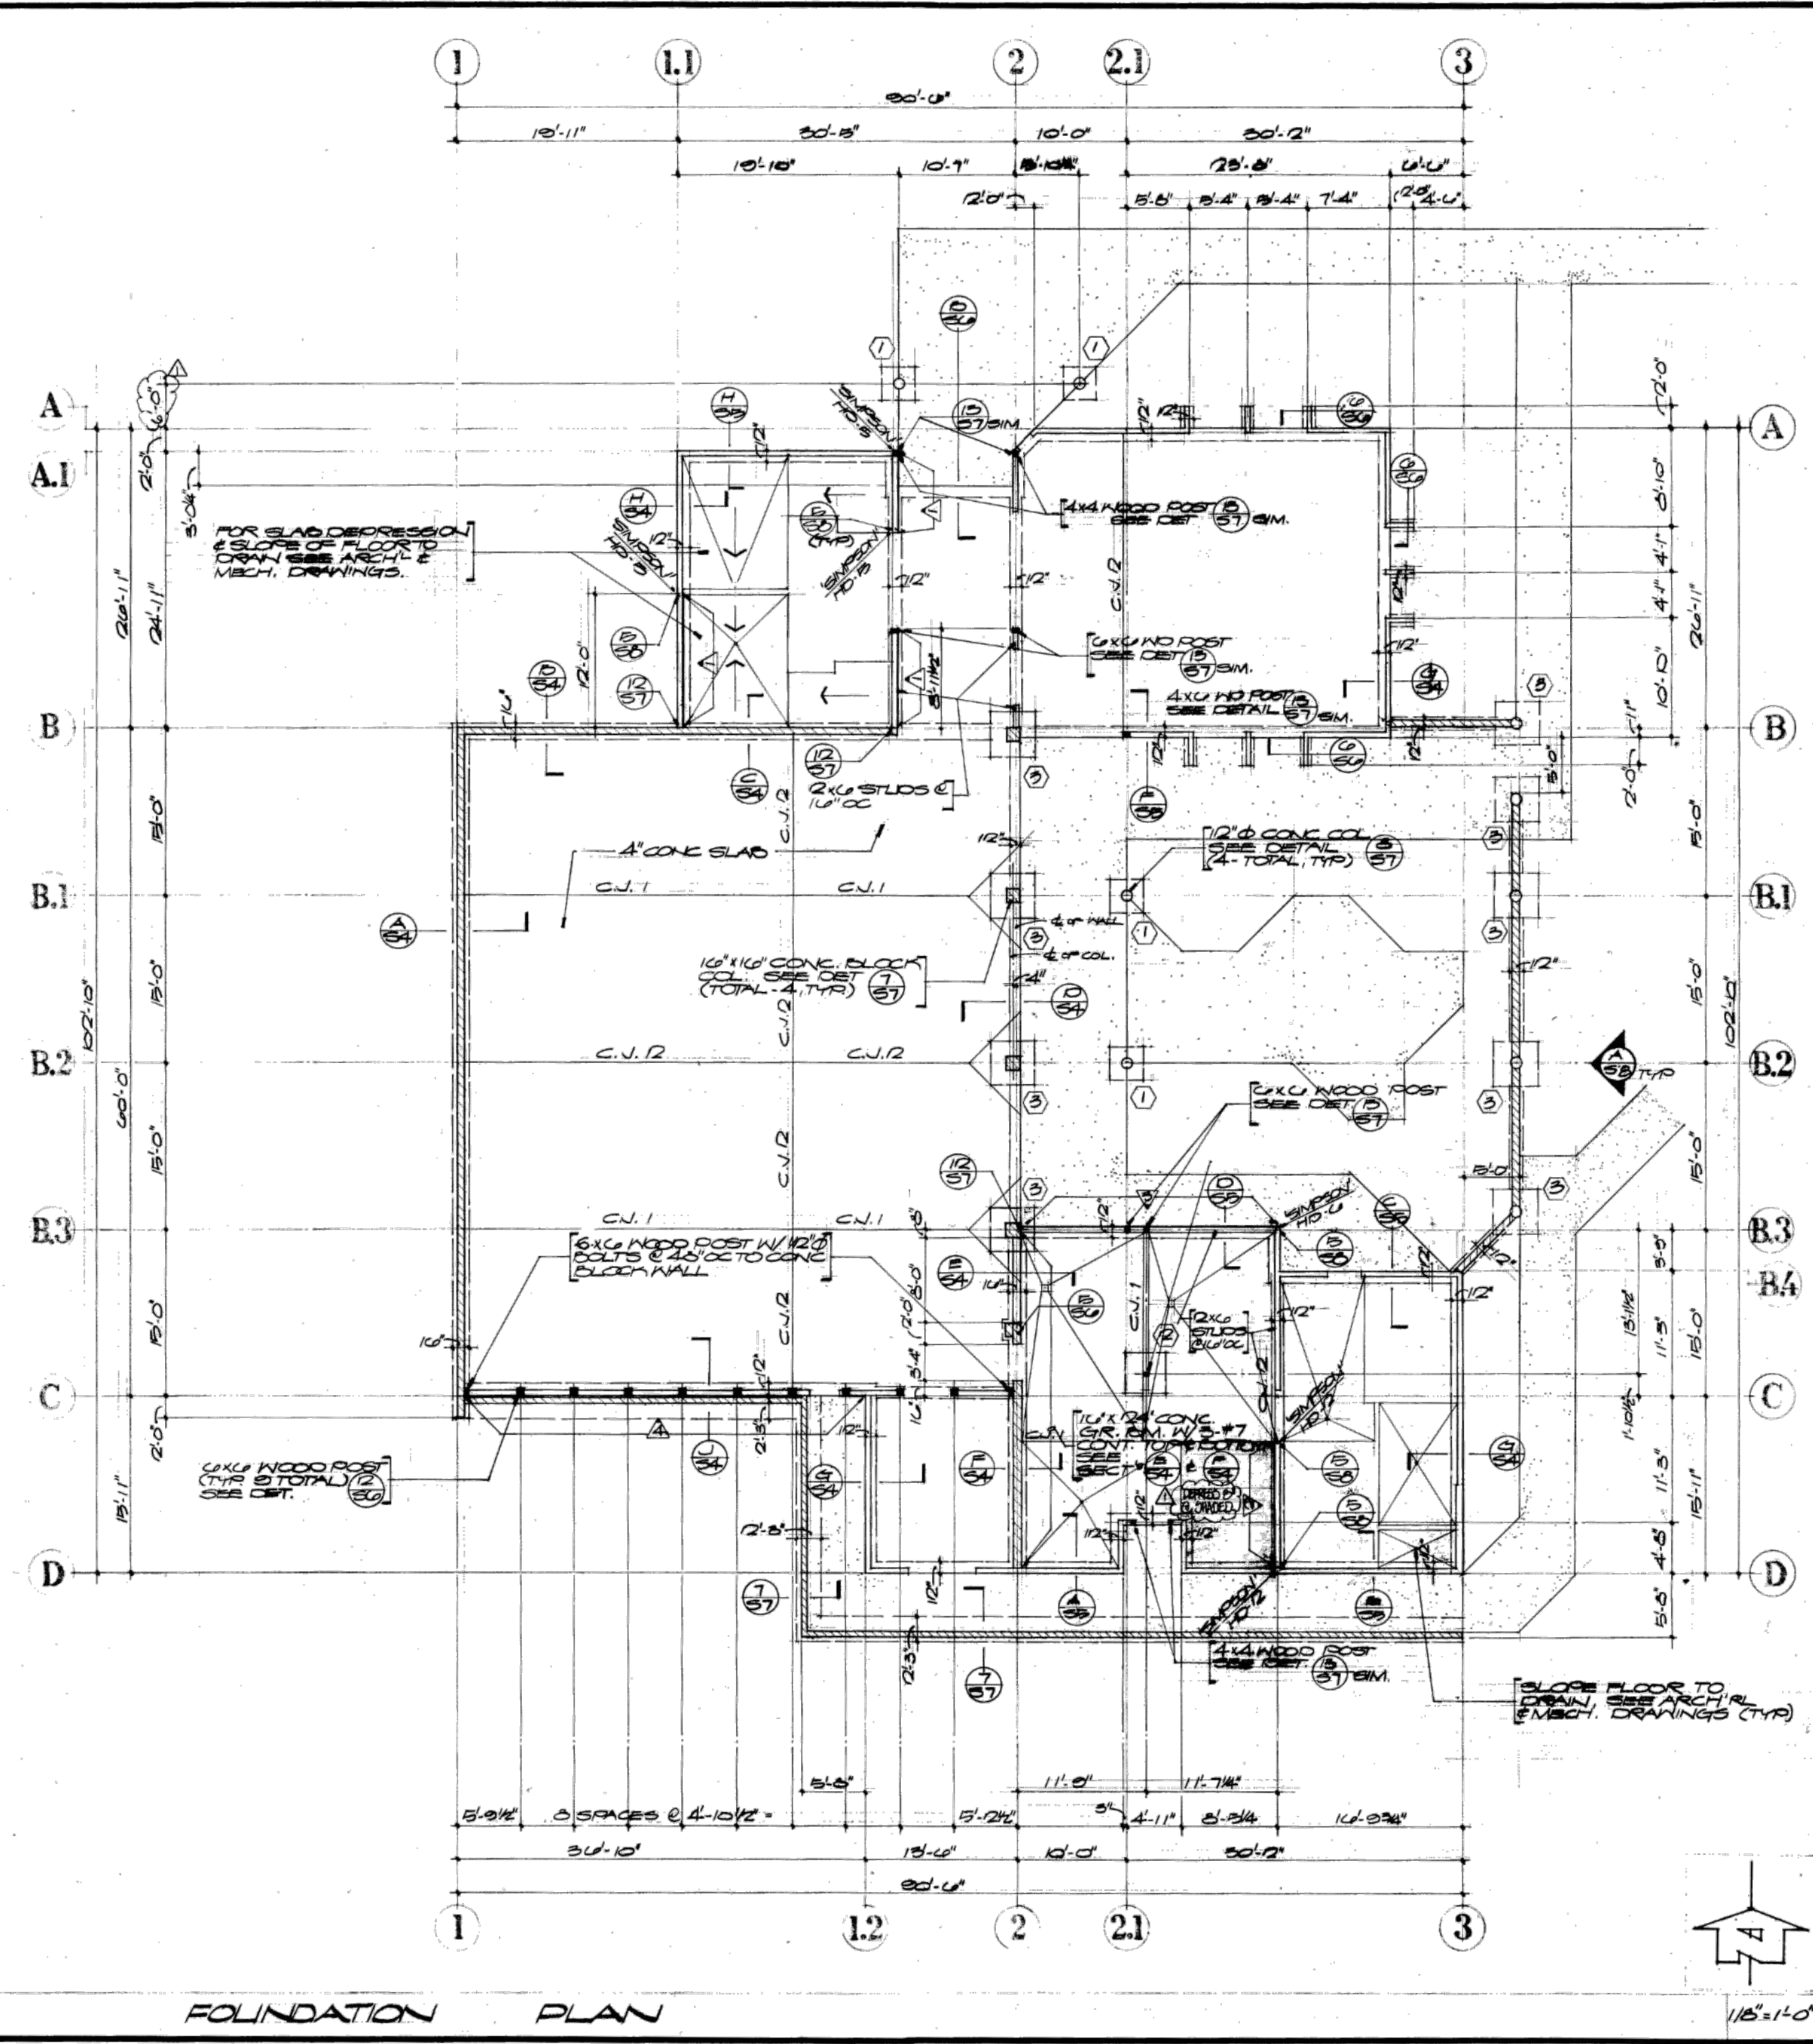

B. BARMAKIAN WOLFF-LANG CHRISTOPHER ARCHITECTS

101 ARCHCENTER 8075 ARCHIBUILD - RANCHO CALAMONKA, CALIFORNIA 91720 714-987-0909

Yucca Valley Senior Center

Approved Engineer, Inc.
1275 Archibuild Way, Suite 200
Brea, California, CA 91720
(714) 987-2744

APPROVED


APPROVED

NO	DATE	BY	REVISION	REMARKS
1	9-24-81	RECORD	DRAWING	

FOUNDATION PLAN

DRAWN BY: [initials]	S-2
CHECKED: [initials]	
DATE: 9-24-81	
SCALE: AS SHOWN	

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2900 BRISTOL STREET COSTA MESA, CALIFORNIA 92626
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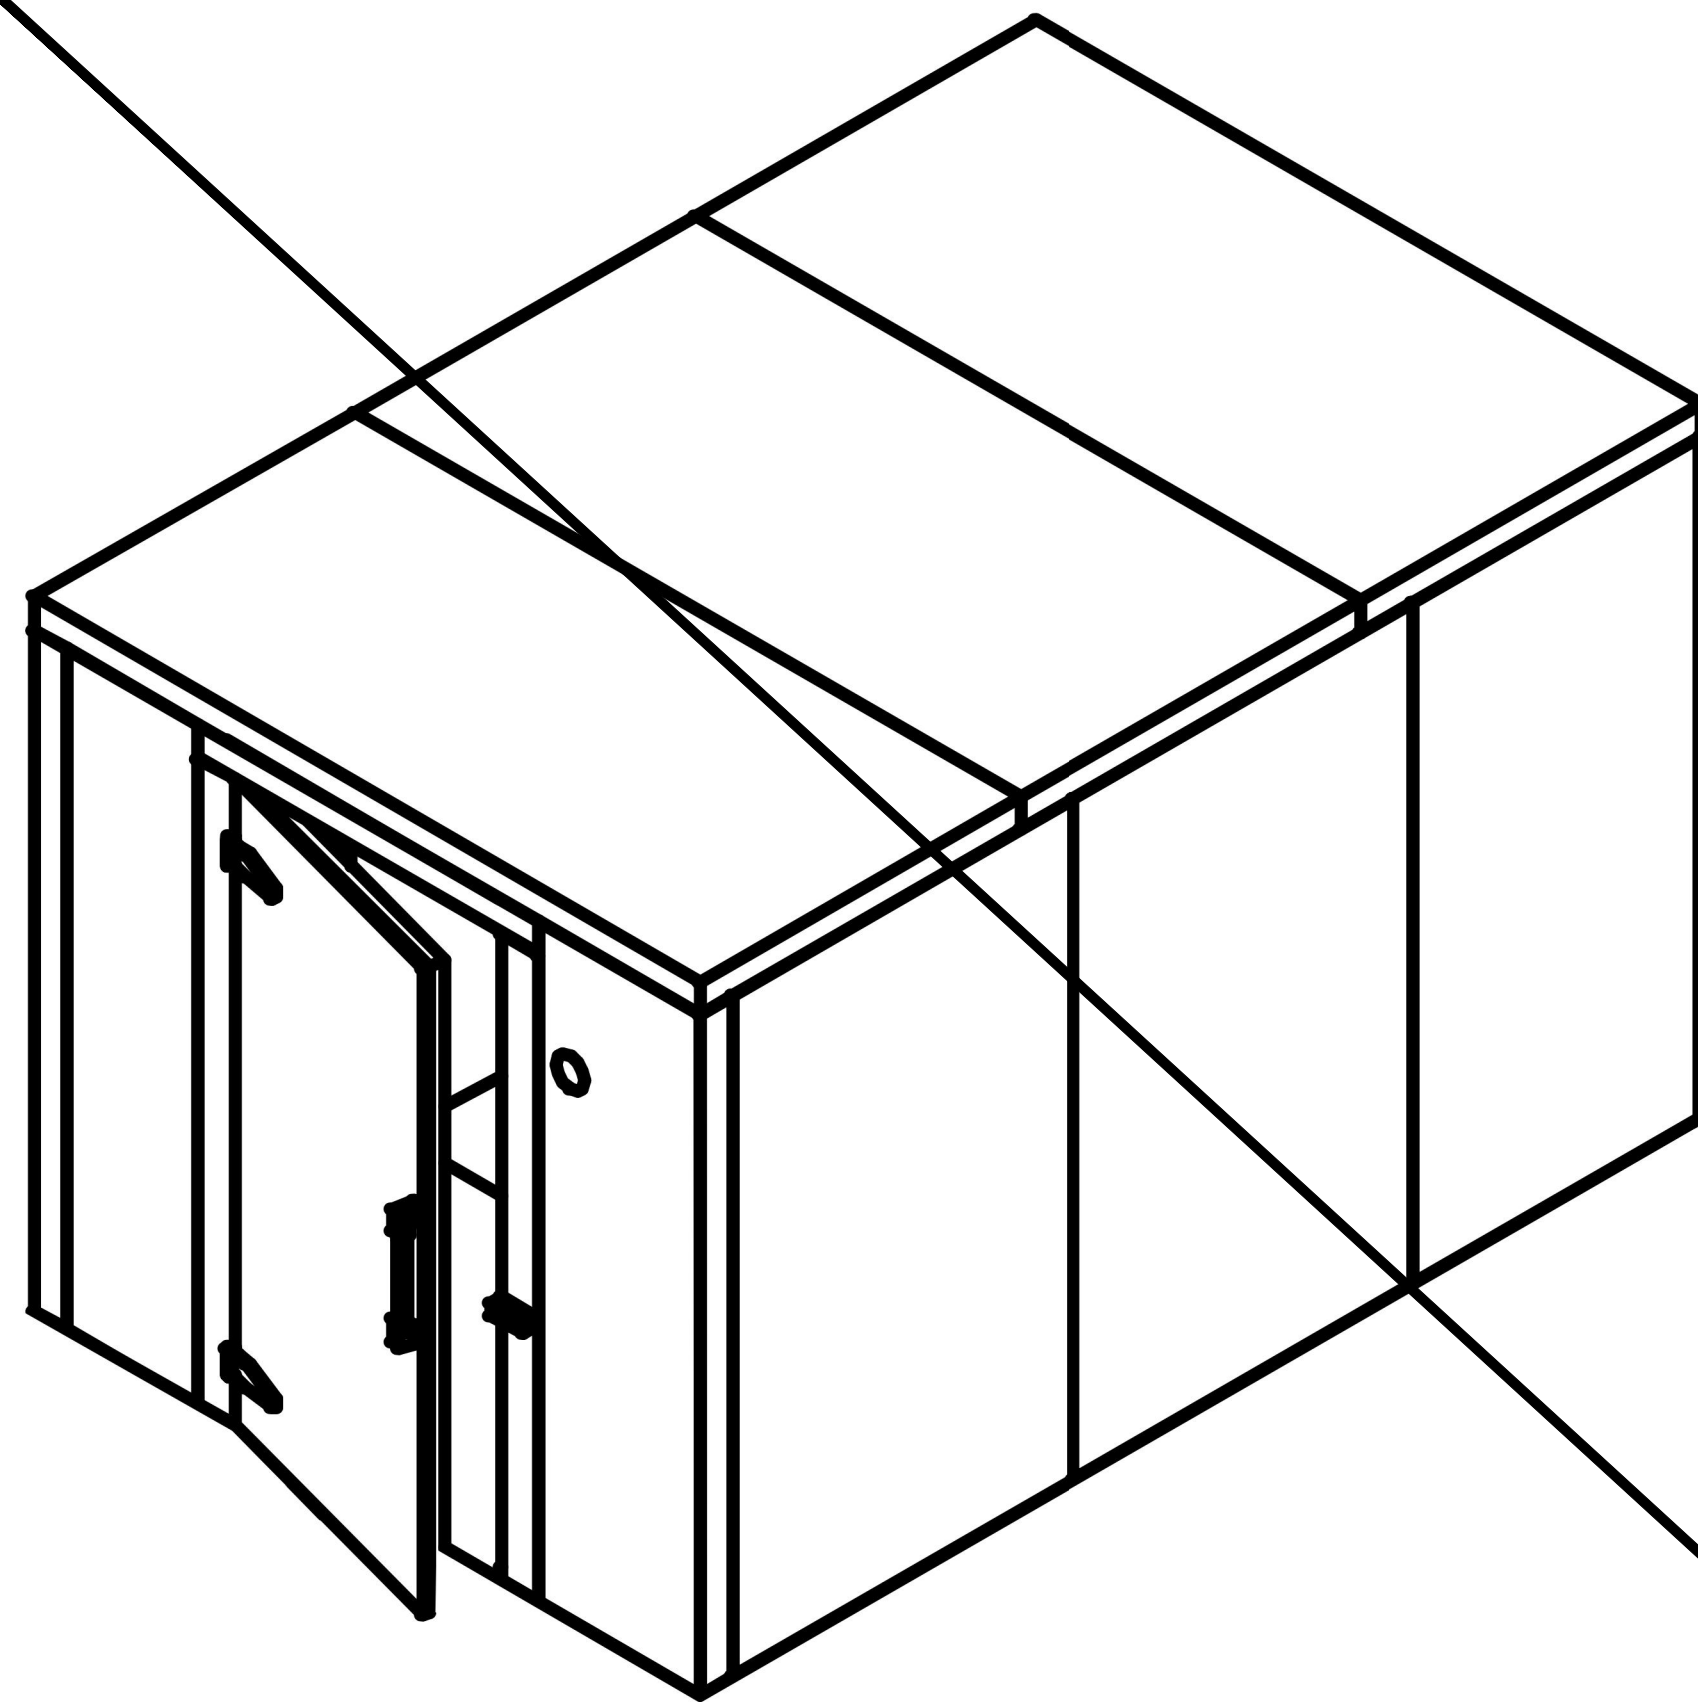
CONSTRUCTION SET

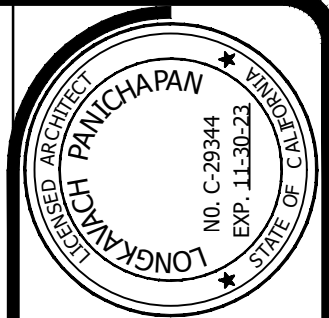DATE: 01/13/2022
BLDG. DEPT. CORRECT.
JOB NO.: 4107
DRAWN BY: STAFF
CHECKED BY: LP
SCALE: N.T.S.


REFERENCE SHEET

TOWN OF YUCCA VALLEY
Senior Center - Kitchen Equipment Upgrades

A-6.2



NOT A PART - TO BE
PURCHASED UNDER
SEPARATE CONTRACT

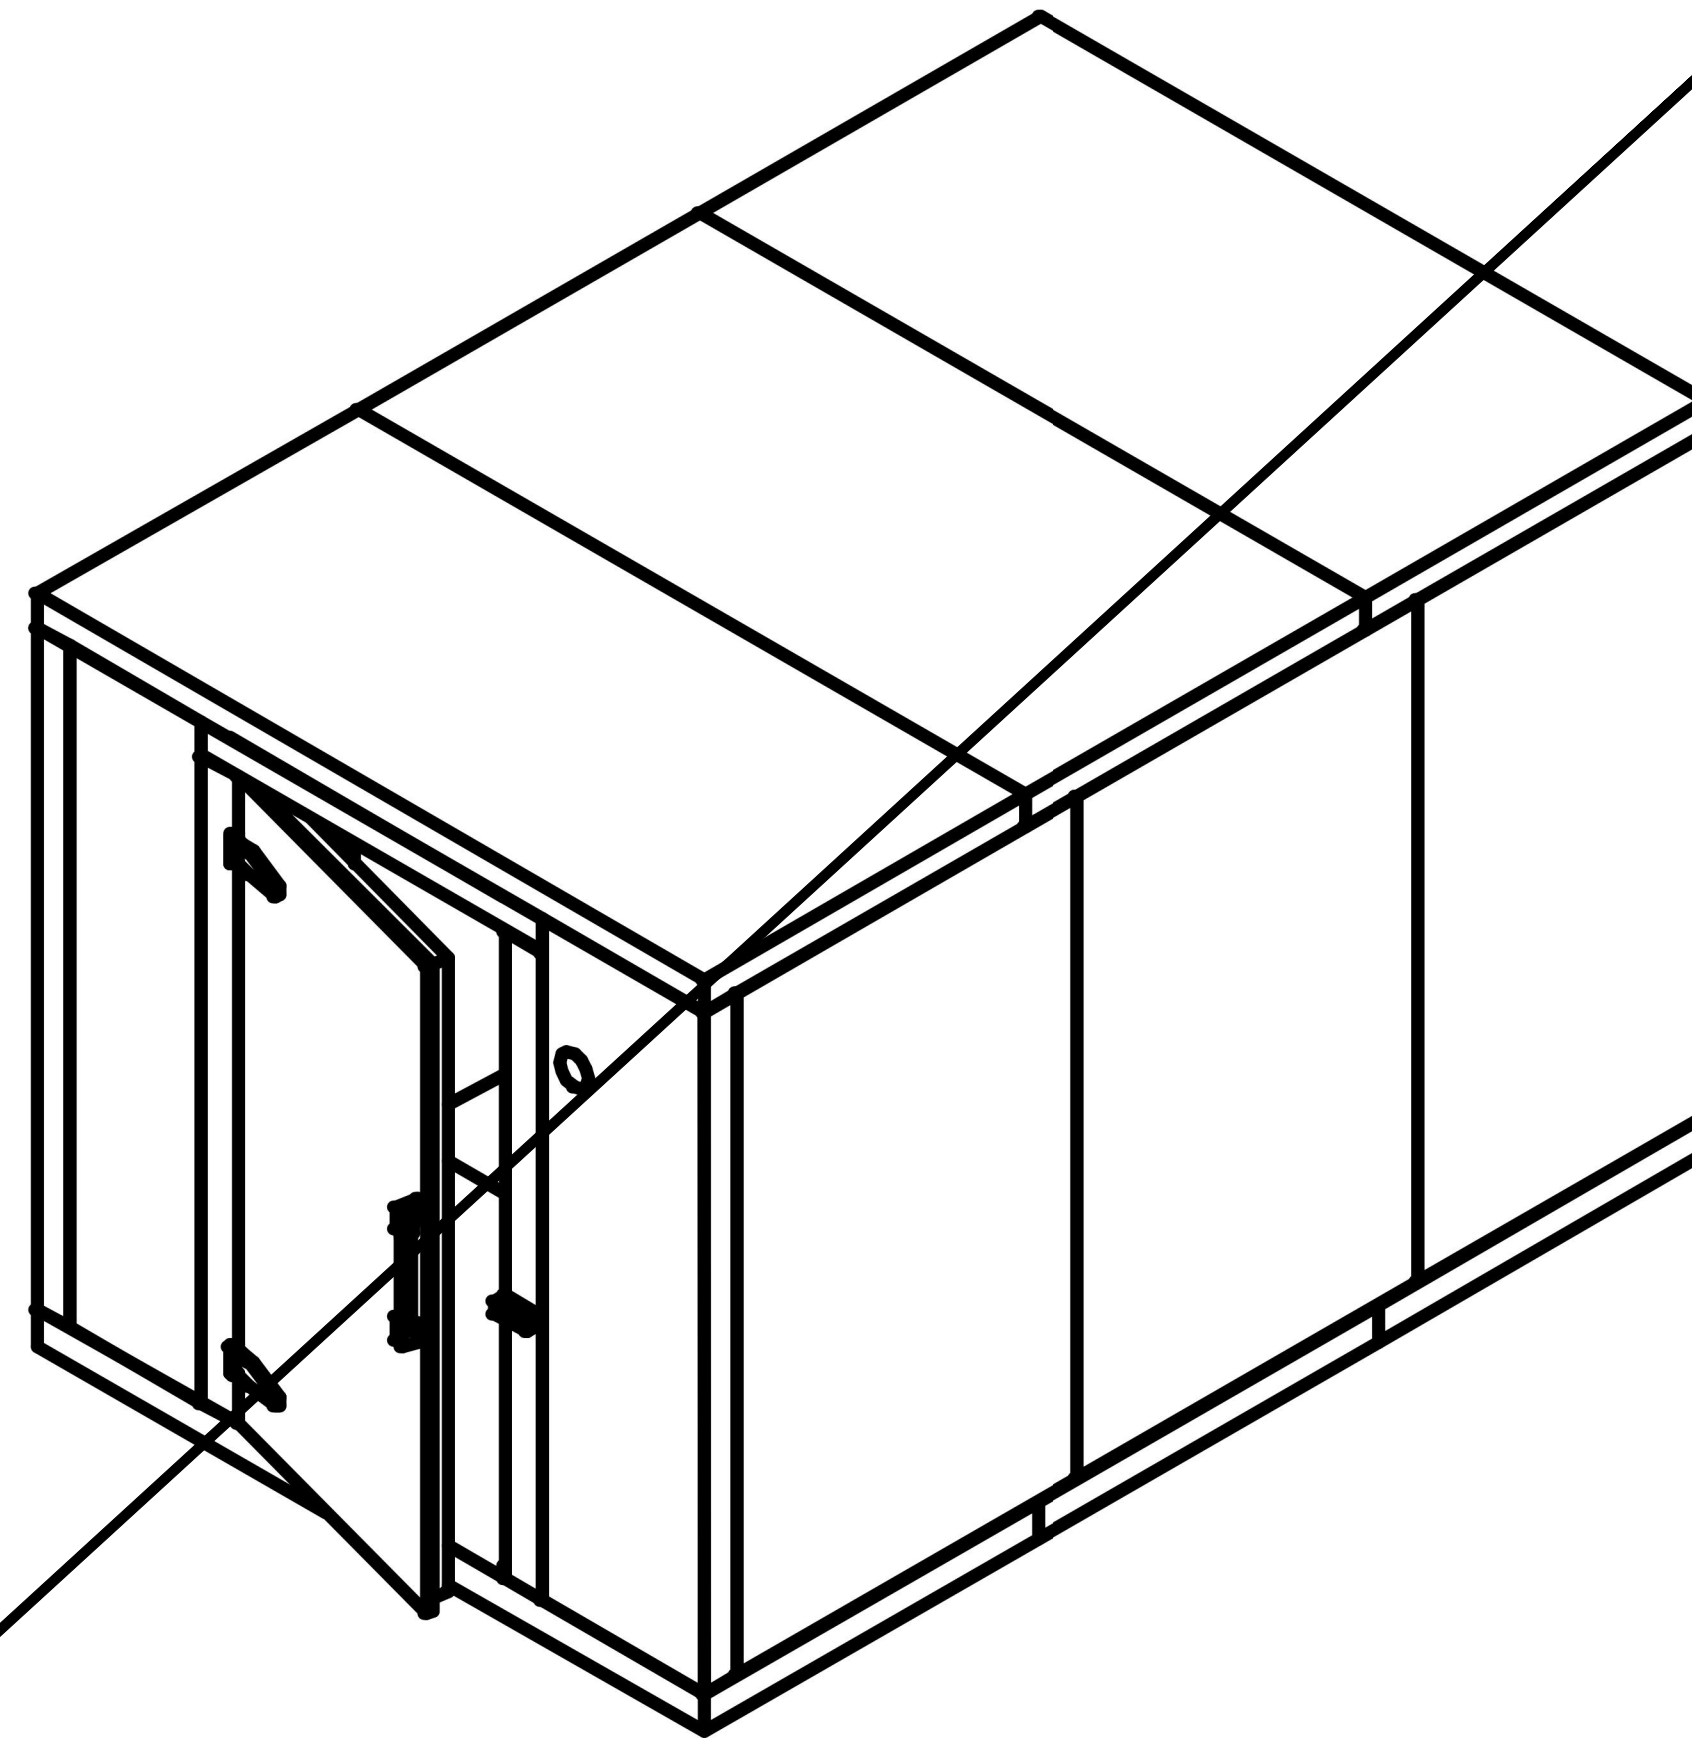

01 WALK-IN COOLER
A-7.1 Scale : N.T.S.

02 WALK-IN FREEZER
A-7.1 Scale : N.T.S.

BASIS OF DESIGN: U.S. COOLER

- SPECIFICATIONS:**
- U.S. COOLER MODEL NO. 525627
 - 1 FASTCOOLER STD. NOM. WALK-IN COOLER: 4" EXTRUDED POLYSTYRENE, STUCCO EMBOSSED GALVALUME 26 GAUGE EXTERIOR, STUCCO EMBOSSED GALVALUME 26 GAUGE INTERIOR, NSF APPROVED.
 - 1 DOOR, GREY VINYL SCREENING AT THE DOOR, (1) 24"X 76" MED TEMP INSIDE, WITHOUT FLOOR, VERT-ERGO HANDLE, LED LIGHT, LED THERMOMETER, SWITCH, DOOR CLOSER AND ADJUSTABLE SPRING LOADED HINGES.
 - 1 REFRIGERATION
 - 1 CONDENSING UNIT:
 - MANUFACTURER: RUSSELL
 - DESCRIPTION: PRE-ASSEMBLED REMOTE MED TEMP R448A AIR COOLED OUTDOOR CONDENSING UNIT
 - MODEL: RFH080E4SDA
 - COMPRESSOR: 3/4 HP, HERMETIC
 - EXTRAS: LIQUID LINE FILTER DRIER, SIGHT GLASS - INCLUDED
 - ELECTRICAL: 208-230/1PHASE/60HZ RLA: 6.1 MOPD: 15 MCA: 15
 - CONDITIONS: BTUH: 6170 ROOM TEMP: 35°F COND AMBIENT: 110°F
 - SIZING BOX: 5493 BTUH NEEDED FOR MAX. 10'-9 1/4"D X 7'-10"W X 7'-6"H (APPROX.)
 - ROOM CLEARANCE: DEPTH: 11'-6", WIDTH: 8'-5", HEIGHT: 8'-0"
 - SIZING PRODUCT: 920LBS OF MISC PRODUCT ENTERING AT 55°F
 - WARRANTY:
 - PARTS: 1-YEAR STANDARD MANUFACTURER
 - 1 EVAPORATOR (UNIT COOLER):
 - MANUFACTURER: RUSSELL
 - DESCRIPTION: PRE-ASSEMBLED AIR DEFROST LOW PROFILE COIL
 - MODEL: RL6A052ADA
 - EXTRAS: EXPANSION VALVE (ERVE-1/3-C), SOLENOID VALVE (E2S120) -MOUNTED
 - ELECTRICAL: 115/1PHASE/60HZ FAN AMPS: 0.8 DEFROST AMPS: 0
 - WARRANTY:
 - PARTS: 1-YEAR STANDARD MANUFACTURER
 - 1 EXTENDED 2ND-5TH YEAR REFRIGERATION WARRANTY 1/2 HP TO 1 HP COMPRESSOR ONLY
 - 1 EXTENDED REFRIGERATION WARRANTY; 1ST DAY - 1ST YEAR - 1/2 TO 1 HP LABOR ONLY

BASIS OF DESIGN: U.S. COOLER

- SPECIFICATIONS:**
- U.S. COOLER MODEL NO. 525662
 - WALK-IN FREEZER: 4" EXTRUDED POLYSTYRENE, STUCCO EMBOSSED GALVALUME 26 GAUGE EXTERIOR, STUCCO EMBOSSED GALVALUME 26 GAUGE INTERIOR, NSF APPROVED.
 - 1 FLOOR: 4" EXTRUDED INSULATION, 22 GAUGE STAINLESS STEEL INTERIOR, STUCCO EMBOSSED GALVALUME 26 GAUGE EXTERIOR. U.S. COOLER FLOORS ARE NOT DESIGNED FOR THE USE OF FORKLIFTS, PALLET JACKS, OR HARD WHEELED CARTS. DAMAGE CAUSED BY THIS USAGE WILL VOID THE PANEL WARRANTY
 - 1 DOOR, 34 IN. X 76 IN.; LOW TEMP INSIDE, WITH FLOOR, THRESHOLD, VERT-ERGO HANDLE, LED LIGHT, LED THERMOMETER SWITCH, DOOR CLOSURE AND ADJUSTABLE SPRING-LOADED HINGES
 - 1 PRESSURE RELIEF INSTALLED
 - 1 REFRIGERATION
 - 1 CONDENSING UNIT:
 - MANUFACTURER: RUSSELL
 - DESCRIPTION: PRE-ASSEMBLED REMOTE LOW TEMP R448A AIR COOLED OUTDOOR CONDENSING UNIT
 - MODEL: RFO250L4SDA
 - COMPRESSOR: 2-1/2 HP, SCROLL
 - EXTRAS: LIQUID LINE FILTER DRIER, SIGHT GLASS - INCLUDED
 - ELECTRICAL: 208-230/1PHASE/60HZ RLA: 14.7 MOPD: 4.5 MCA: 32
 - CONDITIONS: BTUH: 7210 ROOM TEMP: -10°F COND AMBIENT: 110°F
 - SIZING BOX: 6558 BTUH NEEDED FOR MAX. 10'-9 1/4"D X 7'-8"W X 7'-6"H (APPROX.)
 - ROOM CLEARANCE: DEPTH: 11'-6", WIDTH: 7'-9", HEIGHT: 8'-0"
 - SIZING PRODUCT: 662LBS OF MISC PRODUCT ENTERING AT 20°F
 - WARRANTY:
 - PARTS: 1-YEAR STANDARD MANUFACTURER (OPTIONAL EXTENDED PARTS)
 - 1 EVAPORATOR (UNIT COOLER):
 - MANUFACTURER: RUSSELL
 - DESCRIPTION: PRE-ASSEMBLED ELECTRIC DEFROST LOW PROFILE COIL
 - MODEL: RL6E066DDAS
 - EXTRAS: EXPANSION VALVE (ERVE-1-ZP), SOLENOID VALVE (E3S130) - MOUNTED
 - ELECTRICAL: 208-230/1PHASE/60HZ FAN AMPS: 1 DEFROST AMPS: 9.8
 - WARRANTY:
 - PARTS: 1-YEAR STANDARD MANUFACTURER
 - EXTENDED WARRANTY:
 - 1 EXTENDED 2ND-5TH YEAR REFRIGERATION WARRANTY 2 1/2 HP COMPRESSOR ONLY
 - 1 EXTENDED REFRIGERATION WARRANTY: 1ST DAY - 1ST YEAR - 2 1/2 HP LABOR ONLY


GENERAL SCOPE OF WORK:

DEFERRED SCOPE OF WORK:

UNDER SEPARATE CONTRACT:
EPOXY FLOOR AND COVERED BASE AT BOTH WALK-IN COOLER AND WALK-IN FREEZER

COUNTY HEALTH REQUIREMENTS:

1. EQUIPMENT MUST BE SPECIFICALLY CONSTRUCTED FOR COMMERCIAL USE, ANSI CERTIFIED FOR SANITATION (NSF, ITS, ETL, EPH, UL SANITATION OR CSA). DOMESTIC MODEL REFRIGERATION UNITS WILL NOT BE ACCEPTED.
2. MERCHANDISER UNITS (USUALLY DISPLAY REFRIGERATORS WITH GLASS DOORS) ARE NOT APPROVED FOR OPEN FOODS, AND ARE NOT PERMITTED IN FOOD PREP AREAS.
3. AN ACCURATE, READILY VISIBLE THERMOMETER LOCATED TO INDICATE THE AIR TEMPERATURE IN THE WARMEST PART OF THE UNIT (USUALLY BY THE DOOR) MUST BE PROVIDED.
4. SHELVING MUST BE NONABSORBENT AND EASILY CLEANABLE. (WOOD IS NOT ACCEPTABLE) USE ONLY SHELVING AS PROVIDED BY THE MANUFACTURER TO FACILITATE AIR CIRCULATION.
5. EQUIPMENT SURFACES MUST BE SMOOTH, NONABSORBENT AND EASILY CLEANABLE. ALL JOINTS MUST BE SEALED.
6. CONDENSATE WASTE FROM REFRIGERATION UNITS MUST DRAIN TO A FLOOR SINK VIA AN AIR GAP. IF DESIGNED BY THE MANUFACTURER, CONDENSATE MAY DRAIN TO A PROPERLY FUNCTIONING EVAPORATOR. RAPID COOL DOWN EQUIPMENT MAY BE REQUIRED DEPENDING ON THE FOOD OPERATION.
7. FLOOR SINKS, FLOOR DRAINS AND TRENCH DRAINS ARE NOT ALLOWED TO BE LOCATED INSIDE THE WALK-IN. TRENCH DRAINS CAN BE ALLOWED IMMEDIATELY OUTSIDE OF A WALK-IN COOLER DOOR.
8. ALL REFRIGERATION UNITS SHALL BE LOCATED WITHIN THE FOOD FACILITY. OUTDOOR REFRIGERATION UNITS ARE NOT ACCEPTABLE UNLESS THEY OPEN DIRECTLY INTO THE FOOD FACILITY.
9. A WALK-IN COOLER MAY BE REQUIRED IF THE PROPOSED MENU SUGGESTS THAT A MODERATE AMOUNT OF FOODS WILL BE COOKED AHEAD OF USE REQUIRE COOLING.
10. HAVE AN INTEGRAL COVERED BASE WITH A RADIUS OF AT LEAST 3/8 INCH AT THE FLOOR/WALL JUNCTURE BOTH INSIDE AND OUTSIDE OF THE COOLER; THE FLOOR MATERIAL SHALL EXTEND UP TO A HEIGHT OF AT LEAST FOUR (4) INCHES ON THE WALLS. FOUR (4) INCH APPROVED METAL TOP SET COVING WITH A MINIMUM OF 3/8 INCH RADIUS IS ACCEPTABLE AGAINST METAL WALL SURFACES. (WOOD IS NOT AN ACCEPTABLE INTERIOR FINISH.)
11. HAVE SHELVING THAT IS AT LEAST SIX (6) INCHES OFF THE FLOOR WITH SMOOTH, ROUND, METAL LEGS OR CANTILEVERED, SUSPENDED DIRECTLY FROM THE WALL, FOR EASE OF CLEANING. WOOD SHELVING IS NOT ACCEPTABLE. SHELVING SHALL BE NON-CORROSIVE AND DESIGNED TO ALLOW FOR OPTIMUM FLOW OF REFRIGERATION AIR. SMALL, EASILY MOVABLE, CASTERED DOLLIES MAY BE USED IN PLACE OF A LOWER SHELF.
12. HAVE CONDENSATE WASTE DRAIN TO A FLOOR SINK VIA AN AIR GAP (BY GRAVITY FLOW). THE FLOOR SINK MUST BE LOCATED OUTSIDE THE WALK-IN REFRIGERATION UNIT AND WITHIN THE BUILDING.

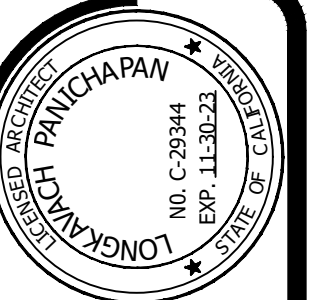

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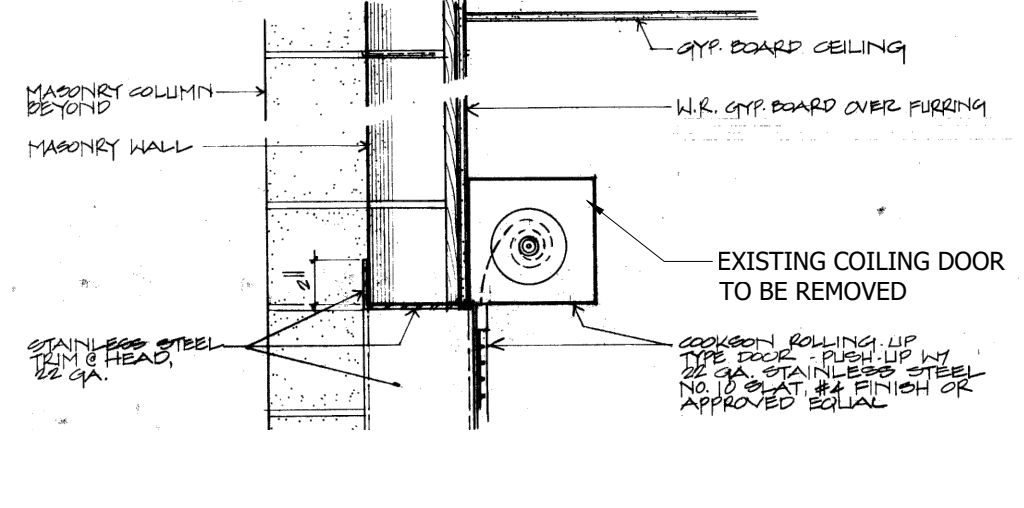
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CONSTRUCTION SET


DATE: 01/13/2022	
DATE: 12/09/21	
BLDG. DEPT. CORRECT:	
JOB NO.: 4107	
DRAWN BY: STAFF	
CHECKED BY: LP	
SCALE: AS NOTED	

WALK-IN REFRIG. & FREEZER INFO
TOWN OF YUCCA VALLEY
Senior Center - Kitchen Equipment Upgrades

A-7.1




01 HEAD @ COUNTER - EXISTING
A-7.2 Scale: N.T.S.

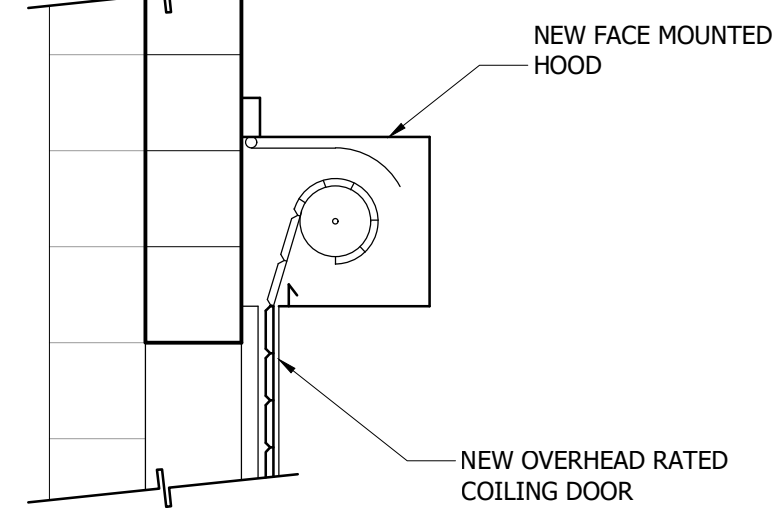


02 HEAD @ COUNTER - PROPOSED (RATED COILING DOOR)
A-7.2 Scale: N.T.S.


RATED COUNTER COILING DOOR (@ CMU WALL):
 PROVIDE AND INSTALL RATED COUNTER COILING DOOR, 60 MINUTE RATING MIN.
 1. MANUFACTURER: OVERHEAD DOOR, WWW.OVERHEADDOOR.COM
 2. MODEL: 641, CLASS A, NFPA-80 COMPLIANT.
 3. FUSIBLE LINK: 165 DEGREES FAHRENHEIT (TO AUTO CLOSE DOOR).
 4. OPERATION: MANUAL CRANK.
 5. FACE MOUNTED AT CMU OPENING
 6. LOCKING (IN CLOSED POSITION ONLY): SLIDE BOLT ON SECURE SIDE
 7. OPTIONS: CUSTOM SIZE TO MATCH PROPOSED OPENING
 8. FINISH: STAINLESS STEEL SLAT, GUIDES AND HOOD

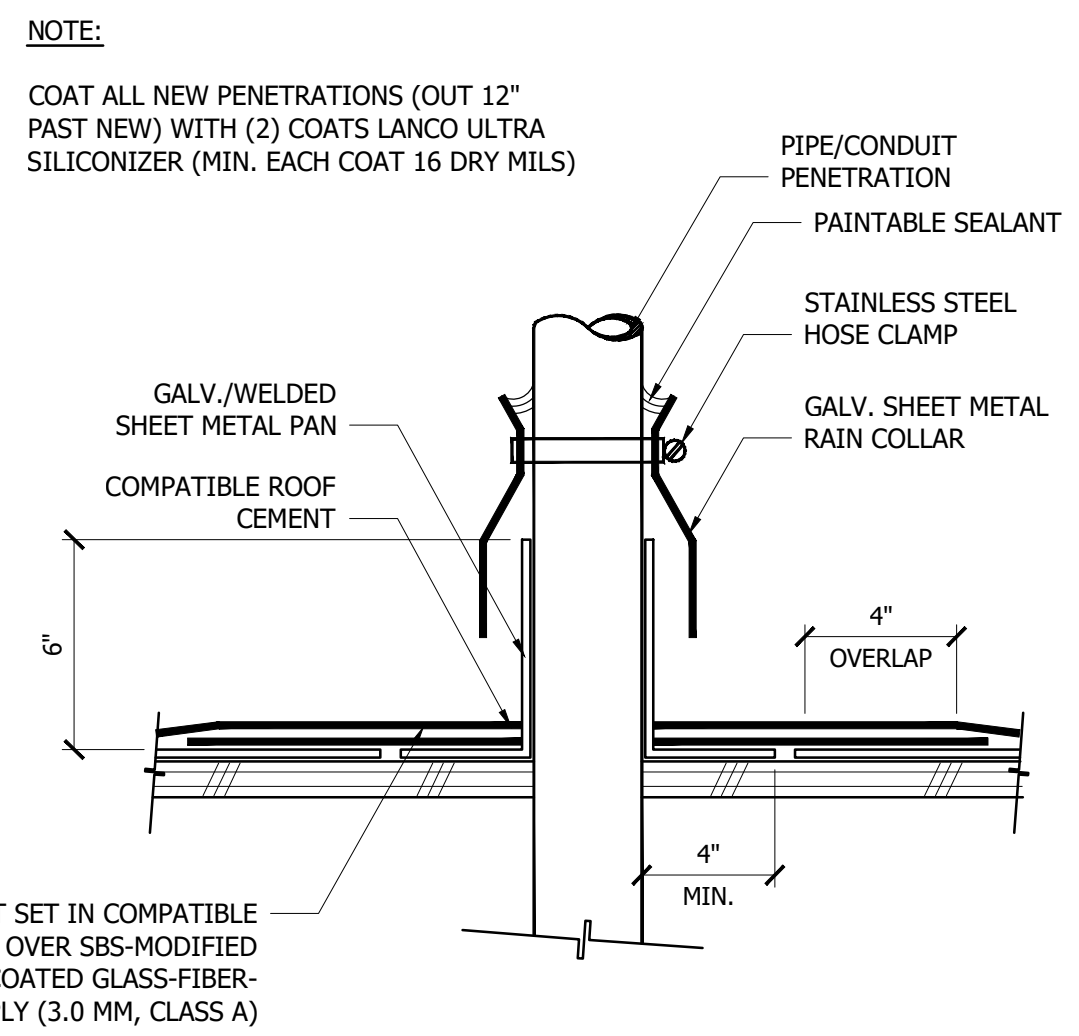


04 FLASHING AT PENETRATION
A-7.2 Scale: N.T.S.

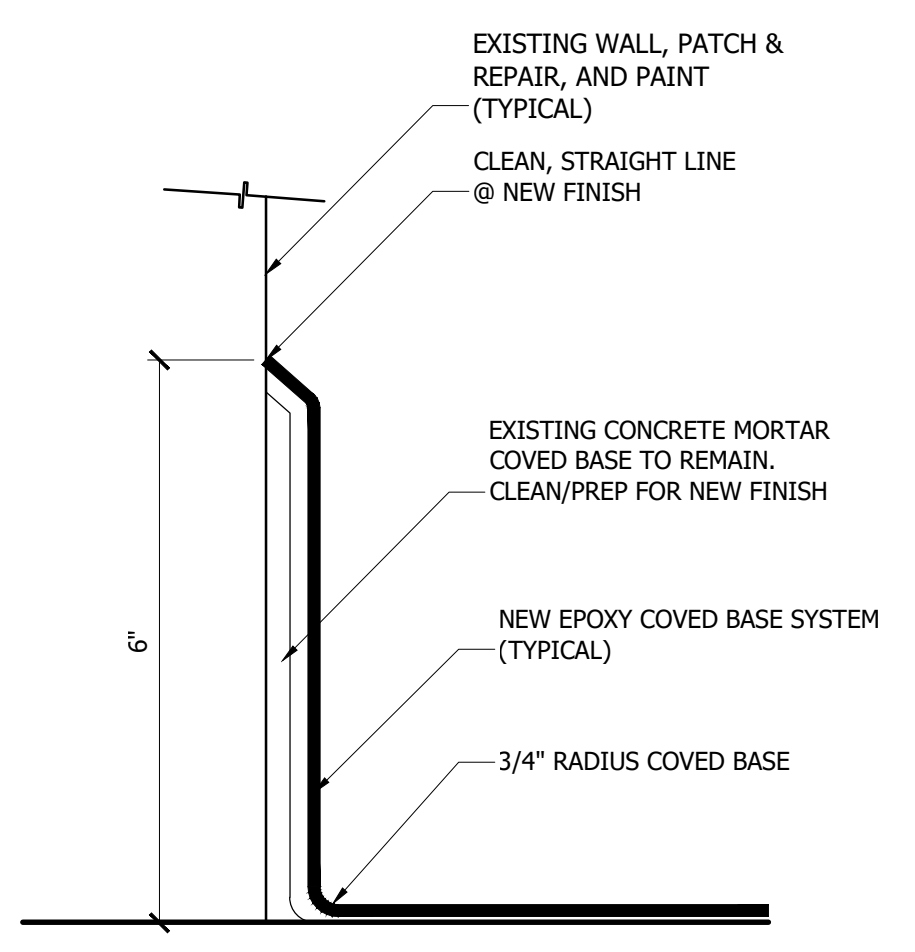


05 PROPOSED NEW BASE/FINISH
A-7.2 Scale: 6" = 1'-0"

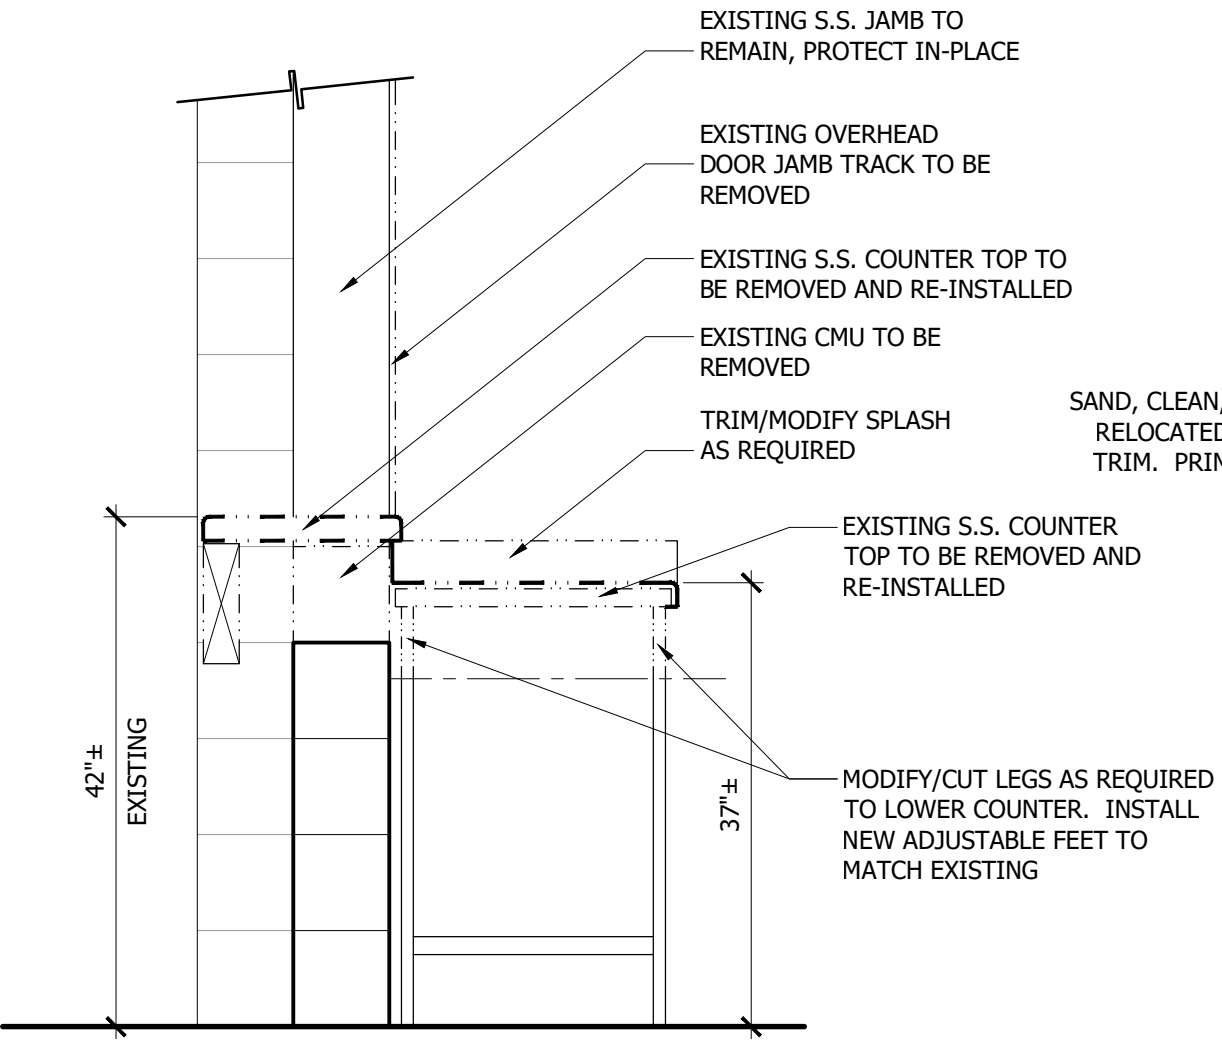


06 SILL @ COUNTER - EX./DEMO
A-7.2 Scale: N.T.S.

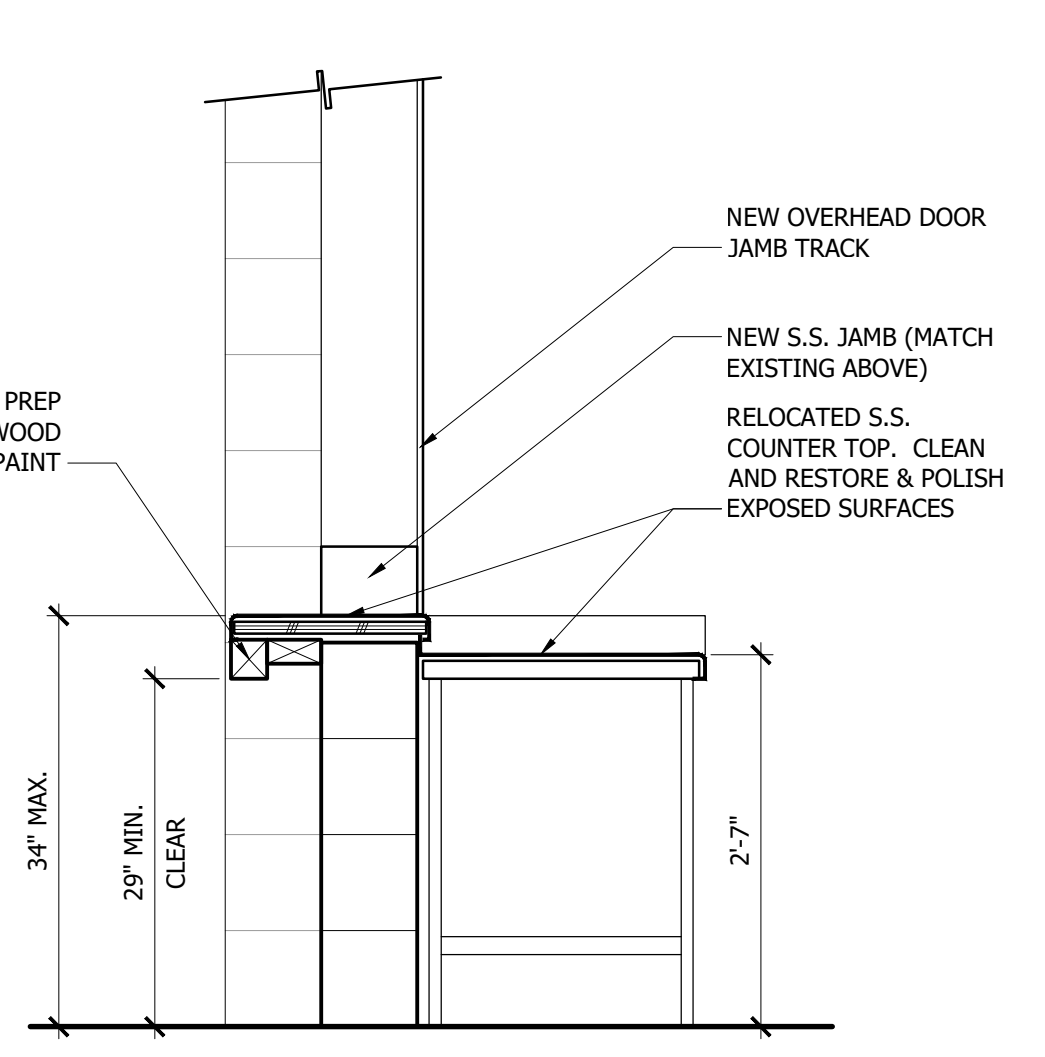


07 SILL @ COUNTER - PROPOSED
A-7.2 Scale: N.T.S.

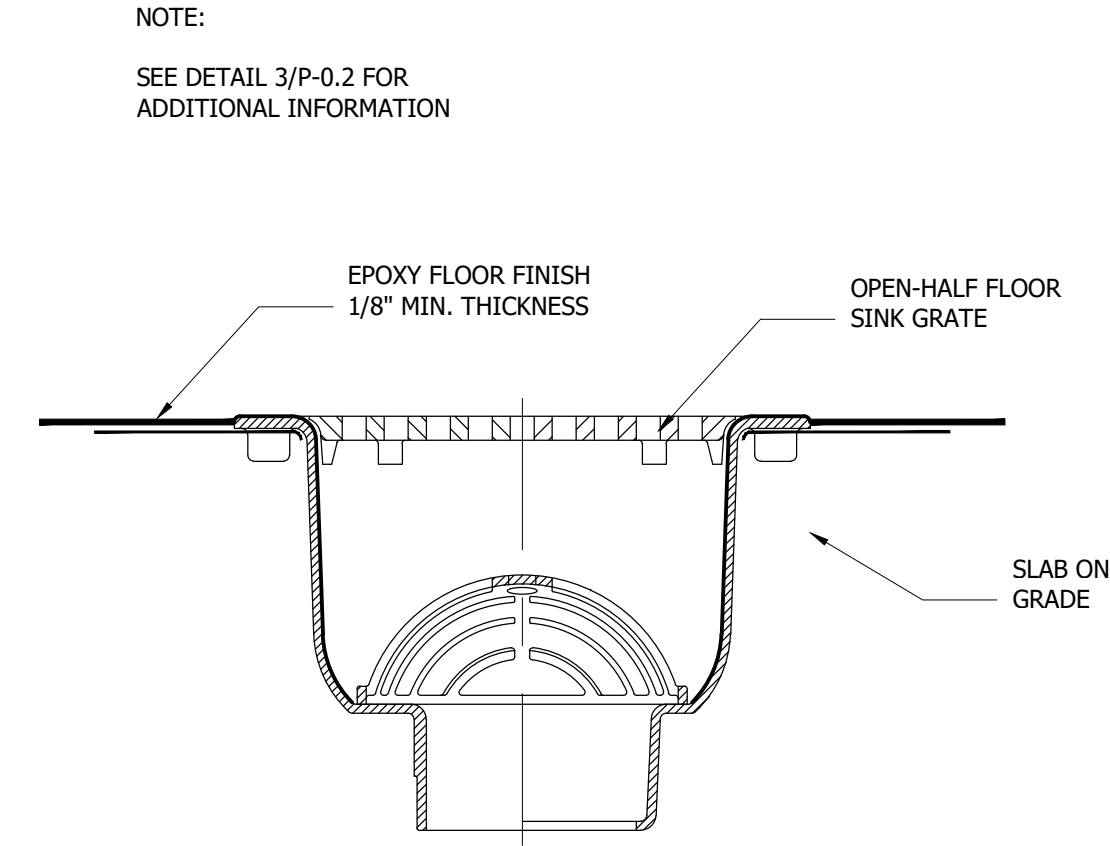


09 FLOOR SINK
A-7.2 Scale: N.T.S.

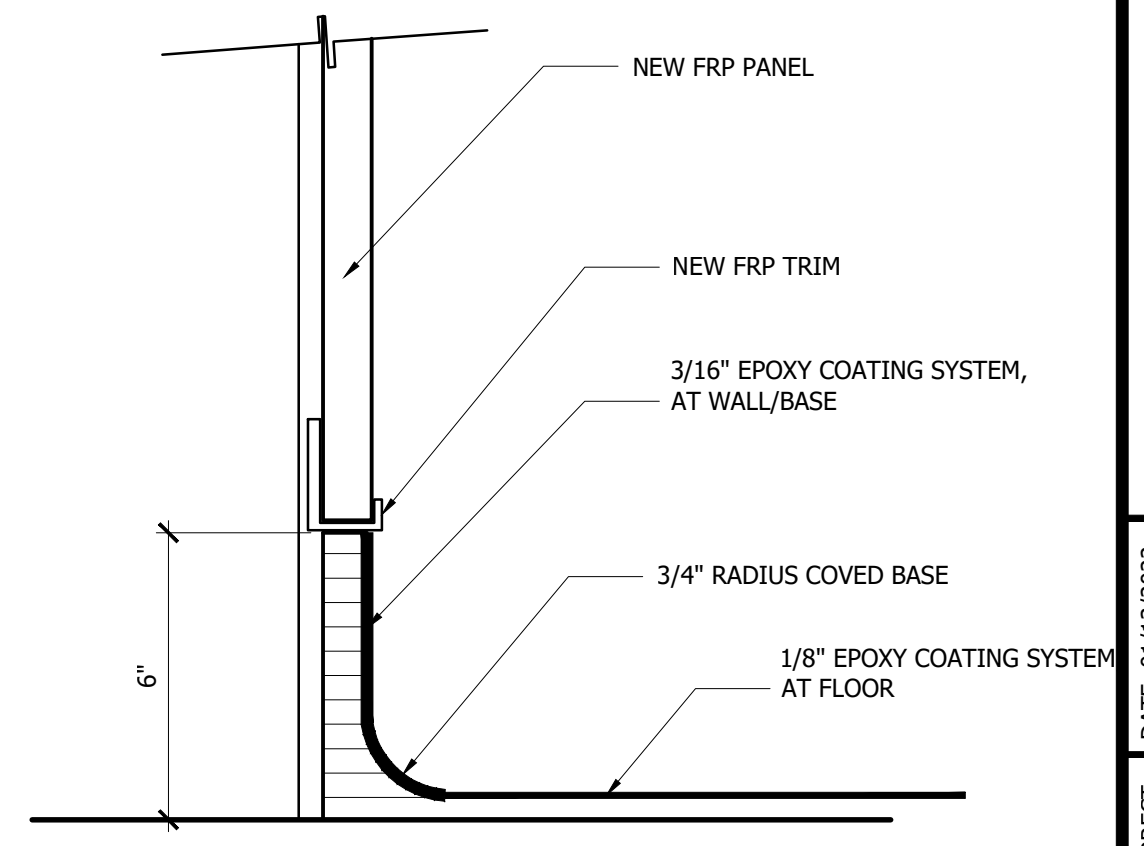


10 PROPOSED NEW BASE/FINISH
A-7.2 Scale: 6" = 1'-0"

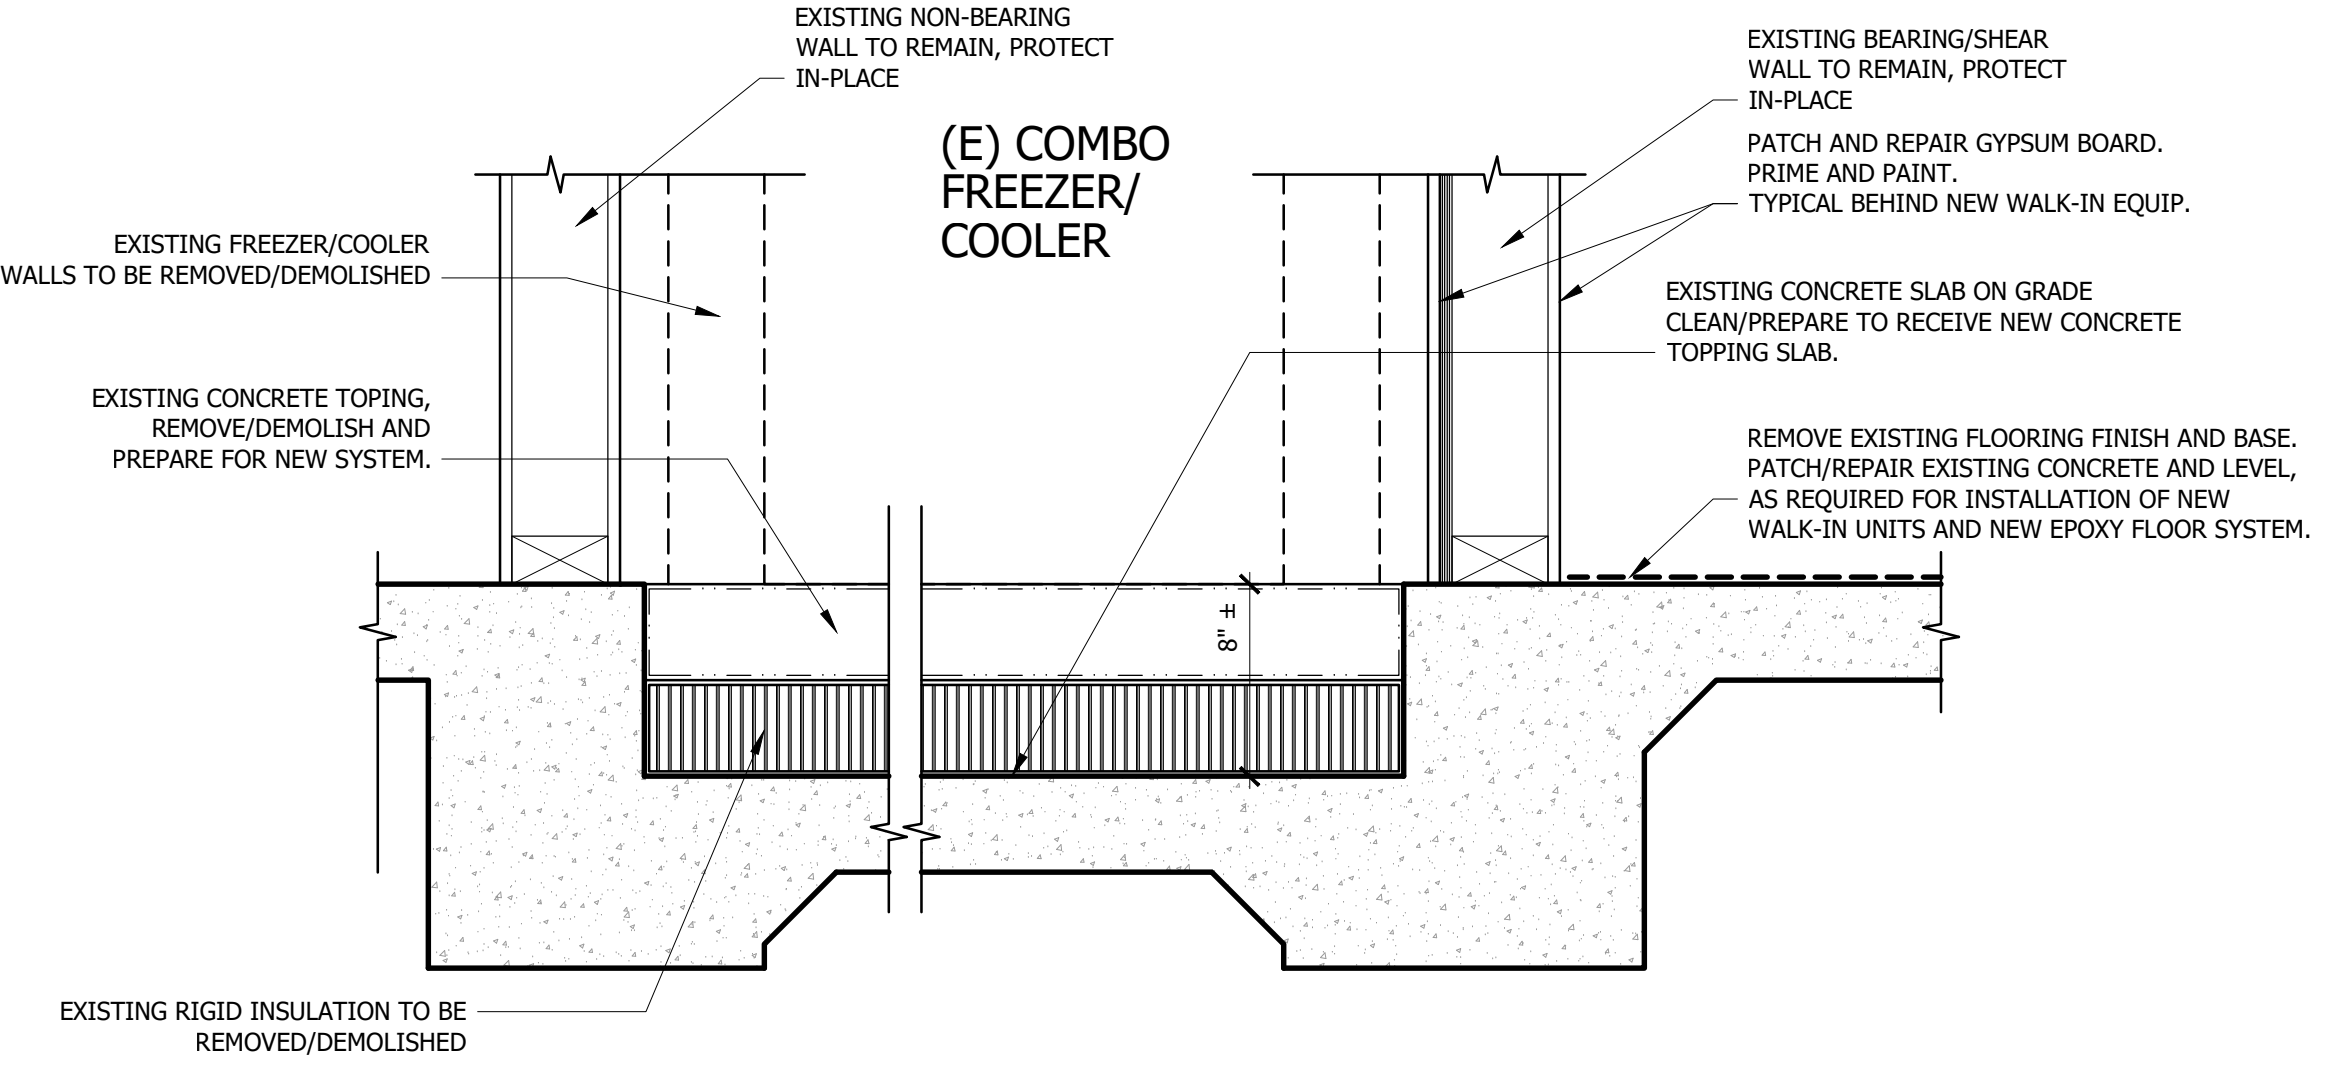


11 SLAB - EXISTING/DEMO
A-7.2 Scale: 1-1/2" = 1'-0"

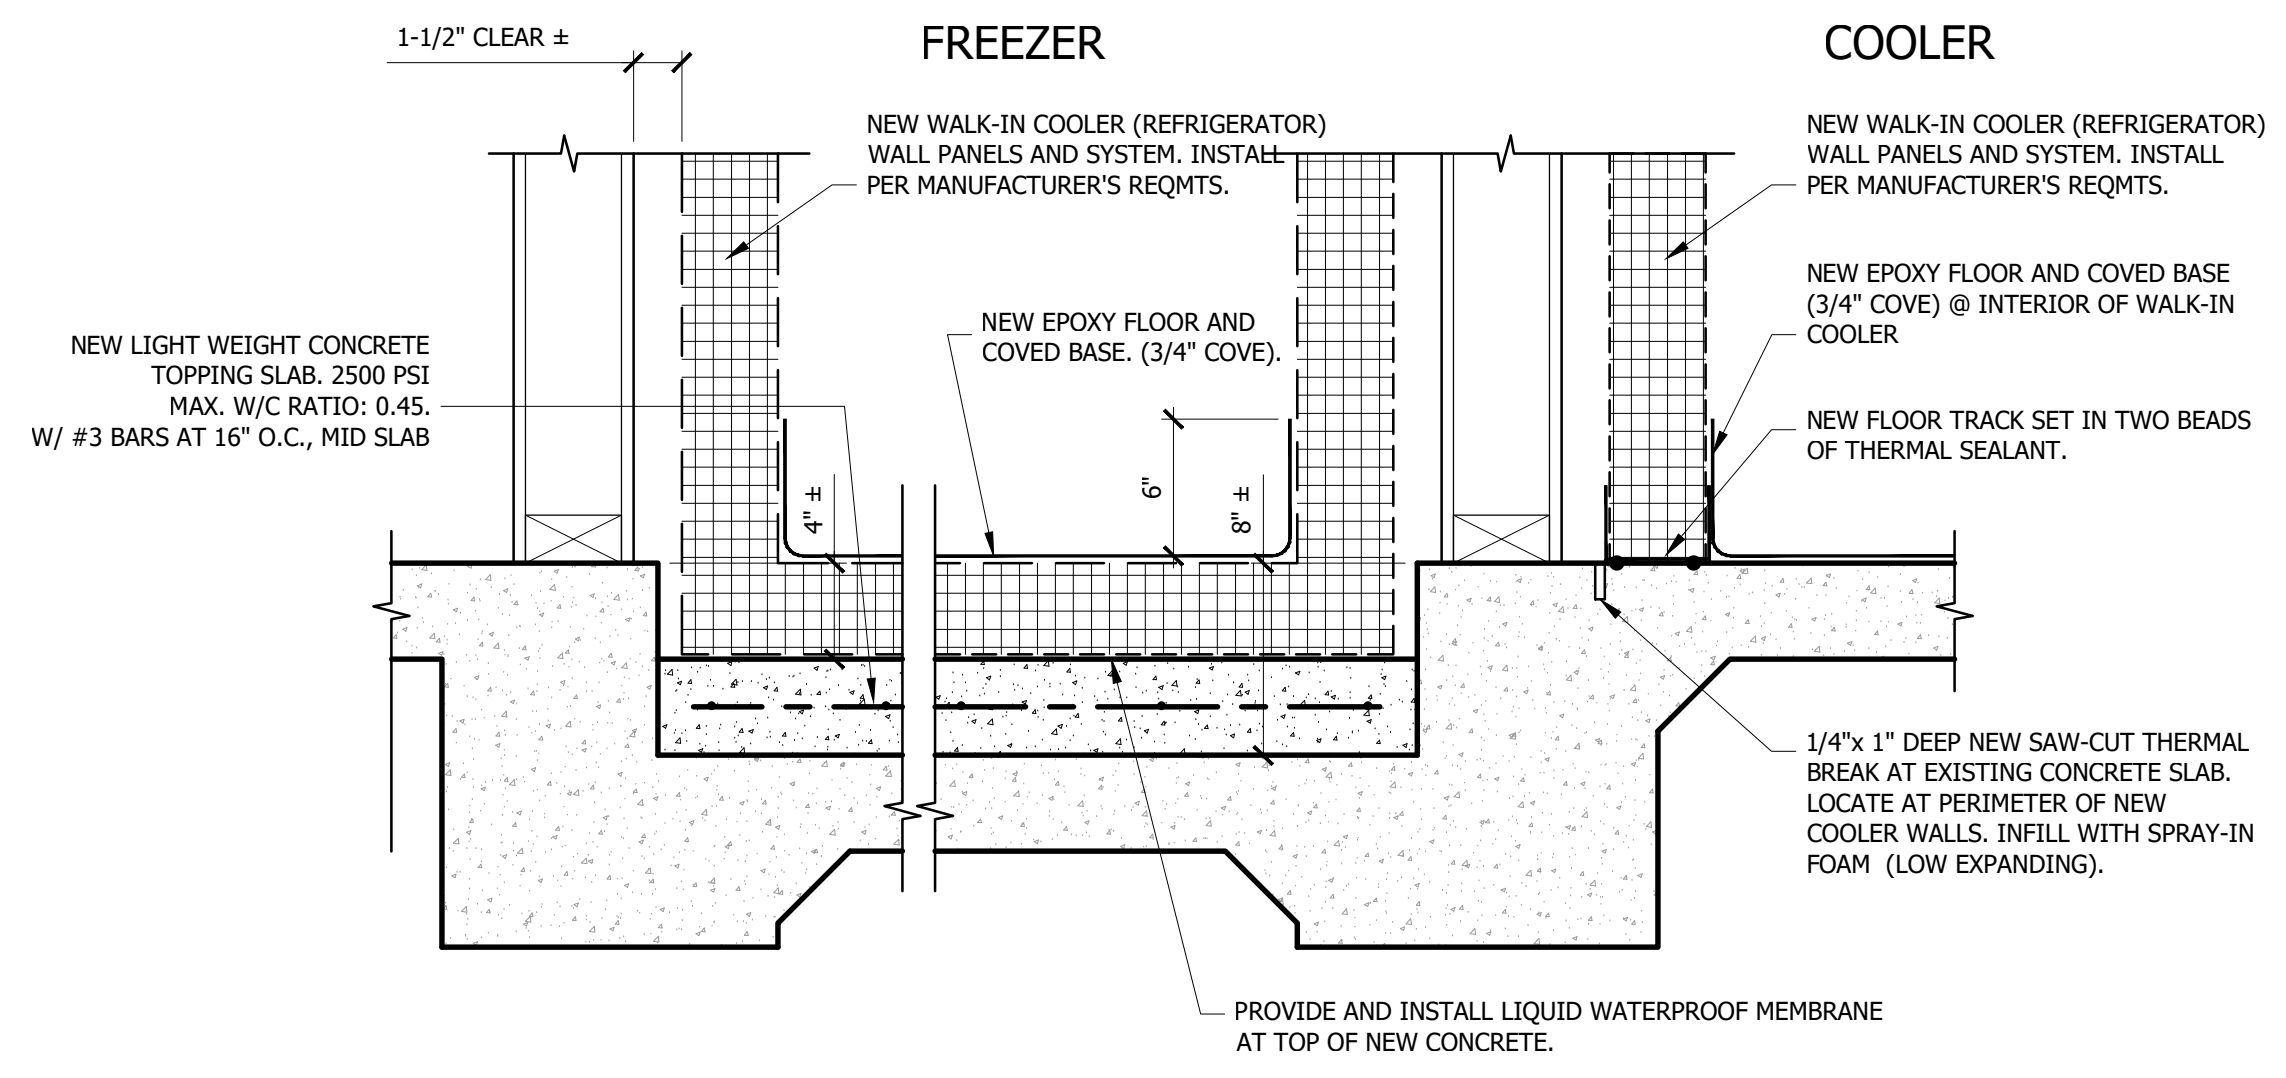

13 SLAB - PROPOSED
A-7.2 Scale: 1-1/2" = 1'-0"

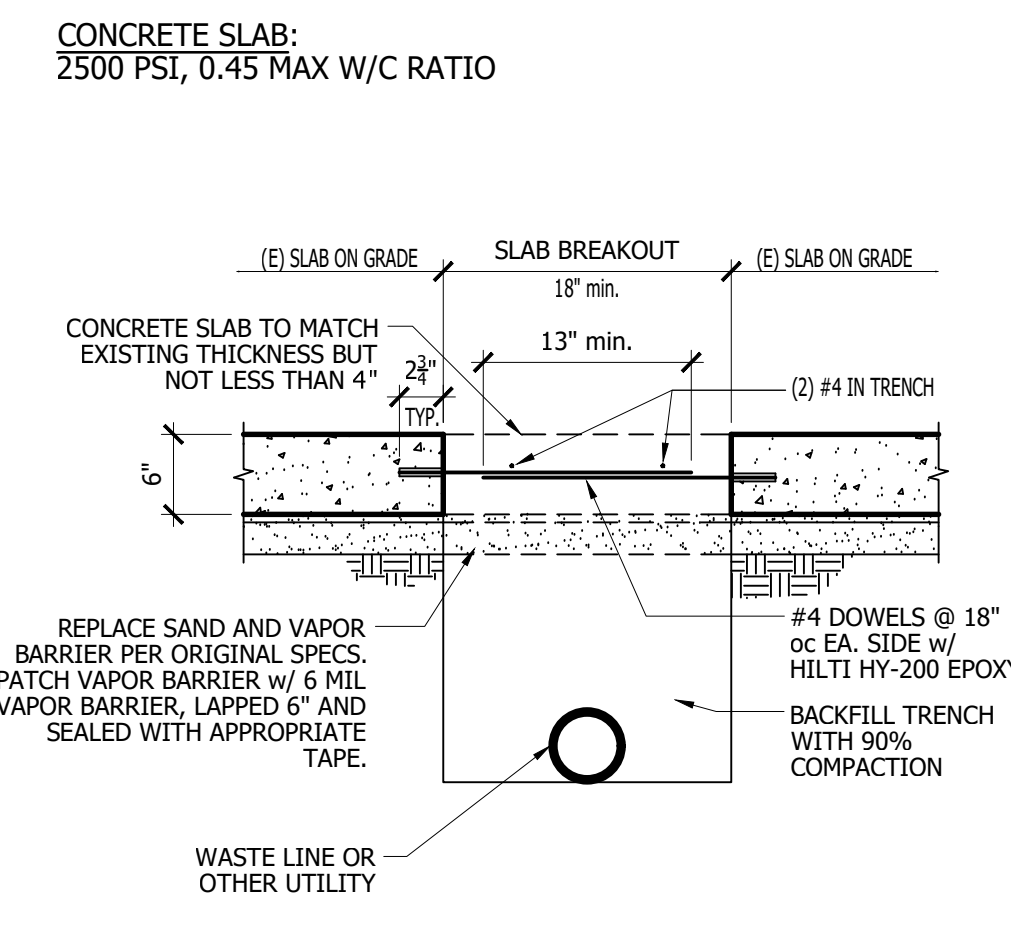

15 SLAB REPLACEMENT @ UTILITY TRENCH
A-7.2 Scale: N.T.S.

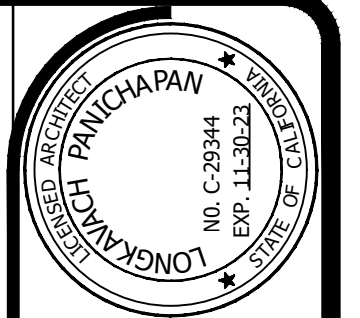

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CONSTRUCTION SET

DATE: 01/13/2022
DATE: 12/09/21
BLDG. DEPT. CORRECT:
JOB NO.: 4107
DRAWN BY: STAFF
CHECKED BY: LP
SCALE: AS NOTED

DETAILS
TOWN OF YUCCA VALLEY
Senior Center - Kitchen Equipment Upgrades

SYMBOLS LIST

FIRE ALARM PULL STATION. MOUNT AT +48 INCHES UNLESS OTHERWISE NOTED. FIRE ALARM PULL STATION, VISUAL STROBE LIGHT AND HORN. MOUNT PULL STATION AT +48 INCHES. MOUNT HORN AND LIGHT AT +80 INCHES ABOVE HIGHEST FLOOR LEVEL IN ROOM OR 6 INCHES BELOW CEILING, WHICHEVER IS LOWER. VISUALS SHALL BE 30 CANDELA (75 CD ON AXIS) U.N.O. 15 CD OR 110 CD DEVICES SHALL BE PROVIDED AS PER NFPA 72. FIRE ALARM TERMINAL CABINET. FIRE ALARM CONTROL PANEL, "FACP". REFER TO SPECIFICATIONS. PHOTOELECTRIC TYPE SMOKE DETECTOR MOUNTED ON CEILING OR WALL PER DRAWINGS. ASTERISK (*) ADJACENT INDICATES RELAY BASED AND LISTED FOR DOOR CONTROL. CONDUIT RUN, CONCEALED IN CEILING, WALLS OR UNDER FLOORS. CONDUIT RUN EXPOSED. CONDUIT RUN UNDERGROUND. CONDUIT STUBBED OUT AND CAPPED. PULL LINE IN PLACE. AIC "AMPERES INTERRUPTING CAPACITY" RMS "ROOT MEAN SQUARED" KW "KILOWATT" KVA "KILOVOLT - AMPERES" V "VOLTS" A "AMPS" WP WEATHERPROOF, NEMA 3R KWH KILOWATT HOURS AFF ABOVE FINISHED FLOOR O.C. "ON CENTER" UNO UNLESS NOTED OTHERWISE C.O. "CONDUIT ONLY". PROVIDE PULL ROPE FOR ALL EMPTY CONDUIT. C. "CONDUIT", WITH CONDUCTORS AS REQUIRED BY DRAWINGS OR SPECIFICATIONS. PHASE REFERENCE DETAIL NUMBER. "X" INDICATES DETAIL NUMBER AND "X.X" INDICATES SHEET NUMBER. CROSS LINES ON CONDUIT RUNS INDICATE NUMBER OF #10 CURRENT CARRYING CONDUCTORS CONTAINED THEREIN. TWO #10 AND ONE #10 GROUND WIRE ARE INDICATED WHEN CROSS LINES ARE NOT SHOWN. NUMERALS ADJACENT TO CROSS LINES ON CONDUIT RUNS INDICATE SIZE OF CONDUCTORS IN LIEU OF #10. ALL CONDUITS SHALL CONTAIN ONE GROUND WIRE SIZED PER C.E.C. TABLE 250-95, BUT NOT SMALLER THAN #10. CONDUIT HOMERUN TO PANELBOARD. LETTER AND NUMERALS INDICATE ELECTRICAL PANEL AND CIRCUIT NUMBER. ISOLATED GROUND WIRE. RUN IN ADDITION TO REGULAR GROUND WIRE. SURFACE MOUNTED BRANCH CIRCUIT PANELBOARD. RECESSED BRANCH CIRCUIT PANELBOARD. PANEL DESIGNATION. RECESSED COMMUNICATION TERMINAL CABINET. REFER TO DRAWINGS AND SPECIFICATIONS. SURFACE MOUNTED COMMUNICATION TERMINAL CABINET. REFER TO DRAWINGS AND SPECIFICATIONS. JUNCTION BOX IN ACCESSIBLE CEILING SPACE OR FLUSH IN WALL WITH BLANK COVER PLATE TO MATCH DEVICE PLATES. DUPLEX GROUNDING TYPE RECEPTACLE, 20 AMP, 125 VOLT. DUPLEX GROUND FAULT INTERRUPTING TYPE RECEPTACLE, 20 AMP, 125 VOLT. TWO DUPLEX GROUNDING TYPE RECEPTACLES IN 4S BOX, 20 AMP, 125 VOLT.

COMBINATION MAGNETIC MOTOR STARTER AND NON-FUSED DISCONNECT SWITCH. COMBINATION MAGNETIC MOTOR STARTER AND FUSED DISCONNECT SWITCH. SINGLE PHASE FRACTIONAL OR INTEGRAL HORSEPOWER MOTOR. TRANSFORMER, PRIMARY & SECONDARY VOLTAGE AND KVA RATING AS NOTED. TYPE AND CONFIGURATION AS SPECIFIED. PROVIDE DRY TYPE, COPPER WOUND, WALL OR BOX MOUNTED UNLESS NOTED OTHERWISE. EQUIPMENT WITH "E" ADJACENT IS EXISTING TO REMAIN. EQUIPMENT WITH "R" ADJACENT IS EXISTING TO BE COMPLETELY DISCONNECTED AND REMOVED. EQUIPMENT WITH "RR" ADJACENT IS EXISTING TO BE DISCONNECTED, REMOVED AND RELOCATED TO NEW LOCATION AND RECONNECTED AS REQUIRED. RELOCATED EQUIPMENT SHOWN IN NEW LOCATION. FLOOR MOUNTED COMBINATION RECEPTACLE & TELE/DATA. HALF-SWITCHED DUPLEX RECEPTACLE. JUNCTION BOX FLUSH IN FLOOR. NON-FUSED DISCONNECT SWITCH. "AS" INDICATES SWITCH AMPERE RATING. FUSED DISCONNECT SWITCH. "AS" INDICATES SWITCH AMPERE RATING. "AFU" INDICATES FUSE AMPERE RATING. MAGNETIC MOTOR STARTER. ROMAN NUMERAL INDICATES NEMA STARTER SIZE. ADDITIONAL SUBSCRIPTS INDICATE STARTER TYPE AND SIZE. (TYPICAL FOR ALL MAGNETIC STARTER SYMBOLS.) NO SUBSCRIPT - FULL VOLTAGE, NON REVERSING PR - PRIMARY RESISTOR REDUCED VOLTAGE AT - AUTOTRANSFORMER REDUCED VOLTAGE WD - WYE-DELTA REDUCED VOLTAGE PW - PART WINDING REDUCED VOLTAGE SS - SOLID STATE REDUCED VOLTAGE REV - REVERSING TYPE 2S - TWO SPEED 2W - TWO WINDINGS CH - CONSTANT HORSEPOWER CT - CONSTANT TORQUE VT - VARIABLE TORQUE VFD - VARIABLE FREQUENCY DRIVE LOW VOLTAGE DIMMER SWITCH (SAME ABBREVIATIONS APPLY AS ABOVE) MOLDED CASE CIRCUIT BREAKER. "AF" INDICATES AMPERE FRAME, "AT" INDICATES AMPERE TRIP RATING AND NUMBER OF POLES AS INDICATED. SUBSCRIPT INDICATES TYPE. NO SUBSCRIPT THERMAL MAGNETIC NA NON-AUTOMATIC MO MAGNETIC ONLY CL CURRENT LIMITING SS SOLID STATE EM ELECTRONIC METERING PACKING DRAW-OUT TYPE CIRCUIT BREAKER. FUSED SWITCH. "AS" INDICATED AMPERE SWITCH RATING, "AFU" INDICATES AMPERE FUSE RATING, NUMBER OF POLES AS INDICATED. VOLTAGE TRANSFORMER. FLOOR MOUNTD, COPPER WOUND, DRY TYPE UNLESS SPECIFIED OTHERWISE. CURRENT TRANSFORMERS, "C.T.s" POTENTIAL TRANSFORMER, P.T.s". UTILITY METER SOCKET, WITH C.T.s, CLIPS, ETC., PER SERVING UTILITY COMPANY. GROUND, "GRD". "GROUND FAULT INTERRUPTER" GROUND FAULT PROTECTION DEVICE. GROUND FAULT SENSOR. TELEPHONE TERMINAL BACKBOARD "TTB". 3/4 INCH SANDED AND PAINTED CPX PLYWOOD, 4' X 8' UNLESS NOTED OTHERWISE.

WALL MOUNTED COMBINATION VOICE/DATA OUTLET. SINGLE GANG MUD RING AND PLATE. ENGRAVE PLATE "VOICE" AND "DATA" OVER RESPECTIVE JACKS. VERIFY TYPE OF JACK WITH SCE IT. CONTRACTOR SHALL RUN 1-1/2" C.O MIN. FROM DATA JACK TO 6" ABOVE CEILING SPACE. COORDINATE CABLING REQUIREMENTS WITH SCE IT. PANEL NAME. FIRE AND SMOKE DAMPER SURFACE MOUNTED EMERGENCY LIGHTING UNIT WITH 90 MIN. EMERGENCY BATTERY PACK. REFER TO LIGHTING FIXTURE SCHEDULE. CEILING MOUNTED OCCUPANCY SENSOR CEILING MOUNTED DAYLIGHT SENSOR ROOM CONTROLLER CEILING LIGHT FIXTURE AND OUTLET, HID, FLUORESCENT, OR INCANDESCENT. LOWER CASE LETTER INDICATES CONTROLLING SWITCH, NUMERAL INDICATES CIRCUIT. SHADED SYMBOL INDICATES FIXTURE WITH EMERGENCY POWER PROVISIONS. FLUORESCENT LIGHT FIXTURE OUTLET. LOWER CASE LETTER INDICATES CONTROLLING SWITCH, NUMERAL INDICATES CIRCUIT. SHADED CIRCLE DENOTES FIXTURE WITH EMERGENCY POWER PROVISIONS. FLUORESCENT STRIP FIXTURE. LOWER CASE LETTER INDICATES CONTROLLING SWITCH. NUMERAL INDICATES CIRCUIT. SHADED CIRCLE DENOTES FIXTURE WITH EMERGENCY POWER PROVISIONS. BRACKET OR WALL MOUNTED LIGHT FIXTURE AND OUTLET, HID, FLUORESCENT OR INCANDESCENT. LOWER CASE LETTER INDICATES CONTROLLING SWITCH, NUMERAL INDICATES CIRCUIT. SHADED CIRCLE DENOTES FIXTURE WITH EMERGENCY POWER PROVISIONS. ILLUMINATED EXIT LIGHT FIXTURE. SIDE, BACK, CEILING, OR PENDANT MOUNTED, SINGLE OR DOUBLE FACED AS NOTED BY SHADED ARC, WITH OR WITHOUT DIRECTIONAL ARROW AS NOTED ON THE DRAWINGS. NOT TO BE USED AS JUNCTION BOX OR "THROUGH-WIRE" DEVICE. LOW LEVEL EXIT LIGHT FIXTURE, WALL MOUNTED WITH OR WITHOUT DIRECTIONAL ARROW AS NOTED ON THE DRAWINGS. BOTTOM OF FIXTURE AT +6 INCHES ABOVE FINISHED FLOOR AND WITHIN FOUR INCHES OF DOOR FRAME WHERE APPLICABLE. LIGHTING FIXTURE IDENTIFICATION SYMBOL. LETTER INDICATES FIXTURE TYPE. NUMERALS IN LOWER HALF OF HEXAGON INDICATE FIXTURE WATTAGE (INCLUDING BALLAST WHERE APPLICABLE). NUMERAL OUTSIDE TOP OF HEXAGON INDICATES NUMBER OF FIXTURES REQUIRED. NUMERAL OUTSIDE BOTTOM OF HEXAGON INDICATES MOUNTING HEIGHT FROM FLOOR TO BOTTOM OF FIXTURE. OMISSION OF MOUNTING HEIGHT INDICATES CEILING MOUNTING. HP RATED SWITCH SWITCH. LOWER CASE LETTER AT BOTTOM INDICATES OUTLETS CONTROLLED. CAPITAL SUPERScript INDICATES SWITCH TYPE. NO SUPERScript - SINGLE POLE SWITCH 2 - DOUBLE POLE 3 - THREE WAY 4 - FOUR WAY I - ILLUMINATED HANDLE K - KEYED SWITCH LC - LOCKABLE COVER M - MANUAL MOTOR STARTER WITH THERMAL OVERLOAD PROTECTION MC - MOMENTARY CONTACT P - PILOT LIGHT PR - PRESS TYPE RP - THREE POSITION T - TIMER, 0-6 HR ROTARY OR AS NOTED HALF CONTROLLED DUPLEX GROUND FAULT INTERRUPTING TYPE RECEPTACLE, 20 AMP, 125 VOLT, 2 POLE, 3 WIRE. FLUSH FLOOR MOUNTED DUPLEX GROUNDING TYPE RECEPTACLE, 20 AMP, 125 VOLT ANY RECEPTACLE INDICATED WITH "IG" ADJACENT SHALL BY ISOLATED GROUND TYPE WITH INDIVIDUAL GROUND WIRE TO PANELBOARD. DEDICATED RECEPTACLE INDICATED WITH "IG" ADJACENT SHALL BY ISOLATED GROUND TYPE WITH INDIVIDUAL GROUND WIRE TO PANELBOARD. WALL POWER IN-FEED JUNCTION BOX FOR WORKSTATIONS FOR POWER AND TELEPHONE/DATA. SINGLE GANG TELEPHONE BOX. PROVIDE 1-1/2" CONDUIT AND STUB-UP AT +6" ABOVE CEILING WITH A SUPER FLEX CONDUIT, UNLESS OTHERWISE NOTED. VERIFY LOCATION WITH FURNITURE CONTRACTOR. PROVIDE MAX. 6' FLEX WHIP FOR CONNECTION. WALL MOUNTED OCCUPANCY SENSOR +42" AFF, U.O.N. (SINGLE MANUAL ON/OFF DIMMER SWITCH) WALL MOUNTED OCCUPANCY SENSOR +42" AFF, U.O.N. (DOUBLE MANUAL ON/OFF DIMMER SWITCH)

APPLICABLE CODES

BUILDING OCCUPANCY CLASSIFICATION: THE CONSTRUCTION OF THIS PROJECT SHALL CONFORM TO THE REQUIREMENTS OF: 2019 BUILDING STANDARD ADMINISTRATIVE CODE 2019 CALIFORNIA BUILDING CODE (CBC) 2019 CALIFORNIA ELECTRICAL CODE (CEC) 2019 CALIFORNIA MECHANICAL CODE (CMC) 2019 CALIFORNIA PLUMBING CODE (CPC) 2019 CALIFORNIA ENERGY CODE 2019 CALIFORNIA FIRE CODE (CFC).

SHEET INDEX

Table with 2 columns: SHEET NO., SHEET NAME. Rows include E-0.1 ELECTRICAL SYMBOL LIST AND ABBREVIATIONS, E-0.2 ELECTRICAL SPECIFICATIONS, E-0.3 SINGLE LINE DIAGRAM AND PANEL SCHEDULES, E-1.1 OVERALL FLOOR PLAN, E-2.1 ENLARGED FLOOR PLAN - EXISTING/DEMO, E-3.1 ENLARGED FLOOR PLAN - PROPOSED, E-4.1 ENLARGED ROOF PLAN - PROPOSED.


FIRE ALARM PERMIT NOTE

CONTRACTOR SHALL PROVIDE AND SUBMIT FIRE ALARM SAFETY CONSTRUCTION DOCUMENTS FOR ALL AGENCY PLAN CHECK REQUIREMENTS. APPROVAL SHALL BE OBTAINED PRIOR TO THE INSTALLATION OF THE SYSTEM. INTERCONNECTING WIRING AND CONDUIT SIZES ARE NOT INDICATED. CONTRACTOR SHALL BE RESPONSIBLE FOR PREPARING RACEWAY, WIRING PLANS, VOLTAGE DROP CALCULATION AND COMPLETE ONE LINE DIAGRAM OF THE SYSTEM. CONTRACTOR SHALL PROVIDE AS PART OF FIRE ALARM SYSTEM: * CONSTRUCTION DOCUMENT AND SHOP DRAWINGS. * SUBMIT AND SECURE FIRE MARSHAL APPROVAL. * FIELD TO VERIFY EXISTING FIRE ALARM DEVICES. ADD AND/OR RELOCATE EXISTING DEVICES TO COMPLY TO NEW SPACE CONFIGURATION.

ABBREVIATIONS

AF AMPERE FRAME RATING OF CIRCUIT BREAKERS AFF ABOVE FINISHED FLOOR AFU AMPERE FUSE RATING AIC AMPS INTERRUPTING CAPACITY RATING (RMS SYMMETRICAL) AM AMP METER AMP, A AMPERES AS AMPERE SWITCH RATING AT AMPERE TRIP RATING OF BREAKER AWG AMERICAN WIRE GAUGE BKR BREAKER C CONDUIT CAB CABINET CC CENTER TO CENTER CKT CIRCUIT C.O. CONDUIT ONLY CU COPPER DWG DRAWING E EXISTING FF FINISHED FLOOR FLEX FLEXIBLE FLUOR FLUORESCENT FUT FUTURE GND GROUND HZ HERTZ J.B. JUNCTION BOX K THOUSAND (KILO) KV KILOVOLTS KW KILOWATTS KVA KILOVOLT AMPERES KWH KILOWATT-HOURS LT, LTS LIGHT, LIGHTS LTG LIGHTING MAX MAXIMUM MCB MAIN CIRCUIT BREAKER MCC MOTOR CONTROL CENTER MCM THOUSAND CIRCULAR MILS MT MOUNT, MOUNTED, MOUNTING NO, NOS NUMBER, NUMBERS NTS NOT TO SCALE OC ON CENTER PNL PANEL PNLBD PANELBOARD PRI PRIMARY PWR POWER R REMOVED REC RECEPTACLE RECPTS RECEPTACLES REQD REQUIRED SW SWITCH SYS SYSTEM SYM SYMMETRICAL TEMP TEMPERATURE TYP TYPICAL UNO UNLESS NOTED OTHERWISE W WIRE WP WEATHERPROOF XFMR TRANSFORMER ZD ZONE DAMPER

Vertical sidebar containing: GPO architecture planning interior logo; Gilis + Panichapan Architects, 1990 BRISTOL STREET COSTA MESA, CALIFORNIA 92626, TEL (714) 688-4285; SHEET INDEX table; CONSTRUCTION SET title; JOB NO.: 21122, DATE: 12/08/2021, DRAWN BY: M.VERMIA, CHECKED BY: M.VERMIA, SCALE: AS NOTED; ELECTRICAL SYMBOL LIST & ABBRE. TOWN OF YUCCA VALLEY Senior Center - Kitchen Upgrades; H2S ENGINEERS INC logo; H2S Engineers Inc. Consulting MEP Engineers Anaheim, CA 92801 Ph: (714) 290-0718 E-mail: mverma@h2sengineers.com; E-0.1 sheet identifier.

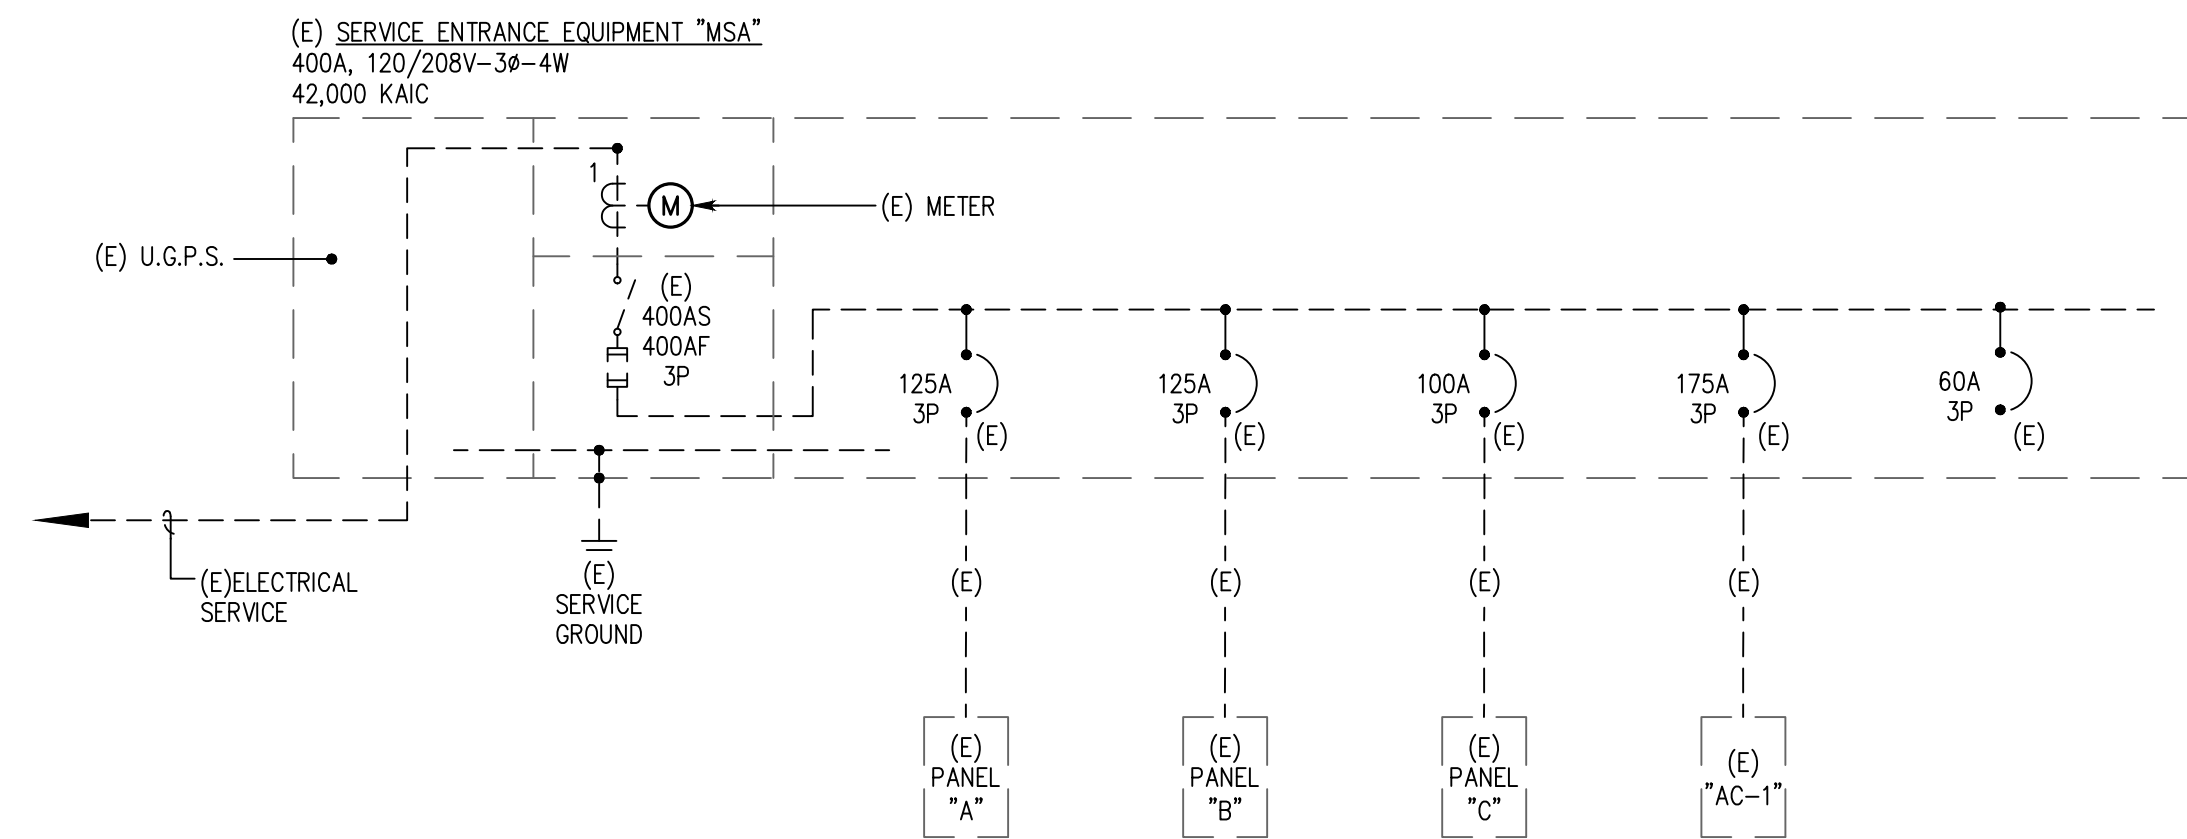

1 EXISTING SINGLE LINE DIAGRAM
SCALE: NONE

MOUNTING: SURFACE		EXISTING PANEL 'A'												LOCATION: SEE PLANS												
VOLTAGE: 120/208V, 3Ø, 4W		10,000 AIC SYM						225 AMP BUS			MAIN LUGS ONLY															
NOTE	DESCRIPTION	VOLT-AMPERES			L I T E P	R E C P	M O L D	B R K C C	C I R C C	B P O L R	M I S C P	L I T E	VOLT-AMPERES			DESCRIPTION	NOTE									
		ØA	ØB	ØC									ØA	ØB	ØC											
1	LIGHTS	720							1	20	1				175		EF-1	2								
1	LIGHTS		705						1	20	3	4	20	1			SPARE	1								
1	LIGHTS			600					1	20	5	6	20	1		700	LIGHTS	1								
1	LIGHTS	300							1	20	7	8	20	1		750	LIGHTS	1								
1	RECEP KITCHEN		1200						1	20	9	10	20	1		1200	RECEP KITCHEN	1								
1	RECEP KITCHEN			1200					1	20	11	12	20	1		1800	RECEP KITCHEN	1								
1	RECEP KITCHEN	900							1	20	13	14	20	1		900	RECEP KITCHEN	1								
1	RECEP KITCHEN			1000					1	20	15	16	20	1		600	RECEP KITCHEN	1								
1	REF.			1000					1	20	17	18	20	2		1000	REF. COMP	2								
1	SPARE	1000							1	20	19	20	-	-		1000	-									
2	FREEZER COMP.		1000						2	20	21	22	20	1		600	FAN COIL	2								
-				1000					-	-	23	24	20	1		600	FAN COIL	2								
1	OVEN	800							2	20	25	26	20	3		800	STEAMER	1								
1			800						1	-	27	28	-	1		800	STEAMER	1								
1	HOT TABLE			1500					2	20	29	30	-	-		800	-	1								
1			1500						-	-	31	32	20	1			SPARE	1								
1	SPARE								2	20	33	34	20	1		900	EF-1	1								
1									-	-	35	36	20	1		900	EF-1	1								
1	RECEP KITCHEN	800							1	20	37	38	20	1		800	RECEP. KITCHEN	1								
1	RECEP KITCHEN		800						1	20	39	40	20	1		800	RECEP. KITCHEN	1								
1	MIXER			800					1	20	41	42	20	1		1000	REC IRRIGATION CONT	1								
VA PER PHASE		6020	5505	6100													4425	4900	6800	VA PER PHASE						
CONTINUOUS LOAD		2325	x1.25=	2906	VA														10445	10405	12900	TOTAL VA PER PHASE				
					+ OTHER=		31425	VA														33750			TOTAL CONNECTED VA	
					TOTAL LOAD=		34331	VA				95		AMPS												
					CEILING OUTLETS =																					
					CONV. OUTLETS =																					
					MISC. OUTLETS =																					
THIS PANEL IS FED BY:																										
																1		EXISTING CIRCUIT TO REMAIN								
																2		EXISTING C.B. WITH NEW LOAD								
																3										
																4										



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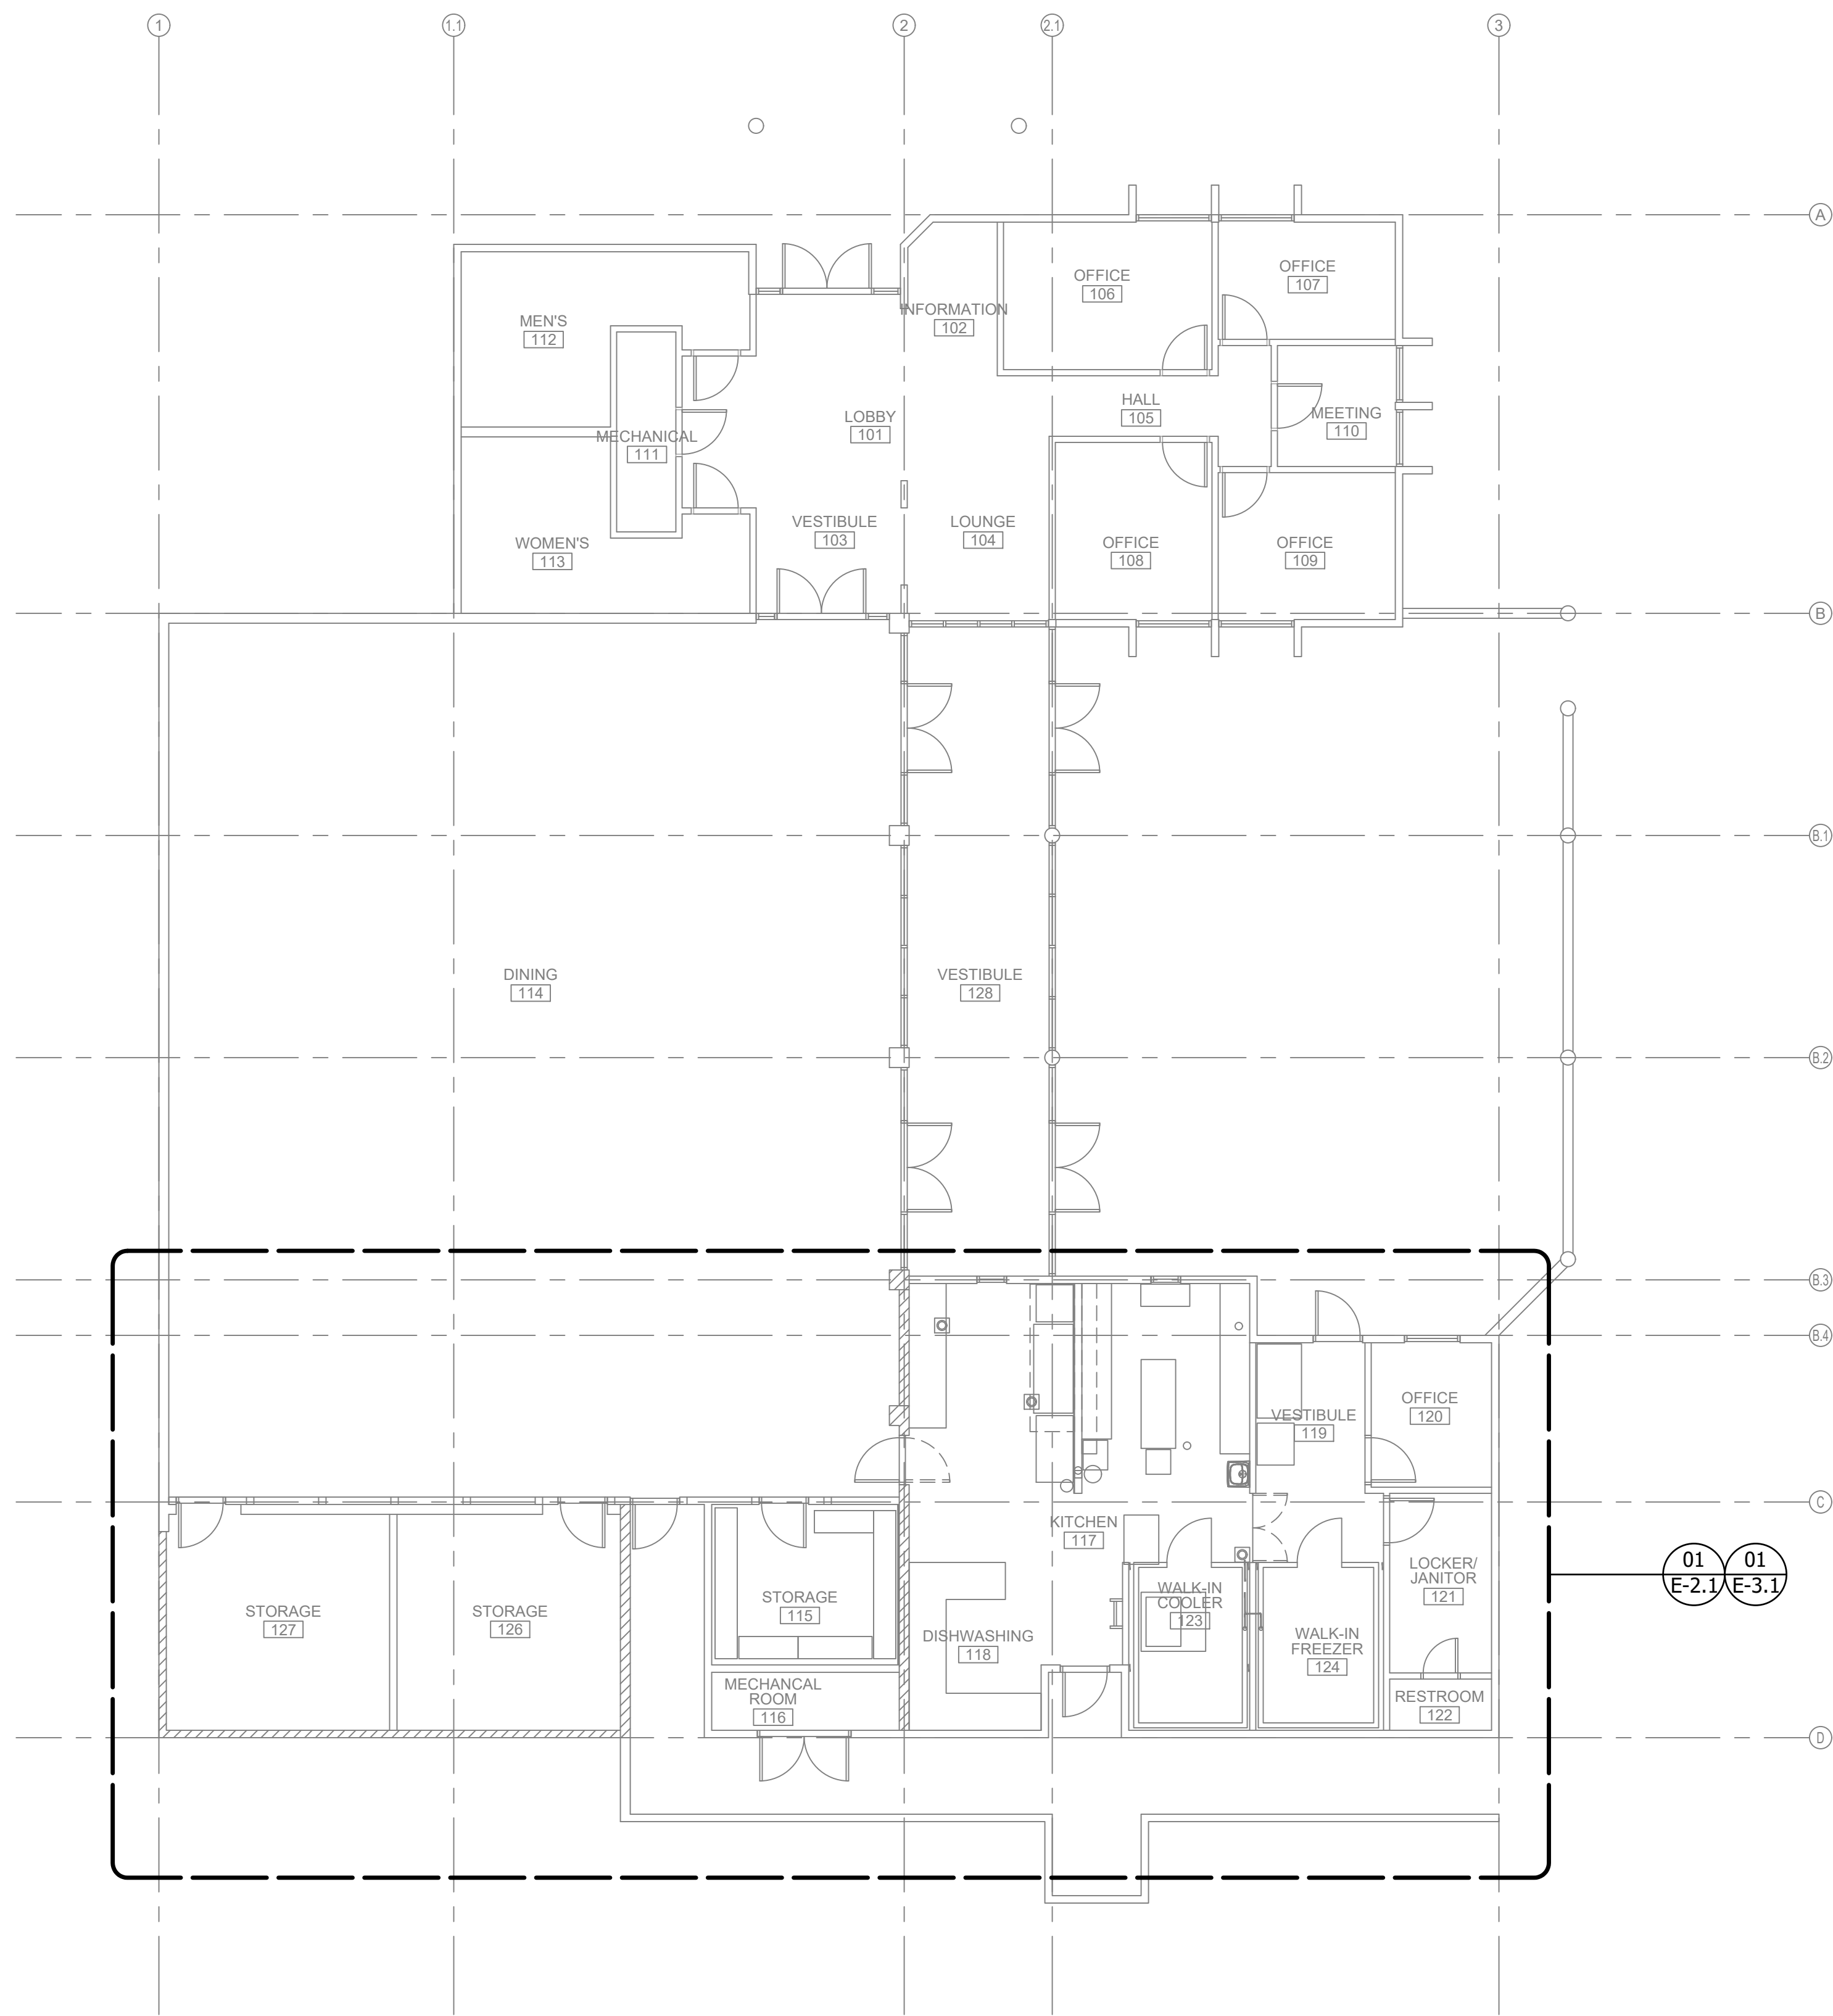
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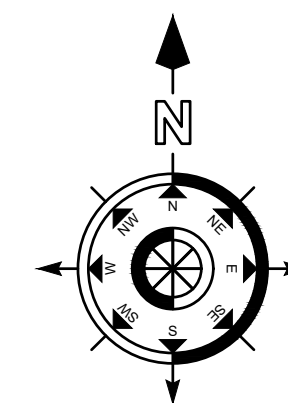
CONSTRUCTION SET

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SCALE:	AS NOTED		

DEMO & REMODEL - SINGLE LINE DIAGRAM
TOWN OF YUCCA VALLEY
Senior Center - Kitchen Upgrades



01 OVERALL FLOOR PLAN
 E-1.1 Scale: 1/8" = 1'-0"



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CONSTRUCTION SET


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OVERALL FLOOR PLAN
 TOWN OF YUCCA VALLEY
 Senior Center - Kitchen Upgrades


E-1.1

SHEET NOTES

- ① DISCONNECT AND REMOVE POWER CONNECTION FROM EXISTING REF. & FREEZER UNITS. PRESERVE EXISTING CKTS FOR LATER REUSE. SEE SHEET E-3.1 FOR ADDITIONAL INFORMATION.
- ② PULL NEW 3#12 WIRES INSIDE EXISTING CONDUIT.

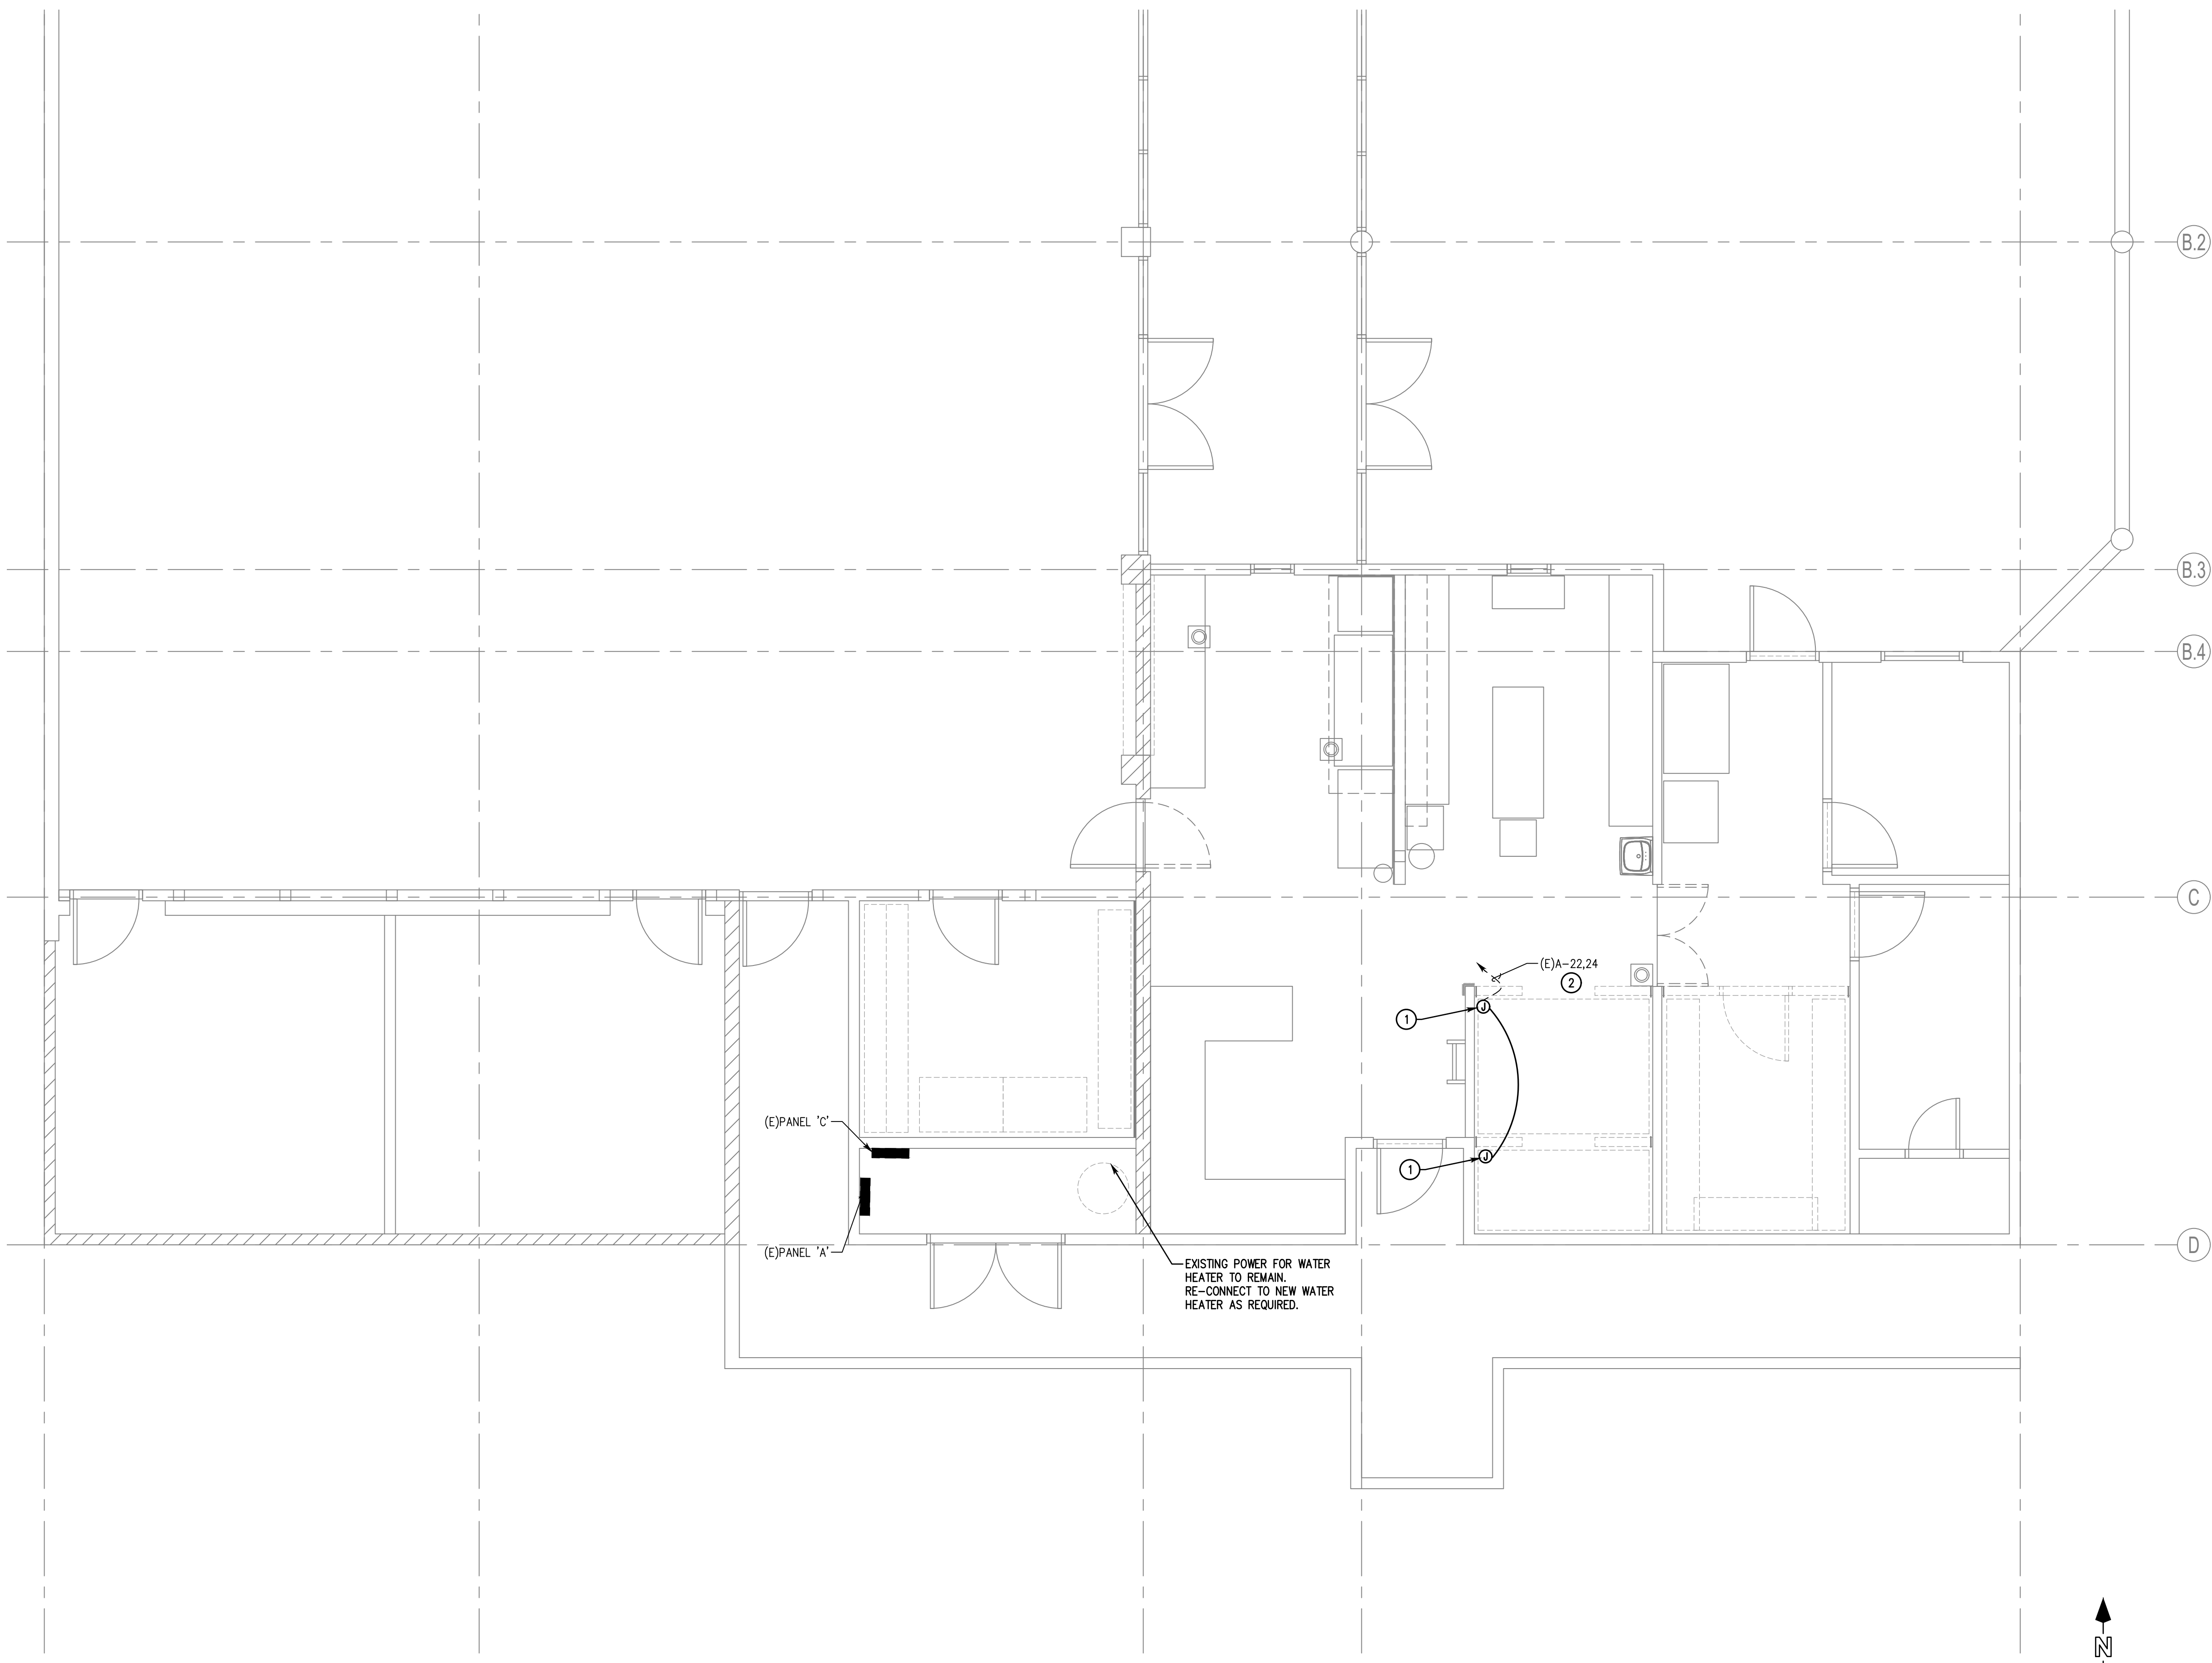

01 ENLARGED FLOOR PLAN - EXISTING/DEMO
 E-2.1 Scale: 1/4" = 1'-0"

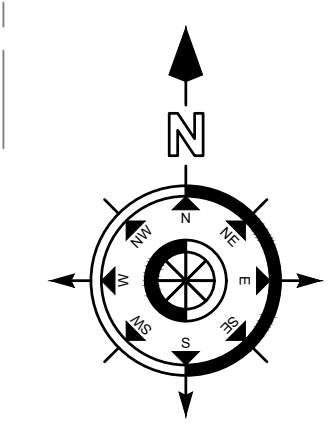

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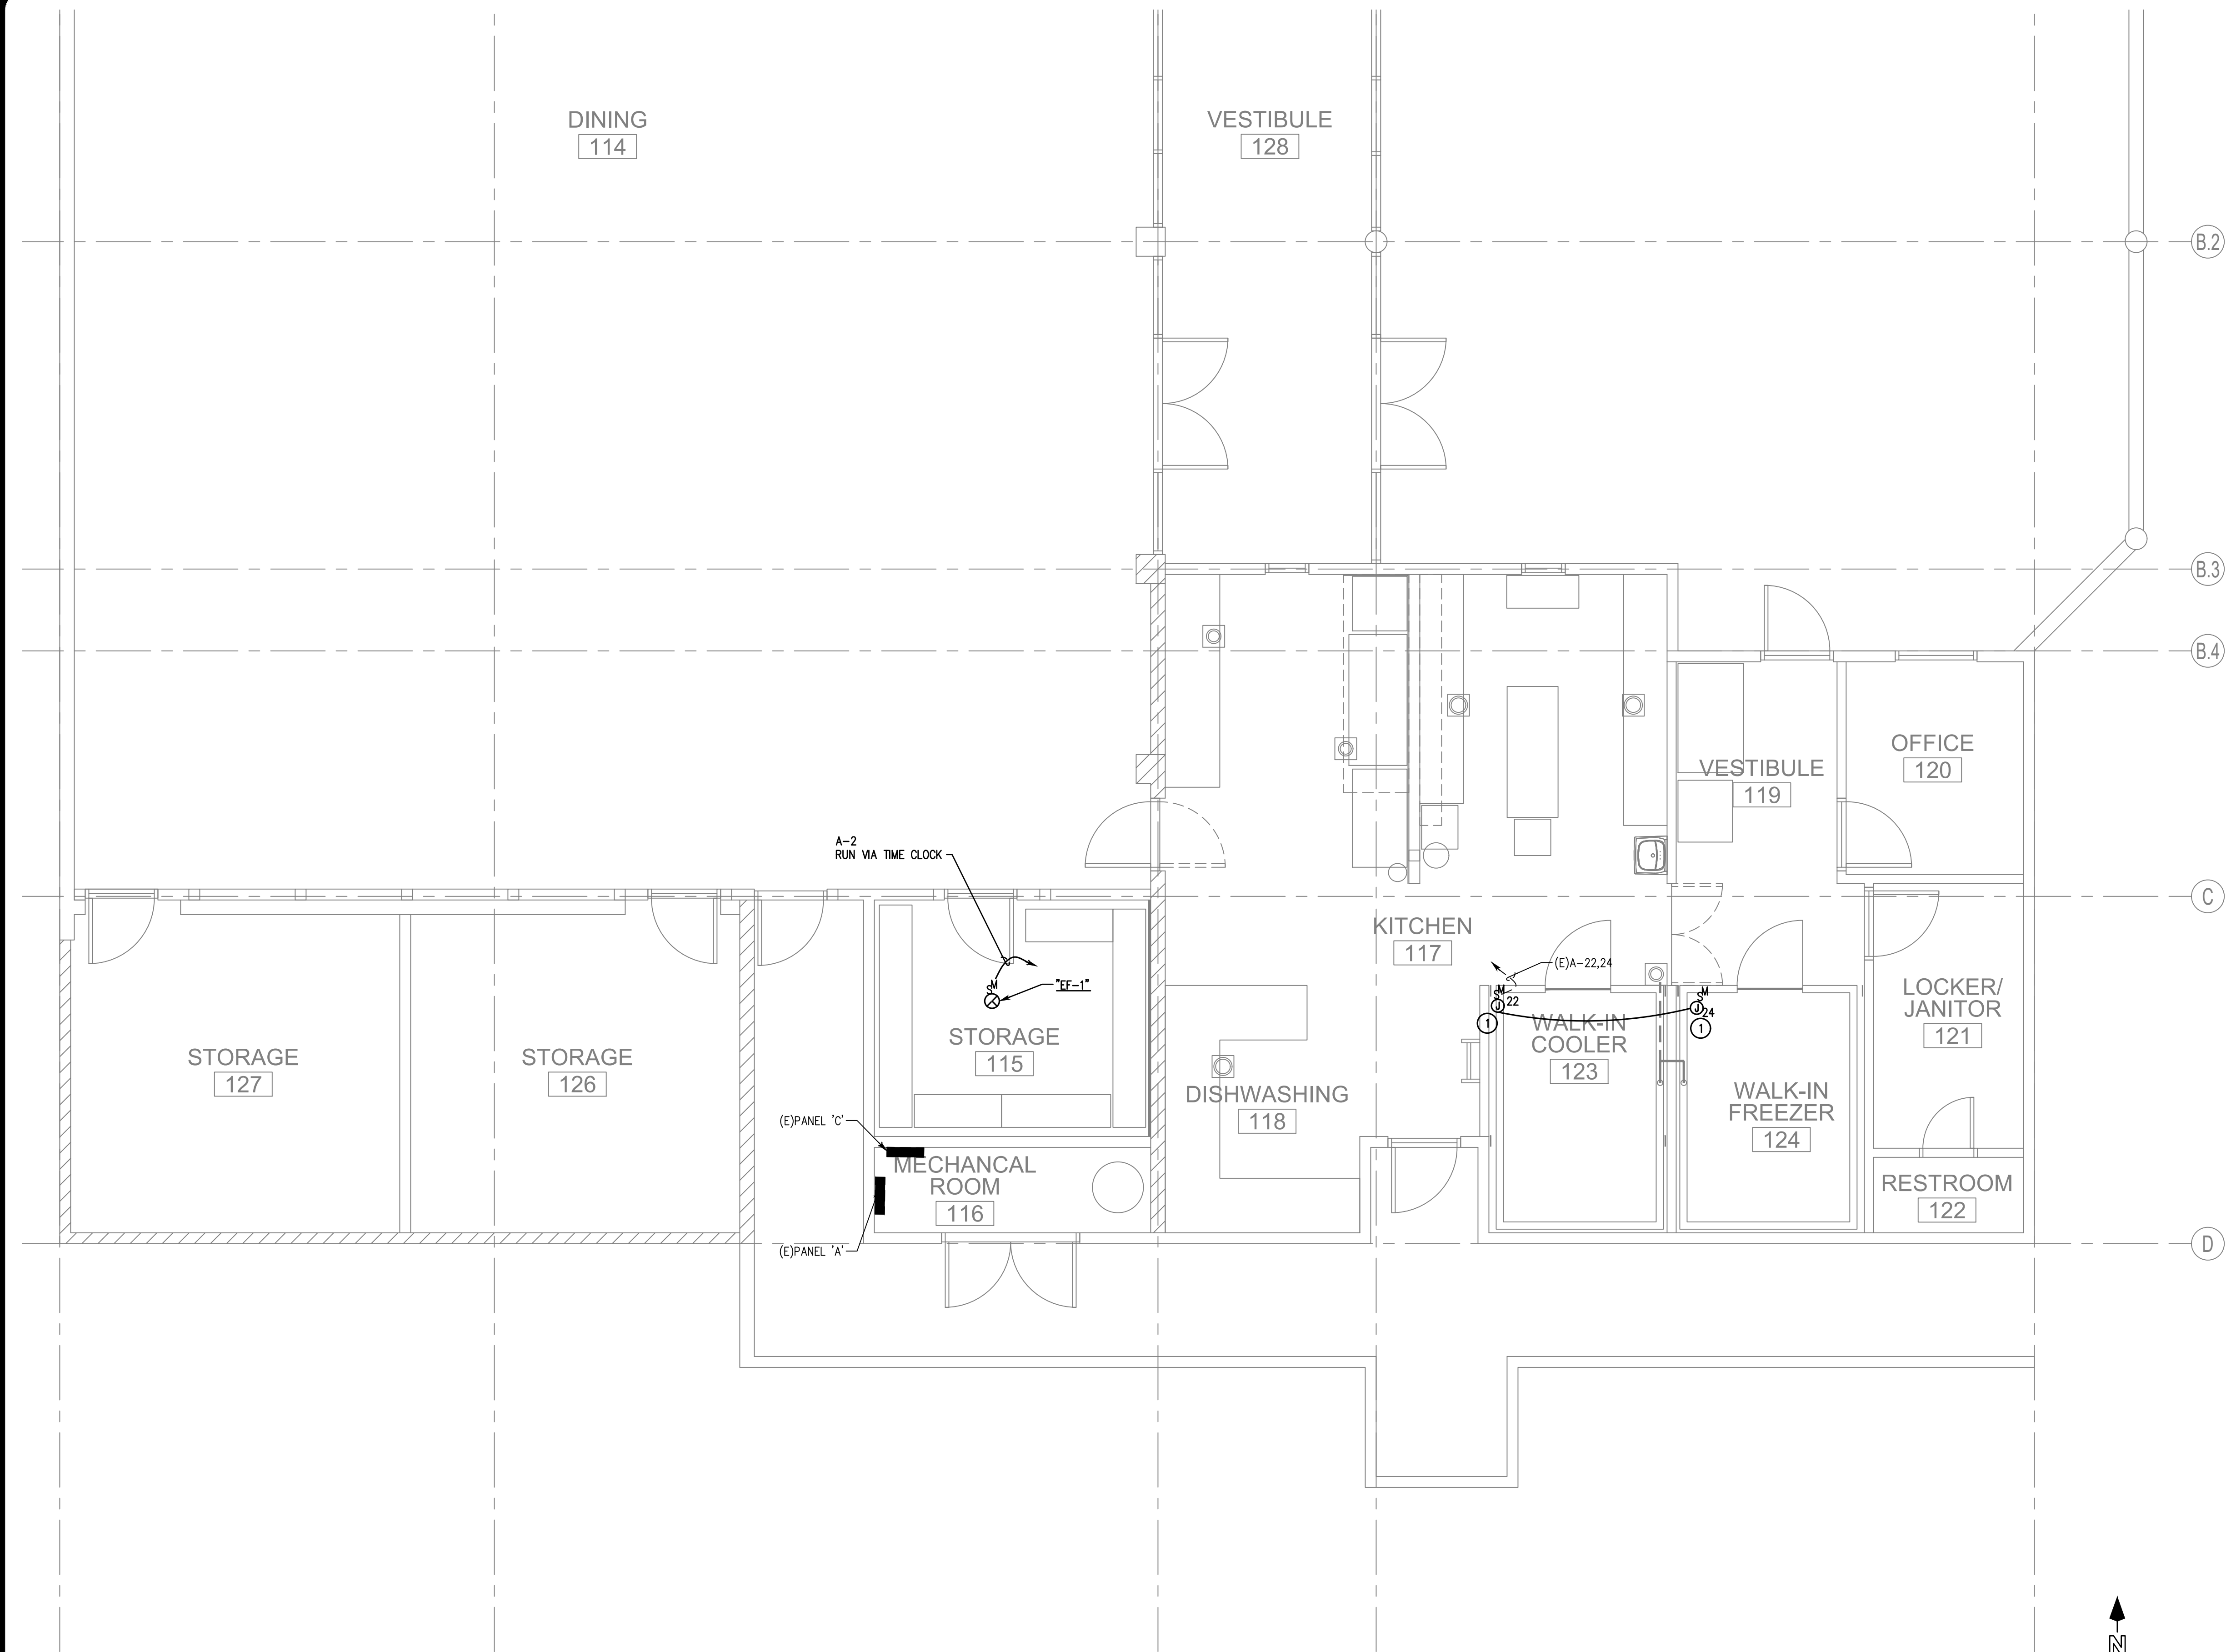
CONSTRUCTION
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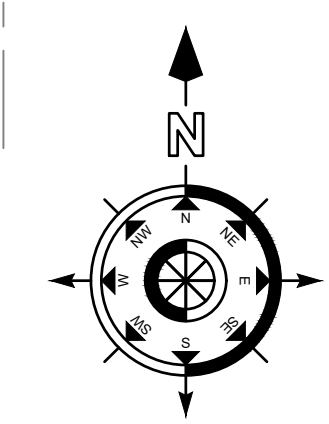
ENLARGED FLOOR PLAN - EXISTING/DEMO
 TOWN OF YUCCA VALLEY
 Senior Center - Kitchen Upgrades

SHEET NOTES

- 1 PROVIDE 20AMPS MOTOR RATED SWITCH FOR NEW FAN-COILS



01 ENLARGED FLOOR PLAN - PROPOSED
 E-3.1 Scale: 1/4" = 1'-0"



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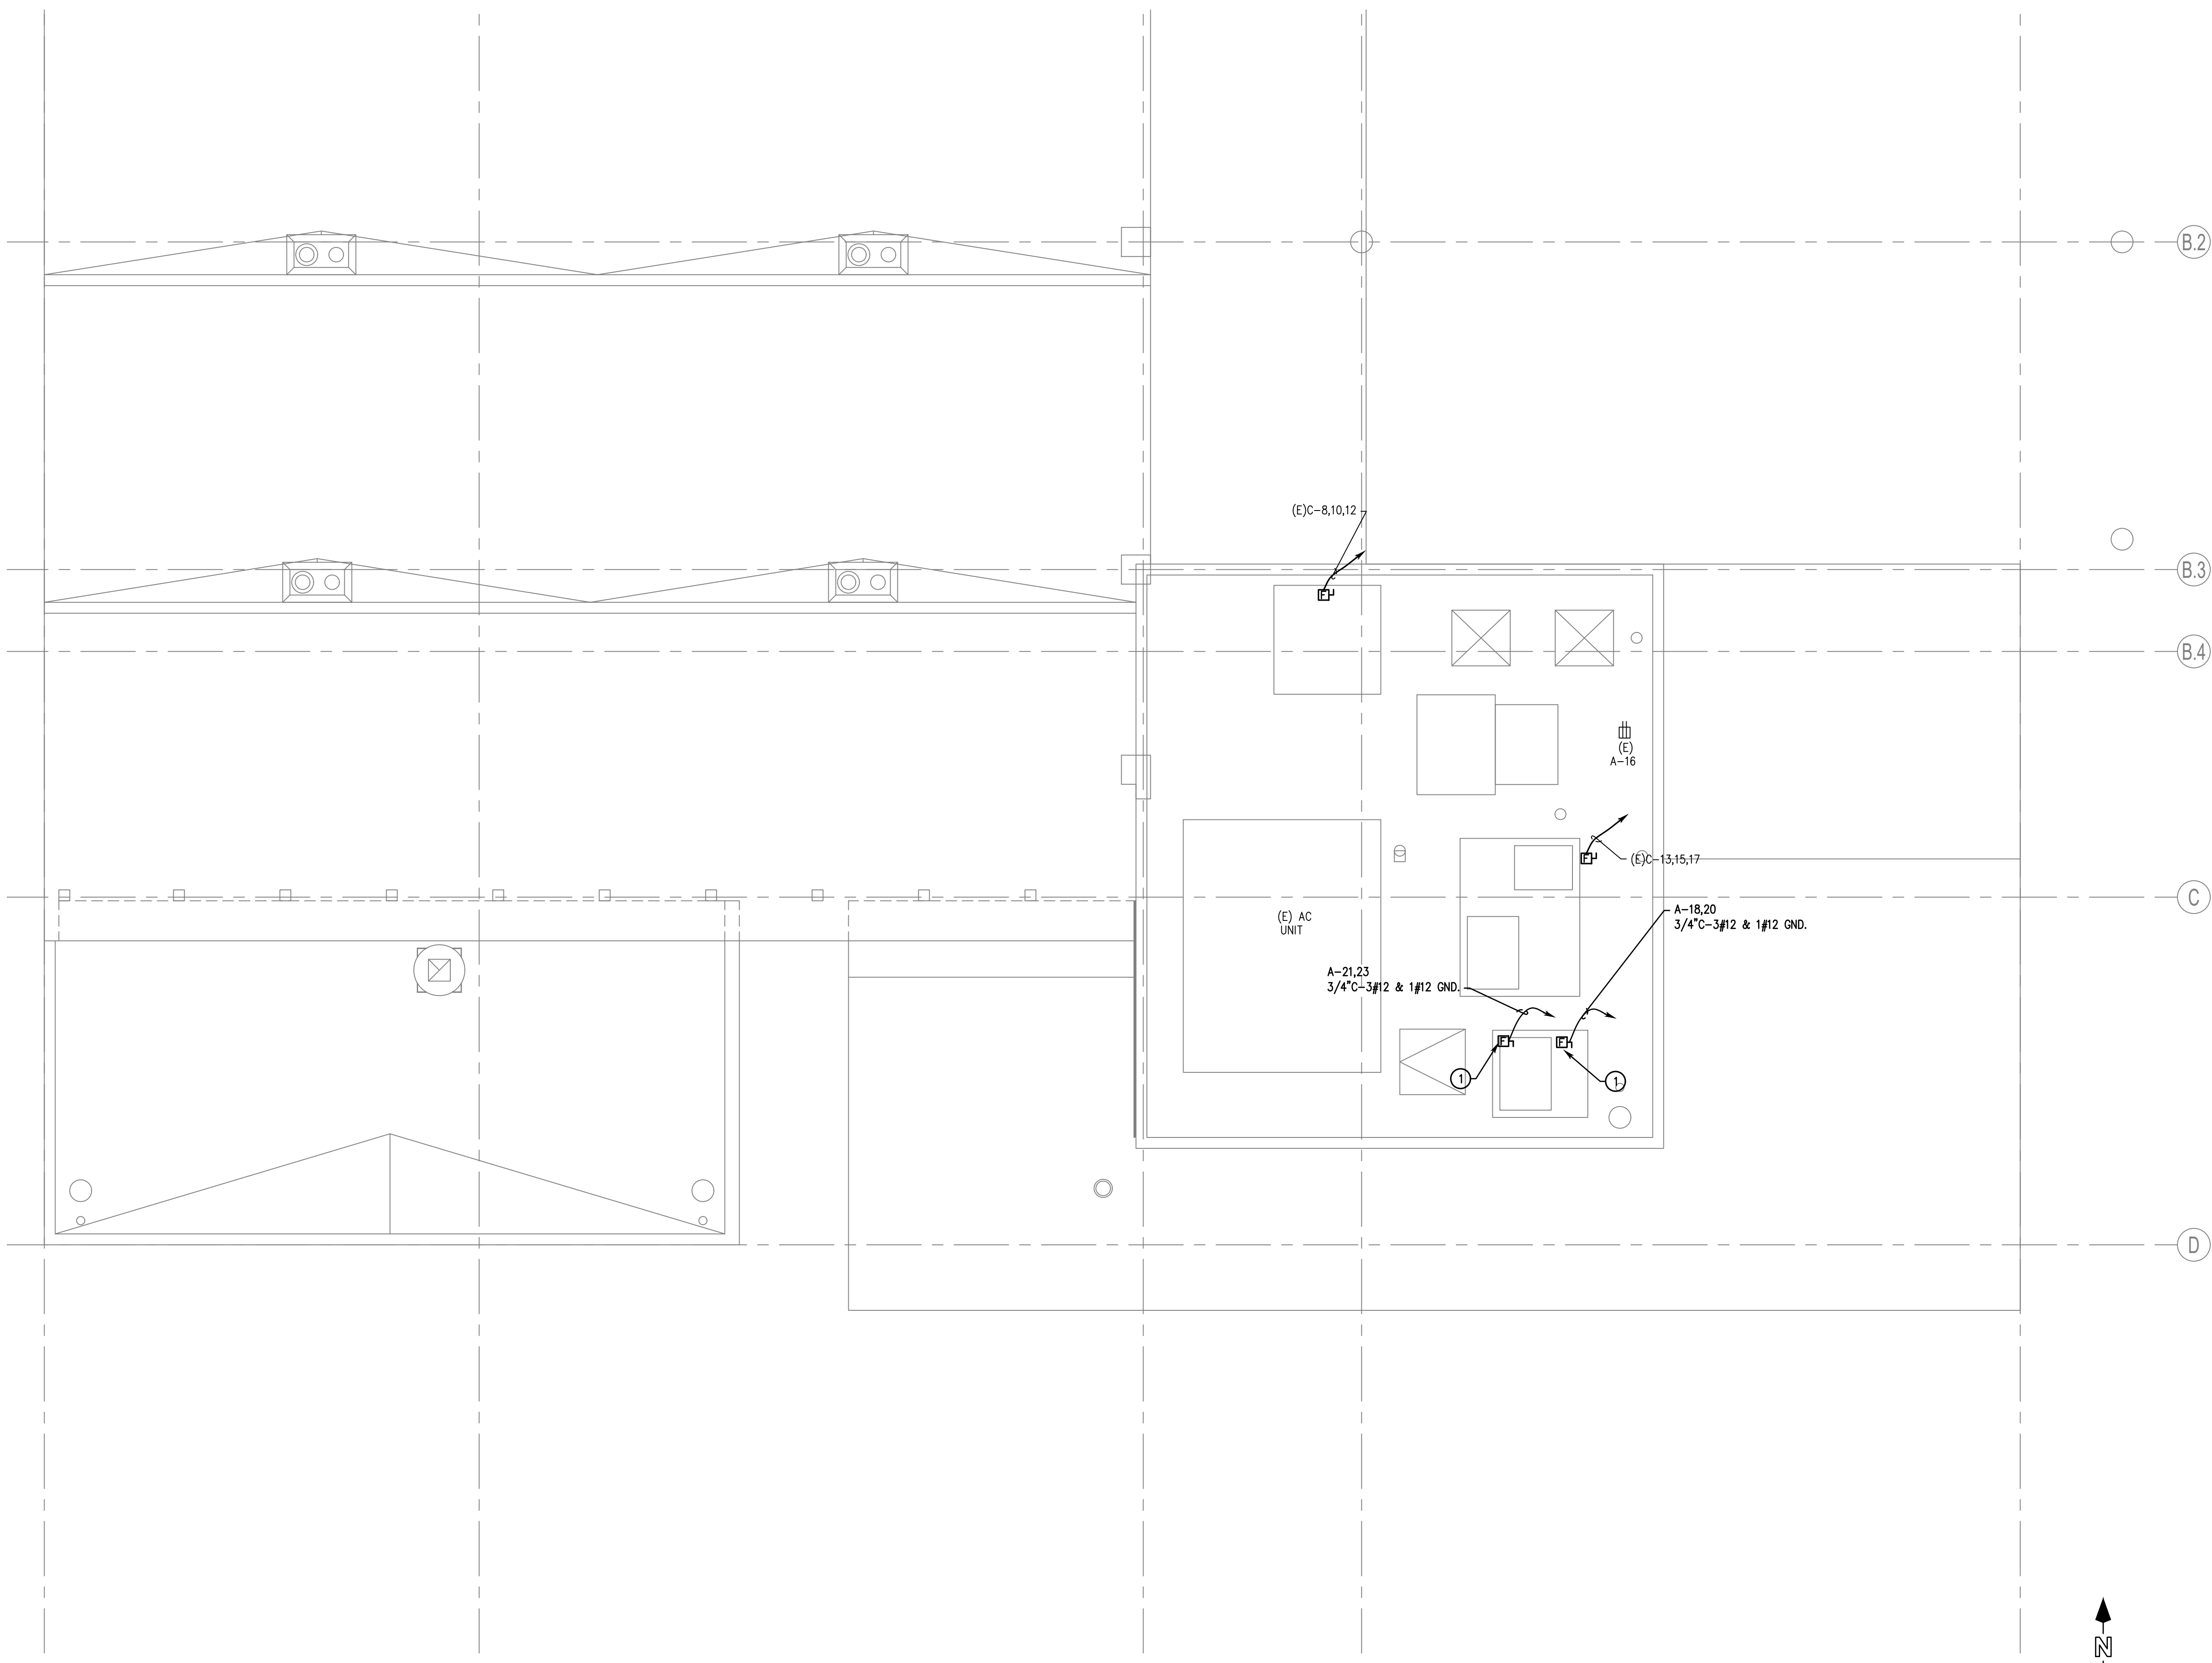
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CHECKED BY:	M.VERMA	SCALE:	AS NOTED


ENLARGED FLOOR PLAN - PROPOSED
 TOWN OF YUCCA VALLEY
 Senior Center - Kitchen Upgrades

SHEET NOTES

- 1 PROVIDE 30AS/20AF, 2P FUSED, NEMA 3R DISCONNECT SWITCH. VERIFY WITH MECHANICAL PLAN FOR ALL REQUIREMENT BEFORE ANY ROUGH-IN.



01 ENLARGED ROOF PLAN - PROPOSED
E-4.1 Scale: 1/4" = 1'-0"

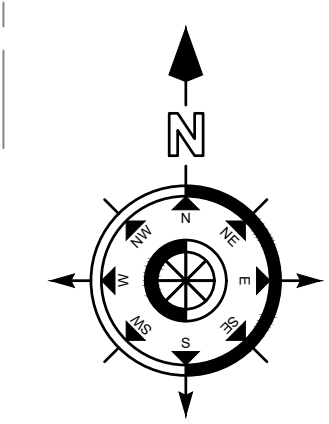

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CONSTRUCTION
SET

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ENLARGED ROOF PLAN - PROPOSED
TOWN OF YUCCA VALLEY
Senior Center - Kitchen Upgrades

GENERAL NOTES

- ALL DRAWINGS ARE CONSIDERED TO BE PART OF THE CONTRACT DOCUMENT. THE CONTRACTOR SHALL BE RESPONSIBLE FOR THE REVIEW AND COORDINATION OF ALL DRAWINGS PRIOR TO ANY CONSTRUCTION, INCLUDING STRUCTURAL, PLUMBING, AIR CONDITIONING AND ELECTRICAL. ANY DISCREPANCIES THAT OCCUR SHALL BE BROUGHT TO THE ATTENTION OF THE ENGINEER PRIOR TO THE START OF CONSTRUCTION SO THAT A CLARIFICATION CAN BE ISSUED. ANY WORK PERFORMED IN CONFLICT WITH THE CONTRACT DOCUMENTS OR ANY CODE REQUIREMENTS SHALL BE CORRECTED BY THE CONTRACTOR AT HIS OWN EXPENSE, AND AT NO EXPENSE TO THE OWNER.
- THESE DRAWINGS ARE DIAGRAMMATIC. THE LOCATION & ELEVATION OF ALL PIPING IS APPROXIMATE AND SHALL BE VERIFIED AND COORDINATED WITH ALL OTHER TRADES, STRUCTURAL CONDITIONS AND BUILDING CONSTRUCTION PRIOR TO START OF INSTALLATION.
- ALL SYMBOLS AND ABBREVIATIONS USED ON THE DRAWINGS ARE CONSIDERED TO BE CONSTRUCTION STANDARDS. IF CLARIFICATION IS REQUIRED, THE CONTRACTOR SHALL NOTIFY ENGINEER PRIOR TO PROCEEDING WITH THE WORK.
- DO NOT SCALE DRAWINGS. ALL DIMENSIONS AND JOB SITE CONDITIONS SHALL BE VERIFIED BY THE CONTRACTOR AT THE JOB SITE PRIOR TO BID SUBMITTAL, START OF CONSTRUCTION AND/OR FABRICATION OF MATERIALS. VERIFY ALL EXISTING DUCTWORK, PIPING, ELEVATIONS, SIZES AND POINT OF CONNECTIONS PRIOR TO START OF WORK. IF DISCREPANCIES ARE ENCOUNTERED, THE ENGINEER SHALL BE NOTIFIED FOR CLARIFICATION.
- THE CONTRACTOR SHALL FURNISH ALL MATERIALS, LABOR, EQUIPMENT, TRANSPORTATION AND SERVICES NECESSARY FOR COMPLETION OF THE WORK. ALL MATERIALS AND WORK SHALL COMPLY WITH APPLICABLE CODES AND GOVERNING REGULATION AND MEET THE APPROVAL OF THE CITY AND STATE FIRE MARSHALL.
- CONTRACTOR SHALL PROVIDE AND BE RESPONSIBLE FOR PROTECTION AND REPAIR OF ADJACENT EXISTING SURFACES AND AREAS WHICH MAY BE DAMAGED AS A RESULT OF DEMOLITION AND/OR NEW WORK.
- FIELD INSPECT THE PROJECT TO BE FULLY INFORMED AS TO THE SCOPE OF WORK AND ALL EXISTING CONDITIONS PRIOR TO STARTING OF WORK. VERIFY ALL EXISTING DUCTWORK, PIPING, ELEVATIONS, SIZES AND POINT OF CONNECTIONS PRIOR TO START OF WORK. NOT ALL CONDITIONS INDICATED ON PLANS.
- ALL DUCTWORK SHALL BE CONSTRUCTED, ERECTED, AND TESTED IN ACCORDANCE WITH THE MOST RESTRICTIVE OF REGULATIONS, PROCEDURES DETAILED IN THE ASHRAE HANDBOOK OF FUNDAMENTALS, OR THE APPLICABLE STANDARDS ADOPTED BY THE SHEET METAL AND AIR CONDITIONING CONTRACTORS NATIONAL ASSOCIATION.
- ALL EQUIPMENT SHALL BE INSTALLED IN STRICT ACCORDANCE WITH THE EQUIPMENT MANUFACTURER'S RECOMMENDATIONS. PROVIDE ALL FITTINGS, TRANSITIONS, DAMPERS, VALVES, AND OTHER DEVICES REQUIRED FOR A COMPLETE WORKABLE INSTALLATION.
- WRAP CONCEALED DUCTS WITH MINIMUM 1 INCH THICK FIBERGLASS DUCTWRAP (ALL SUPPLY DUCT TO HAVE VAPOR BARRIER). ALL NEW SUPPLY AND RETURN DUCT INSULATION WITHIN THE BUILDING TO HAVE MINIMUM 6.0 R-VALUE. INSTALL DOUBLE WALL DUCTS FOR ALL EXPOSED OUTDOOR SUPPLY AND RETURN DUCTS WITH AT LEAST 8.0 R-VALUE INSULATION.
- INSULATION APPLIED TO THE EXTERIOR SURFACE OF DUCTS LOCATED IN BUILDINGS SHALL HAVE A FLAME SPREAD OF NOT MORE THAN 25 AND SMOKE DEVELOPED RATING OF NOT MORE THAN 50 WHEN TESTED AS A COMPOSITE INSTALLATION INCLUDING INSULATION, FACING MATERIALS, TAPES AND ADHESIVES AS NORMALLY APPLIED.
- ENTIRE INSTALLATION SHALL CONFORM TO THE REQUIREMENTS OF THE 2019 CALIFORNIA MECHANICAL CODE (C.M.C.), 2019 CALIFORNIA BUILDING CODE (C.B.C.) AND ALL OTHER APPLICABLE CODES AND REGULATIONS.
- INSTALLATION SHALL BE COMPLIANT WITH 2019 CBC SECTION 425, APPLICABLE NFPA CODE SECTIONS AND SECTION 1632A AND CHAPTER 35 OF 2019 CBC.
- MANUFACTURER'S INSTALLATION INSTRUCTIONS SHALL BE MADE AVAILABLE TO THE INSPECTING AUTHORITIES.
- AIR LEAKAGE TESTING SHALL BE PERFORMED BY SMACNA HVAC DUCT LEAKAGE TEST MANUAL.
- USE YOUNG REGULATOR FOR VOLUME DAMPER FOR AT INACCESSIBLE CEILING.
- LINE VOLTAGE WIRING, ALL CONDUIT, DISCONNECT SWITCHES AND FINAL CONNECTION BY ELECTRICAL CONTRACTOR. LOW VOLTAGE CONDUIT AND WIRING AND FINAL CONNECTION BY MECHANICAL CONTRACTOR.
- THE TOTAL SYSTEM AIR BALANCE SHALL BE PERFORMED BY AN INDEPENDENT AGENCY CERTIFIED BY THE AABC OR NEBB. THIS WORK SHALL CONFORM TO AABC OR NEBB SPECIFICATIONS AS REFERRED TO IN THE NATIONAL STANDARDS.
- ALL PIPING AND DUCT WORK SHALL BE INSULATED CONSISTENT WITH THE REQUIREMENTS OF SECTIONS 118, 123, 124, E.E.S. AND TABLE 6D OF 2019 CMC.
- IF THE PROJECT WILL BE CONSTRUCTED IN MULTIPLE PHASES, IT IS THE CONTRACTOR'S RESPONSIBILITY TO COORDINATE THEIR WORK WITH THE ARCHITECTURAL PHASING PLANS AND ALL OTHER TRADES AND INSTALL IN SUCH A WAY THAT IT DOES NOT AFFECT THE ADJOINING OCCUPIED SPACES AND MEETS ALL OF THE REQUIREMENTS OF CONTRACT DOCUMENTS AND SPECIFICATIONS AS PART OF THE BASE BID.
- AUTOMATIC SHUTOFFS:
PER SEC. 609 OF 2019 CMC WHEN REQUIRED, EACH SINGLE SYSTEM PROVIDING HEATING OR COOLING AIR IN EXCESS OF 2000 CUBIC FEET PER MINUTE SHALL BE EQUIPPED WITH AN AUTOMATIC SHUTOFF. AUTOMATIC SHUTOFF SHALL BE ACCOMPLISHED BY INTERRUPTING THE POWER SOURCE OF THE AIR MOVING EQUIPMENT DEVICES WHICH WILL DETECT PRODUCTS OF COMBUSTION OTHER THAN HEAT AND WHICH COMPLY WITH THE UBC, SHALL BE LABELED BY AN APPROVED AGENCY FOR AIR DUCT INSTALLATION AND SHALL BE INSTALLED IN ACCORDANCE WITH THE MANUFACTURER'S INSTALLATION INSTRUCTIONS. SUCH DEVICES SHALL BE COMPATIBLE WITH THE OPERATING VELOCITIES, PRESSURES, TEMPERATURES AND HUMIDITY OF THE SYSTEM WHERE FIRE DETECTION OR ALARM SYSTEMS ARE PROVIDED FOR THE BUILDING, SMOKE DETECTORS SHALL BE SUPERVISED BY SUCH SYSTEMS.

NOTE: FOR THE PURPOSE OF CLEARNESS AND LEGIBILITY, THE DRAWINGS ARE ESSENTIALLY DIAGRAMMATIC AND ALTHOUGH SIZES AND LOCATIONS OF EQUIPMENT IS DRAWN TO SCALE WHEREVER POSSIBLE, THE CONTRACTOR SHALL MAKE USE OF ALL DATA IN ALL OF THE CONTRACT DOCUMENTS AND VERIFY THIS INFORMATION BEFORE ORDERING, FABRICATING OR INSTALLATION OF ANY MATERIALS.
- HVAC SYSTEM AND COMPONENTS WILL BE TESTED, ADJUSTED AND BALANCED IN ACCORDANCE WITH AABC'S NATIONAL STANDARDS FOR TOTAL SYSTEM BALANCE 6TH EDITION.

MANDATORY NONRESIDENTIAL CALGREEN REQUIREMENTS

SECTION 5.410 – BUILDING MAINTENANCE AND OPERATION

- 5.410.4 TESTING AND ADJUSTING. TESTING AND ADJUSTING OF SYSTEMS SHALL BE REQUIRED FOR BUILDINGS LESS THAN 10,000 SQUARE FEET. APPLIES TO NEW SYSTEMS SERVING ADDITIONS OR ALTERATIONS.
- 5.410.4.2 SYSTEMS. DEVELOP A WRITTEN PLAN OF PROCEDURES FOR TESTING AND ADJUSTING SYSTEMS FOR
 A. HVAC SYSTEMS AND CONTROLS
 B. INDOOR AND OUTDOOR LIGHTING AND CONTROLS
 C. WATER HEATING SYSTEMS
 D. RENEWABLE ENERGY SYSTEMS
 E. LANDSCAPE IRRIGATION SYSTEMS
 F. WATER RESCUE SYSTEMS
 G. SYSTEMS TO BE INCLUDED FOR TESTING AND ADJUSTING SHALL INCLUDE, AS APPLICABLE TO THE PROJECT, THE SYSTEMS LISTED IN SECTION 5.410.4.2.
- 5.410.4.3 PROCEDURES. PERFORM TESTING AND ADJUSTING PROCEDURES IN ACCORDANCE WITH APPLICABLE STANDARDS ON HVAC SYSTEM AND CONTROLS AS DETERMINED BY THE ENFORCING AGENCY.
- 5.410.4.3.1 HVAC BALANCING. BEFORE A NEW SPACE-CONDITIONING SYSTEM SERVING A BUILDING OR SPACE IS OPERATED FOR NORMAL USE, BALANCE IN ACCORDANCE WITH THE PROCEDURES DEFINED BY NATIONAL STANDARDS LISTED IN SECTION 5.410.4.3.1 OR AS APPROVED BY THE ENFORCING AGENCY.
- 5.410.4.4 REPORTING. AFTER COMPLETION OF TESTING, ADJUSTING AND BALANCING, PROVIDE A FINAL REPORT OF TESTING SIGNED BY THE INDIVIDUAL RESPONSIBLE FOR PERFORMING THESE SERVICES.
- 5.410.4.5 OPERATION AND MAINTENANCE (O & M) MANUAL. PROVIDE THE BUILDING OWNER WITH DETAILED OPERATING AND MAINTENANCE INSTRUCTIONS AND COPIES OF GUARANTIES/WARRANTIES FOR EACH SYSTEM PRIOR TO FINAL INSPECTION.
- 5.410.4.5.1 INSPECTIONS AND REPORTS. INCLUDE A COPY OF ALL INSPECTION VERIFICATIONS AND REPORTS REQUIRED BY THE ENFORCING AGENCY.

SECTION 5.504 – POLLUTANT CONTROL

- 5.504.1 TEMPORARY VENTILATION. IF THE HVAC SYSTEM IS USED DURING CONSTRUCTION, USE RETURN AIR FILTERS WITH A MERV OF 13, BASED ON ASHRAE 52.2-1999, OR AN AVERAGE EFFICIENCY OF 30% BASED ON ASHRAE 52.1-1992. REPLACE ALL FILTERS IMMEDIATELY PRIOR TO OCCUPANCY.
- 5.504.3 COVERING OF DUCT OPENINGS AND PROTECTION OF MECHANICAL EQUIPMENT DURING CONSTRUCTION. AT THE TIME OF ROUGH INSTALLATION AND DURING STORAGE ON THE CONSTRUCTION SITE AND UNTIL FINAL STARTUP OF THE HEATING, COOLING AND VENTILATING EQUIPMENT, ALL DUCT AND OTHER RELATED AIR DISTRIBUTION COMPONENT OPENINGS SHALL BE COVERED WITH TAPE, PLASTIC, SHEET METAL OR OTHER METHODS ACCEPTABLE TO THE ENFORCING AGENCY TO REDUCE THE AMOUNT OF DUST, WATER AND DEBRIS WHICH MAY ENTER THE SYSTEM.
- 5.504.5.3 FILTERS. IN MECHANICALLY VENTILATED BUILDINGS, PROVIDE REGULARLY OCCUPIED AREAS OF THE BUILDING WITH AIR FILTRATION MEDIA FOR OUTSIDE AND RETURN AIR THAT PROVIDES AT LEAST A MERV OF 13. MERV 13 FILTERS SHALL BE INSTALLED PRIOR TO OCCUPANCY, AND RECOMMENDATIONS FOR MAINTENANCE WITH FILTERS OF THE SAME VALUE SHALL BE INCLUDED IN THE OPERATION AND MAINTENANCE MANUAL.

SECTION 5.506 – INDOOR AIR QUALITY

- 5.506.1 OUTSIDE AIR DELIVERY. FOR MECHANICALLY OR NATURALLY VENTILATED SPACES IN BUILDINGS, MEET THE MINIMUM REQUIREMENTS OF SECTION 120.1 OF THE CALIFORNIA ENERGY CODE AND CHAPTER 4 OF CCR, TITLE 8 OR THE APPLICABLE LOCAL CODE, WHICHEVER IS MORE STRINGENT.
- 5.506.2 CARBON DIOXIDE (CO2) MONITORING. FOR BUILDINGS OR ADDITIONS EQUIPPED WITH DEMAND CONTROL VENTILATION, CO2 SENSORS AND VENTILATION CONTROLS SHALL BE SPECIFIED AND INSTALLED IN ACCORDANCE WITH THE REQUIREMENTS OF THE CALIFORNIA ENERGY CODE, CCR, SECTION 120(C)(4).
- SECTION 5.508 – OUTDOOR AIR QUALITY**
- 5.508.1 OZONE DEPLETION AND GLOBAL WARMING REDUCTIONS. INSTALLATIONS OF HVAC, REFRIGERATION AND FIRE SUPPRESSION EQUIPMENT SHALL COMPLY WITH SECTIONS 5.508.1.1 AND 5.508.1.2.
- 5.508.1.1 CFCs. INSTALL HVAC AND REFRIGERATION EQUIPMENT THAT DOES NOT CONTAIN CFCs.
- 5.508.1.2 HALONS. INSTALL FIRE SUPPRESSION EQUIPMENT THAT DOES NOT CONTAIN HALONS.

SHEET INDEX

SHT.NO.	DESCRIPTION
M-0.1	MECHANICAL LEGEND AND NOTES
M-0.2	MECHANICAL DETAILS
M-1.1	OVERALL FLOOR PLAN
M-2.1	ENLARGED FLOOR PLAN – EXISTING/DEMO
M-3.1	ENLARGED FLOOR PLAN – PROPOSED
M-4.1	ENLARGED ROOF PLAN – PROPOSED

APPLICABLE CODES

- 2019 CALIFORNIA BUILDING CODE (CBC)
- 2019 CALIFORNIA ELECTRICAL CODE (CEC)
- 2019 CALIFORNIA MECHANICAL CODE (CMC)
- 2019 CALIFORNIA PLUMBING CODE (CPC)
- 2019 CALIFORNIA ENERGY STANDARDS CODE (CESC)

MECHANICAL LEGEND

SYMBOL	ABBV.	DESCRIPTION
	SWS	SIDEWALL DIFFUSER – SUPPLY
	CD	CEILING DIFFUSER – SUPPLY
	CD	CEILING DIFFUSER BELOW DUCT – SUPPLY
	SAD	RISER – SUPPLY AIR DUCT
	SAD	DROP – SUPPLY AIR DUCT
	SAD	ROUND DROP – SUPPLY AIR DUCT
	SWR	SIDEWALL REGISTER – RETURN
	CR	CEILING REGISTER – RETURN
	CR	CEILING REGISTER BELOW DUCT – RETURN
	RAD	RISER – RETURN AIR DUCT
	RAD	DROP – RETURN AIR DUCT
	SWE	SIDEWALL REGISTER – EXHAUST
	CR	CEILING REGISTER – EXHAUST
	CD	CEILING DIFFUSER BELOW DUCT – EXHAUST
	EAD	RISER – EXHAUST AIR DUCT
	EAD	DROP – EXHAUST AIR DUCT
	L	LINED DUCTWORK
	VD	VOLUME DAMPER
	FC	FLEXIBLE CONNECTION
		NEW DUCT
		EXISTING DUCT – NEW PLAN
		EXISTING DUCT – DEMOLITION PLAN
		EXISTING MECHANICAL WORK TO BE REMOVED
	FSD	FIRE SMOKE DAMPER
	UC	UNDER CUT DOOR
	TSTAT	THERMOSTAT
	POC	POINT OF CONNECTION
	POD	POINT OF DEMOLITION
	OSA	OUTSIDE AIR
	UTR	UP THRU ROOF
	CSFD	COMBINATION SMOKE/FIRE DAMPER
	F	FUSIBLE LINK FIRE DAMPER
	N.T.S.	NOT TO SCALE

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CONSTRUCTION SET

JOB NO.:	21122	DATE:	12/08/2021
DRAWN BY:	H-SHETH	CHECKED BY:	H-SHETH
SCALE:	AS NOTED		

MECHANICAL LEGEND AND NOTES

TOWN OF YUCCA VALLEY
Senior Center - Kitchen Upgrades

M-0.1



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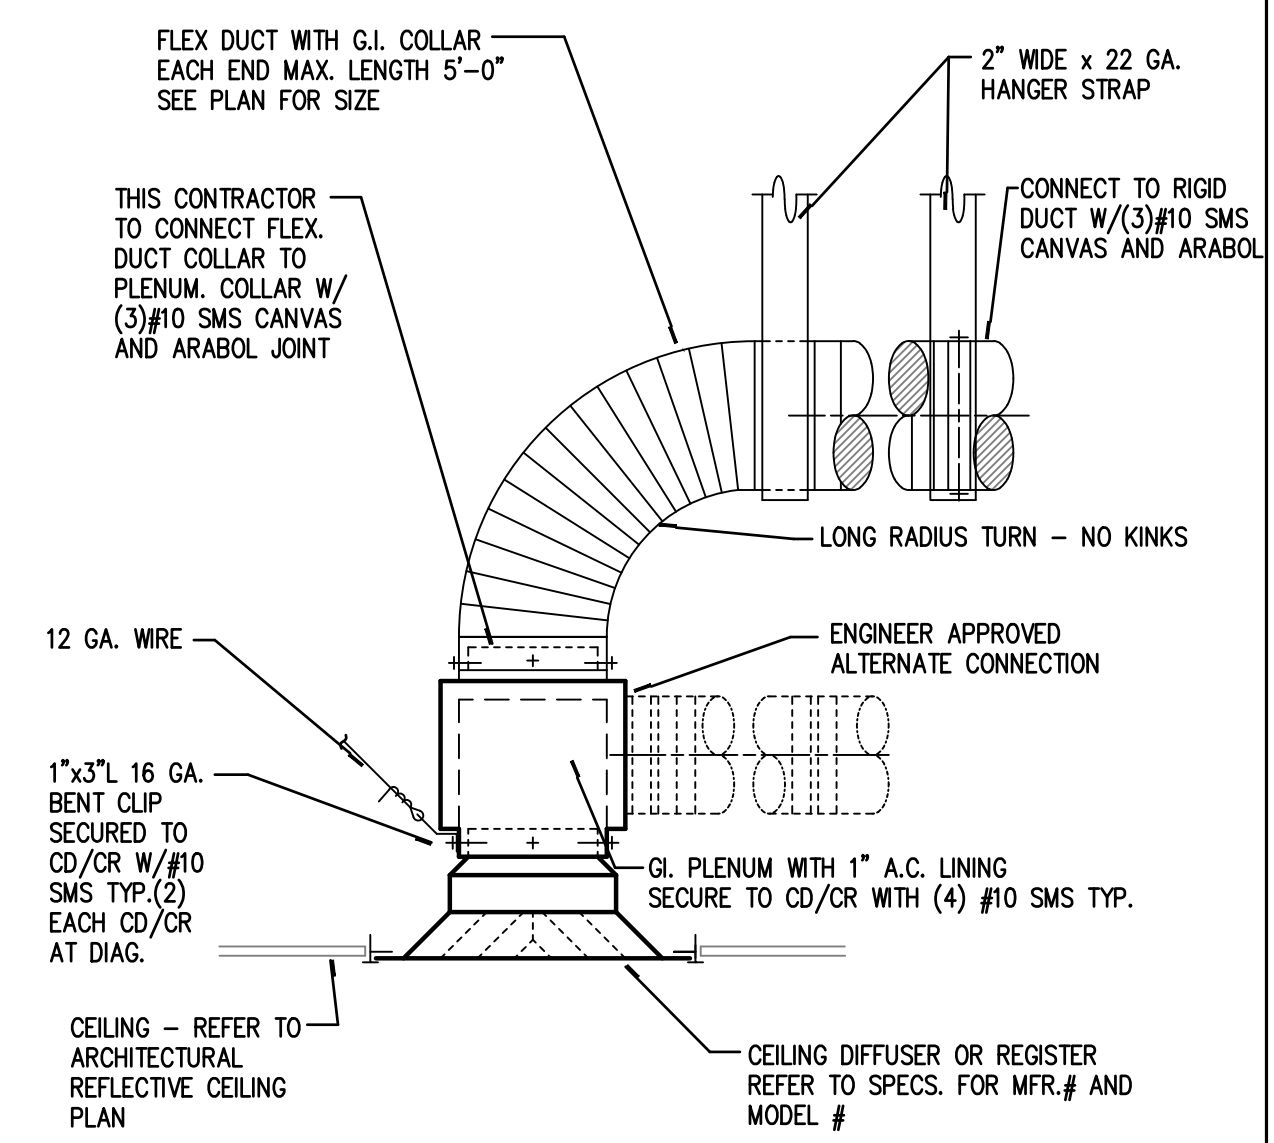
CONSTRUCTION SET

JOB NO.:	21122	DATE:	12/08/2021
DRAWN BY:	H.SHEETH	CHECKED BY:	H.SHEETH
SCALE:	AS NOTED		


MECHANICAL DETAILS

TOWN OF YUCCA VALLEY
Senior Center - Kitchen Upgrades

M-0.2




AIR DISTRIBUTION DETAIL SCALE: 3 NTS

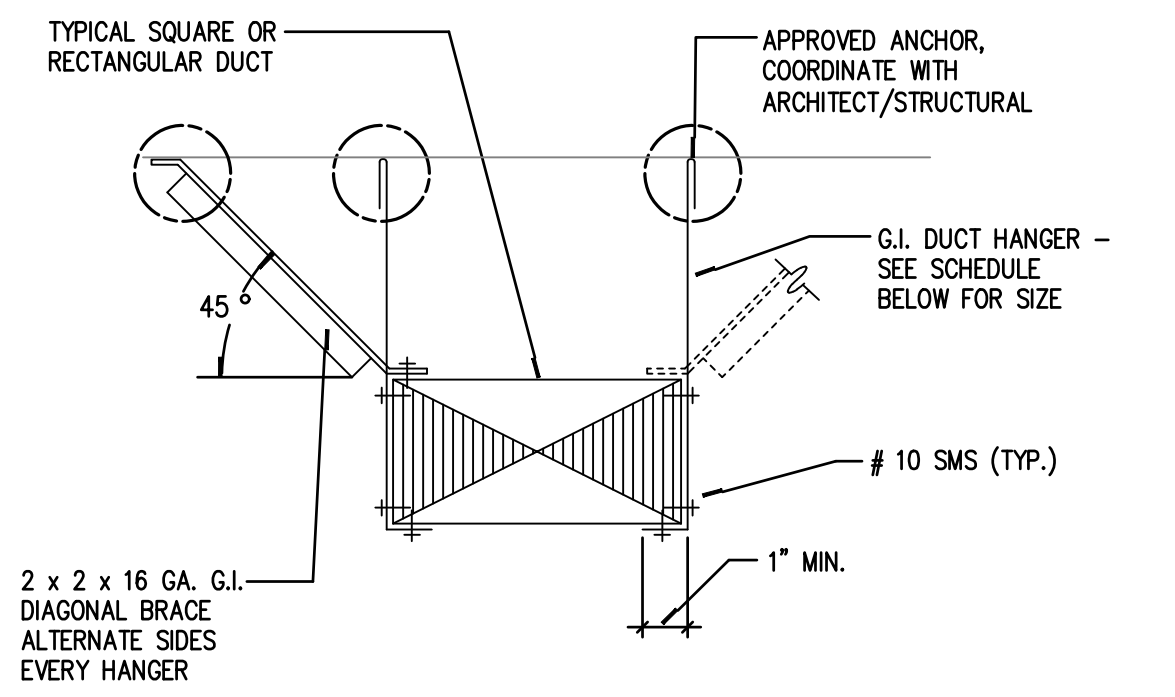


NOTE:
WHERE DUCT IS 6 SF. OR LARGER IN CROSS SECTIONAL AREA - USE 2 1/2 x 2 1/2 x 16 GA. VERTICAL ANGLE IN PLACE OF HANGER AT SEISMIC BRACE.

MAX. HALF OF DUCT PERIMETER	MAX. LOAD EACH HANGER	HANGER SIZE	HANGER SPACING
P/2 = 30"	260 LBS	1" x 22 GA.	10'-0" O/C
P/2 = 72"	420 LBS	1" x 18 GA.	10'-0" O/C
P/2 = 96"	700 LBS	1" x 16 GA.	10'-0" O/C
P/2 = 120"	1100 LBS	1 1/2" x 16 GA.	10'-0" O/C

RECT. METAL DUCT SUPPORT DETAIL SCALE: 8 NTS

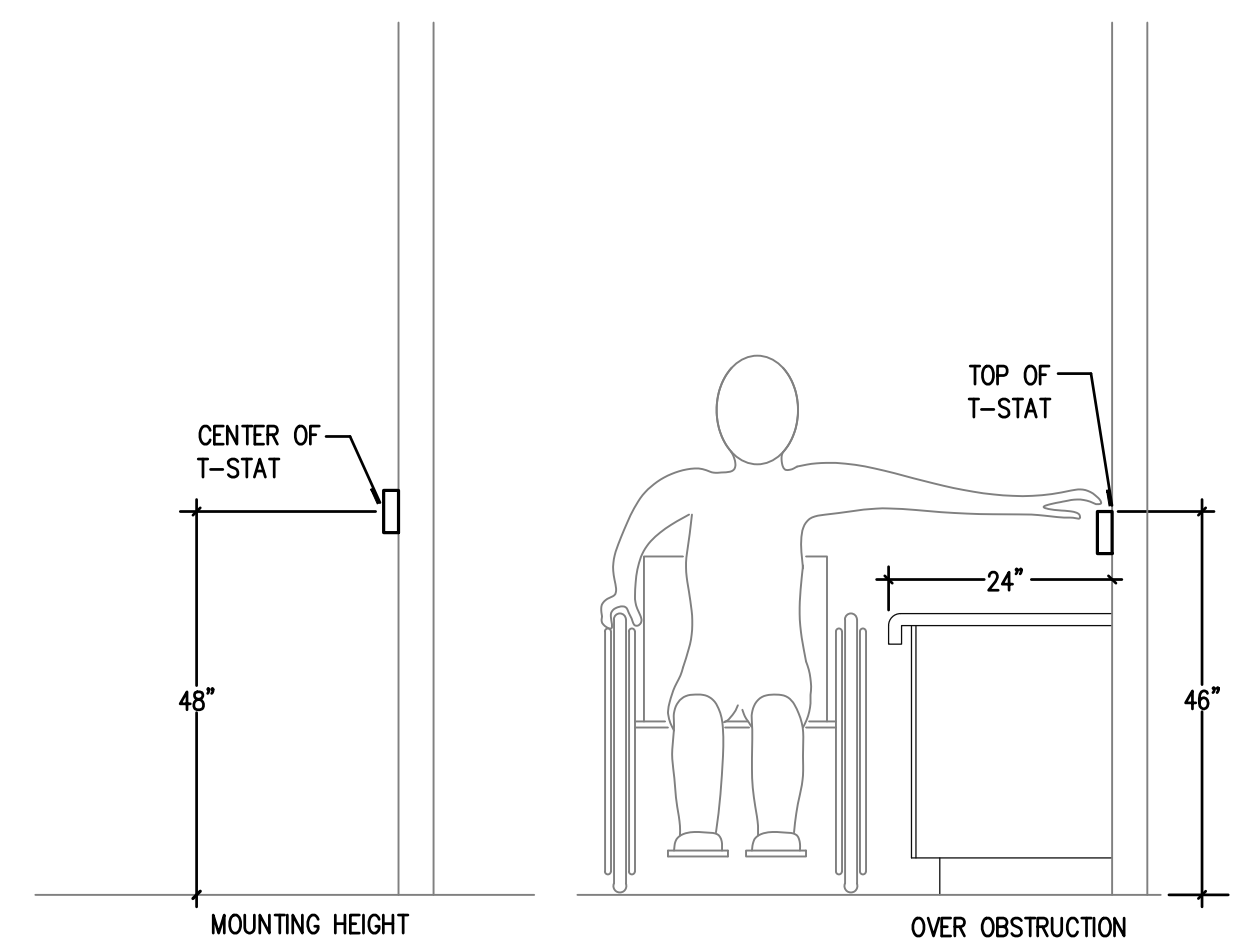

T-STAT MOUNTING DETAIL SCALE: 4 NTS

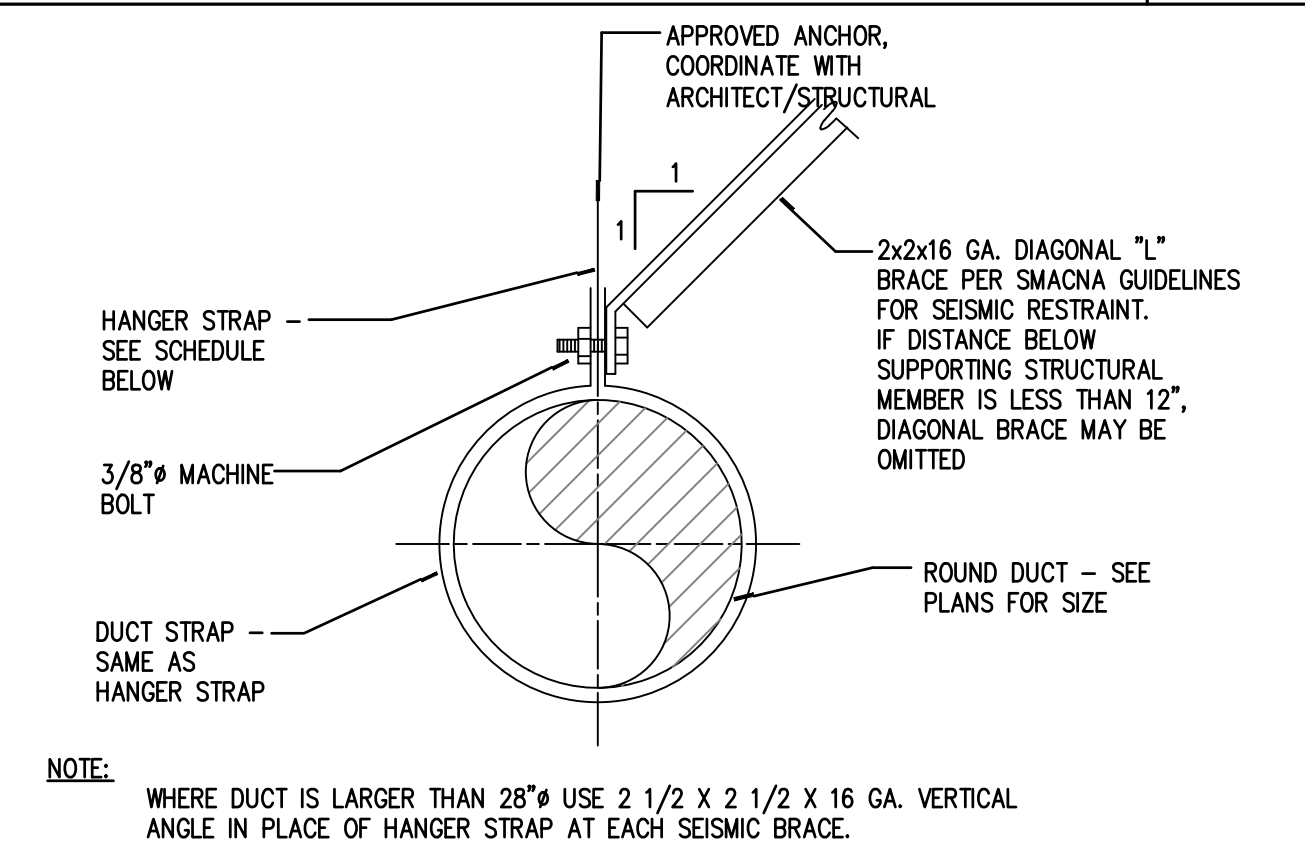

NOTE:
WHERE DUCT IS LARGER THAN 28" Ø USE 2 1/2 x 2 1/2 x 16 GA. VERTICAL ANGLE IN PLACE OF HANGER STRAP AT EACH SEISMIC BRACE.

HANGER STRAP SCHEDULE			
DUCT SIZE	HANGER SIZE	MAX. LOAD EA. HANGER	MAX. SPACING
UP THRU 10"	1" x 22 GA.	260 LBS	10'-0"
11" TO 18"	1" x 22 GA.	260 LBS	10'-0"
19" TO 24"	1" x 22 GA.	260 LBS	10'-0"
25" TO 36"	1" x 20 GA.	320 LBS	10'-0"

ROUND DUCT SUPPORT DETAIL SCALE: 2 NTS

NOT USED SCALE: 7 NTS


NOT USED SCALE: 5 NTS



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01 OVERALL FLOOR PLAN
 M-1.1 Scale: 1/8" = 1'-0"



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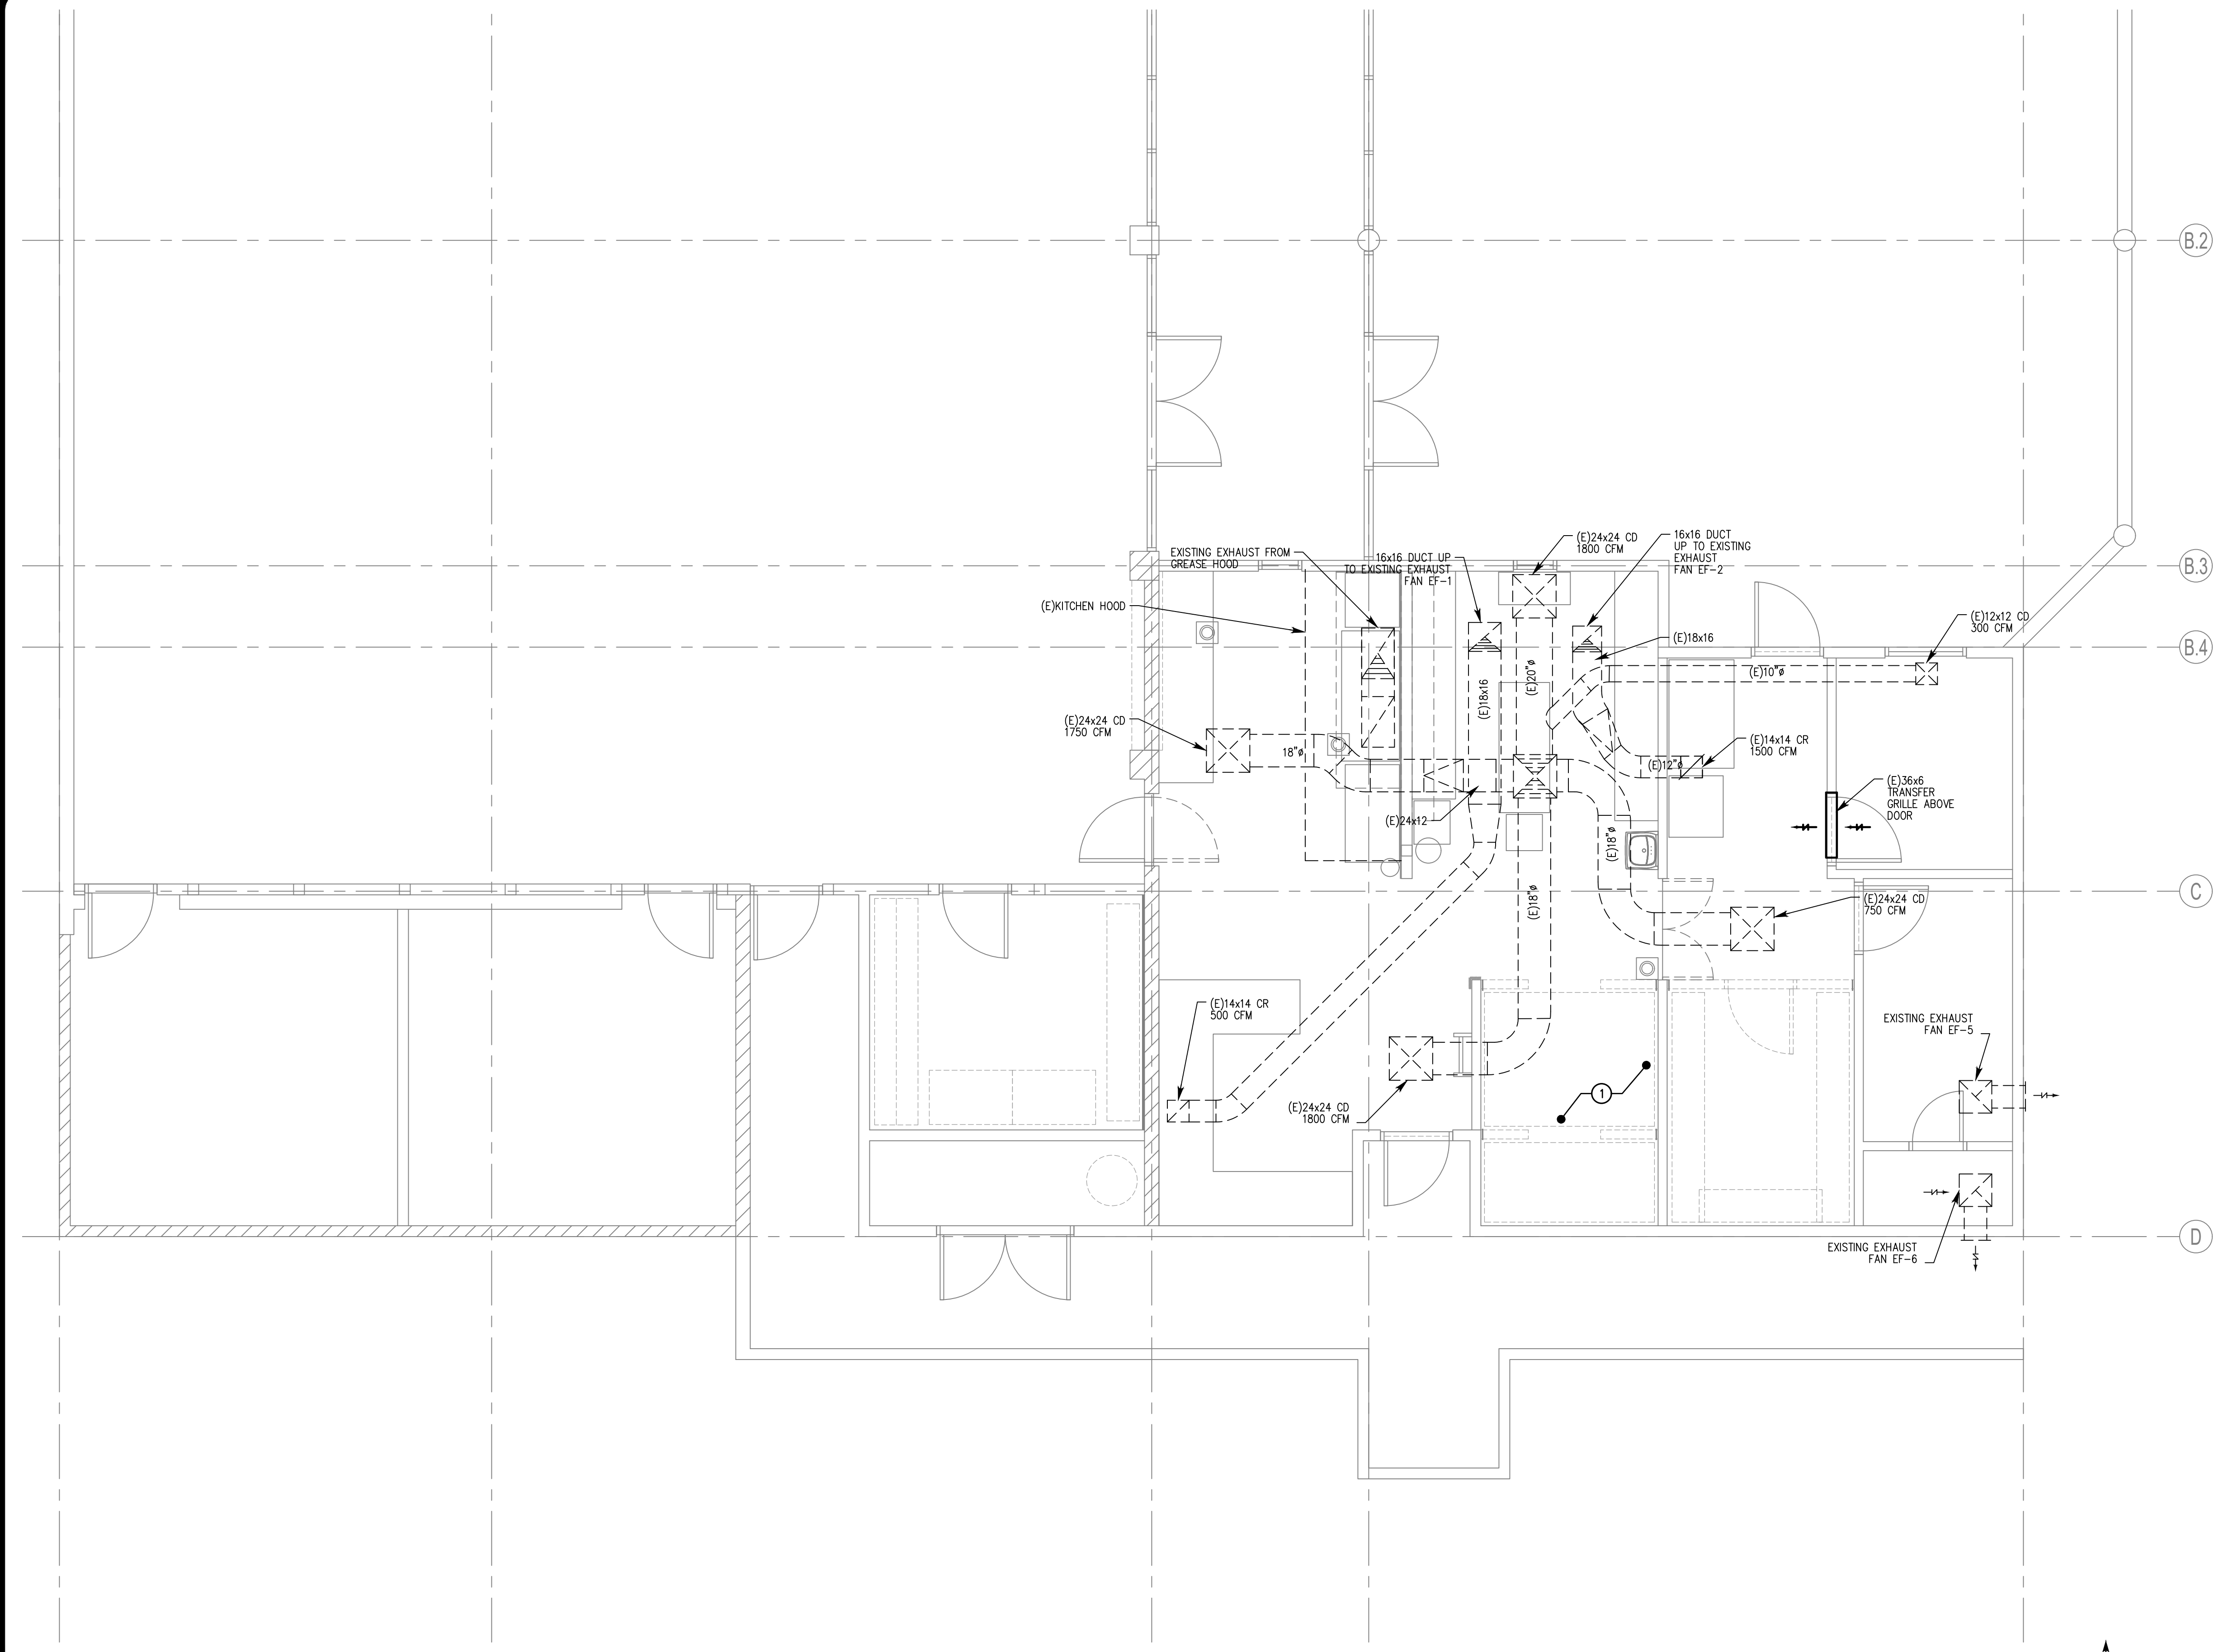
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OVERALL FLOOR PLAN
TOWN OF YUCCA VALLEY
 Senior Center - Kitchen Upgrades

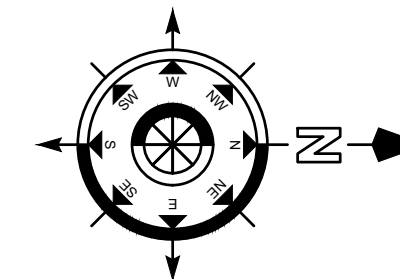M-1.1

SHEET NOTES

- 1 EXISTING EXHAUST AND SUPPLY TO REMAIN AS IS IN THE SPACE. NO ADDITIONAL WORK IS REQUIRED EXCEPT FOR ROOM 115 STORAGE. ALL EXISTING HVAC TO REMAIN AND TO BE PROTECTED IN PLACE. ALL EXISTING DUCTWORK SHOWS IN APPROXIMATE ONLY AND MAY NOT REPRESENT EXACT CONDITIONS. CONTRACT SHALL FIELD VERIFY TO MAKE SURE ALL EXISTING SYSTEM IS PROTECTED IN PLACE.



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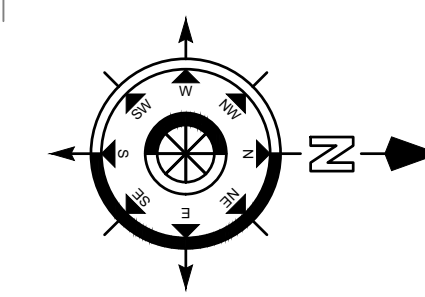
CONSTRUCTION SET

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ENLARGED FLOOR PLAN - EXISTING/DEMO
TOWN OF YUCCA VALLEY
Senior Center - Kitchen Upgrades

M-2.1

01 ENLARGED FLOOR PLAN - EXISTING/DEMO
M-2.1 Scale: 1/4" = 1'-0"



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SHEET NOTES

- ① ALL EXISTING HVAC TO REMAIN AS IS. NO ADDITIONAL WORK IS REQUIRED EXCEPT FOR ROOM 115 STORAGE.
- ② PROVIDE A CEILING MOUNTED EXHAUST FAN. FAN SHALL RUN AT ALL TIMES. PROVIDE A LOCAL SWITCH FOR CONTROL.

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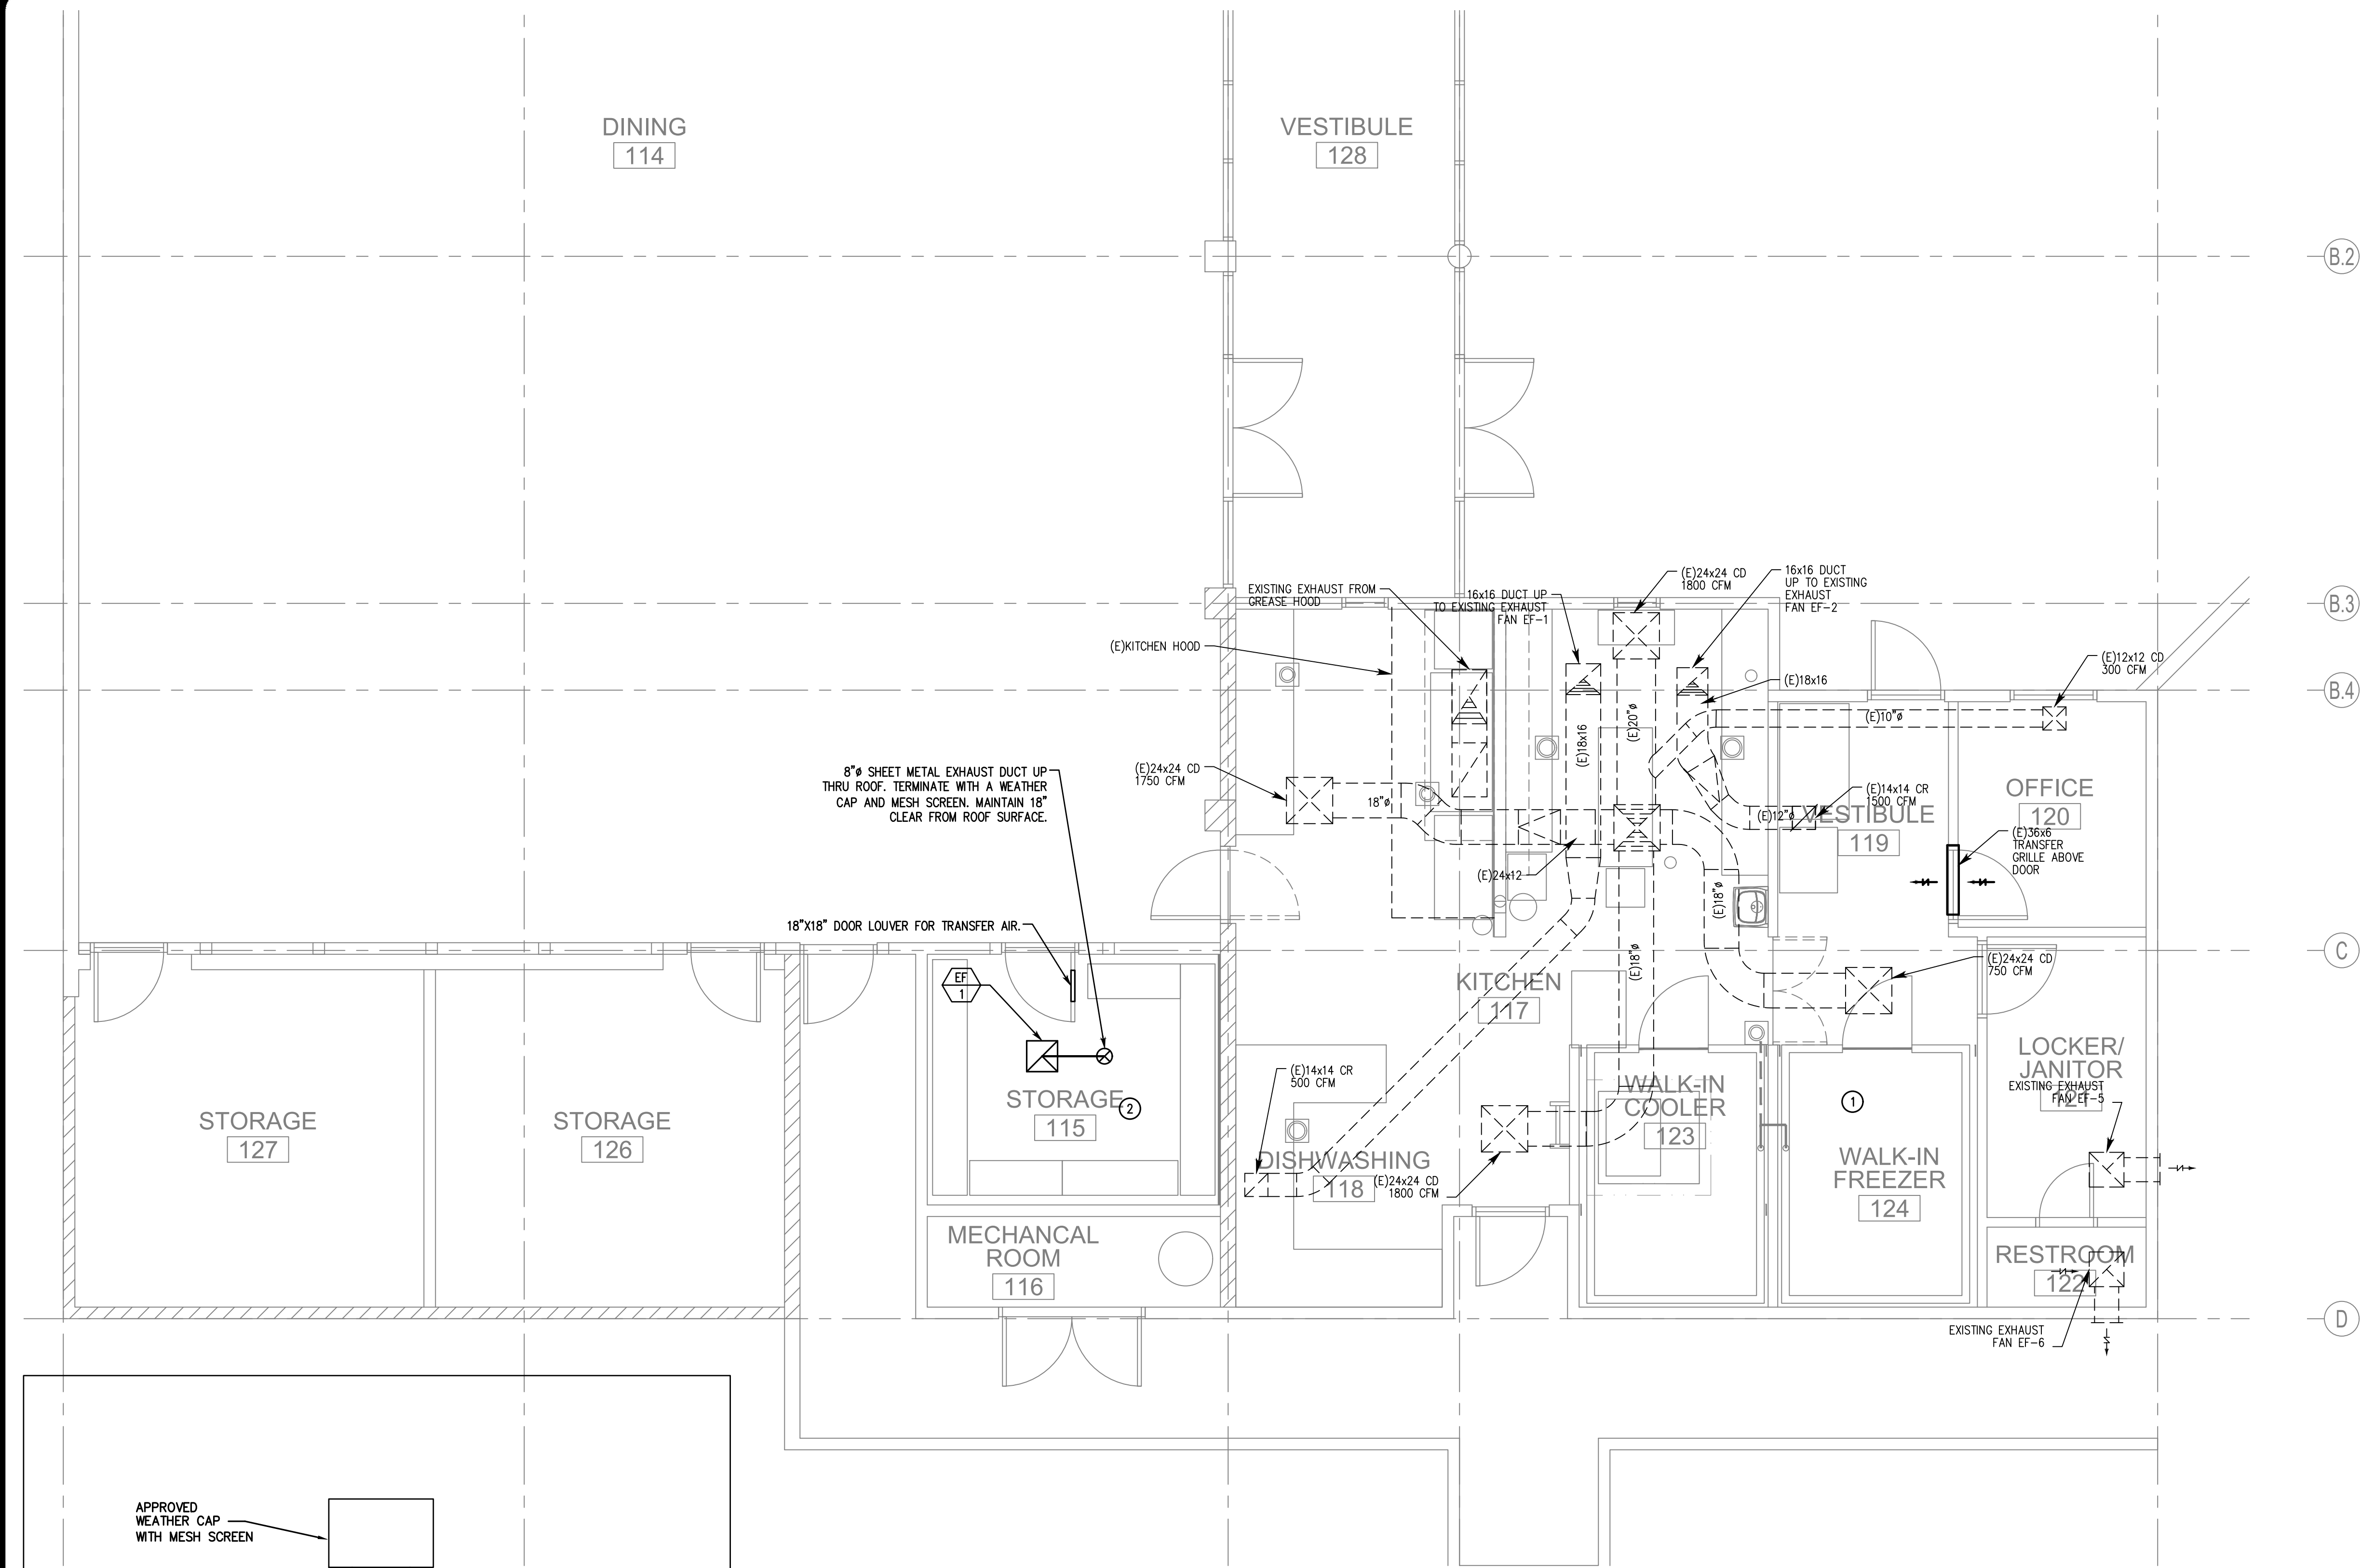
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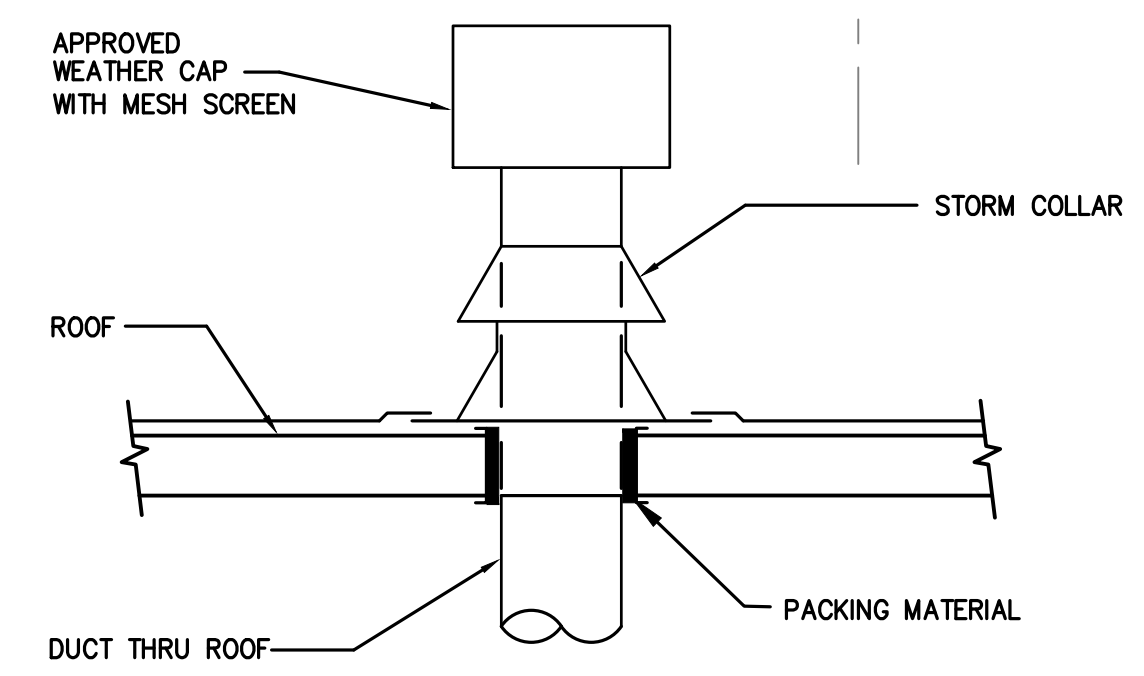
ENLARGED FLOOR PLAN - PROPOSED
TOWN OF YUCCA VALLEY
Senior Center - Kitchen Upgrades

M-3.1



8" SHEET METAL EXHAUST DUCT UP THRU ROOF. TERMINATE WITH A WEATHER CAP AND MESH SCREEN. MAINTAIN 18" CLEAR FROM ROOF SURFACE.


18"x18" DOOR LOUVER FOR TRANSFER AIR.





EXHAUST AIR TERMINATION ABOVE ROOF DETAIL SCALE: NTS 1

EXHAUST FAN SCHEDULE									
TAG	MANUFACTURER	SERVING	CFM	ESP (W.G)	FAN RPM	POWER (HP)	SUPPLY VOLTAGE	WEIGHT LBS	NOTES
EF-1	GREENHECK SPB200	STORAGE ROOM	175	0.3	1700	175 W	115/160	40	RUN AT ALL TIMES.


01 ENLARGED FLOOR PLAN - PROPOSED
M-3.1 Scale: 1/4" = 1'-0"

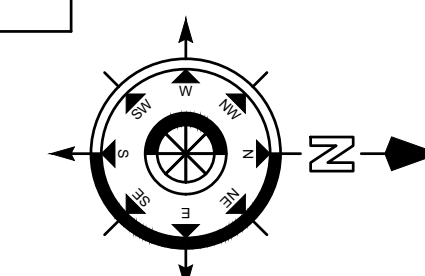

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01 ENLARGED ROOF PLAN - PROPOSED
 M-4.1 Scale : 1/4" = 1'-0"

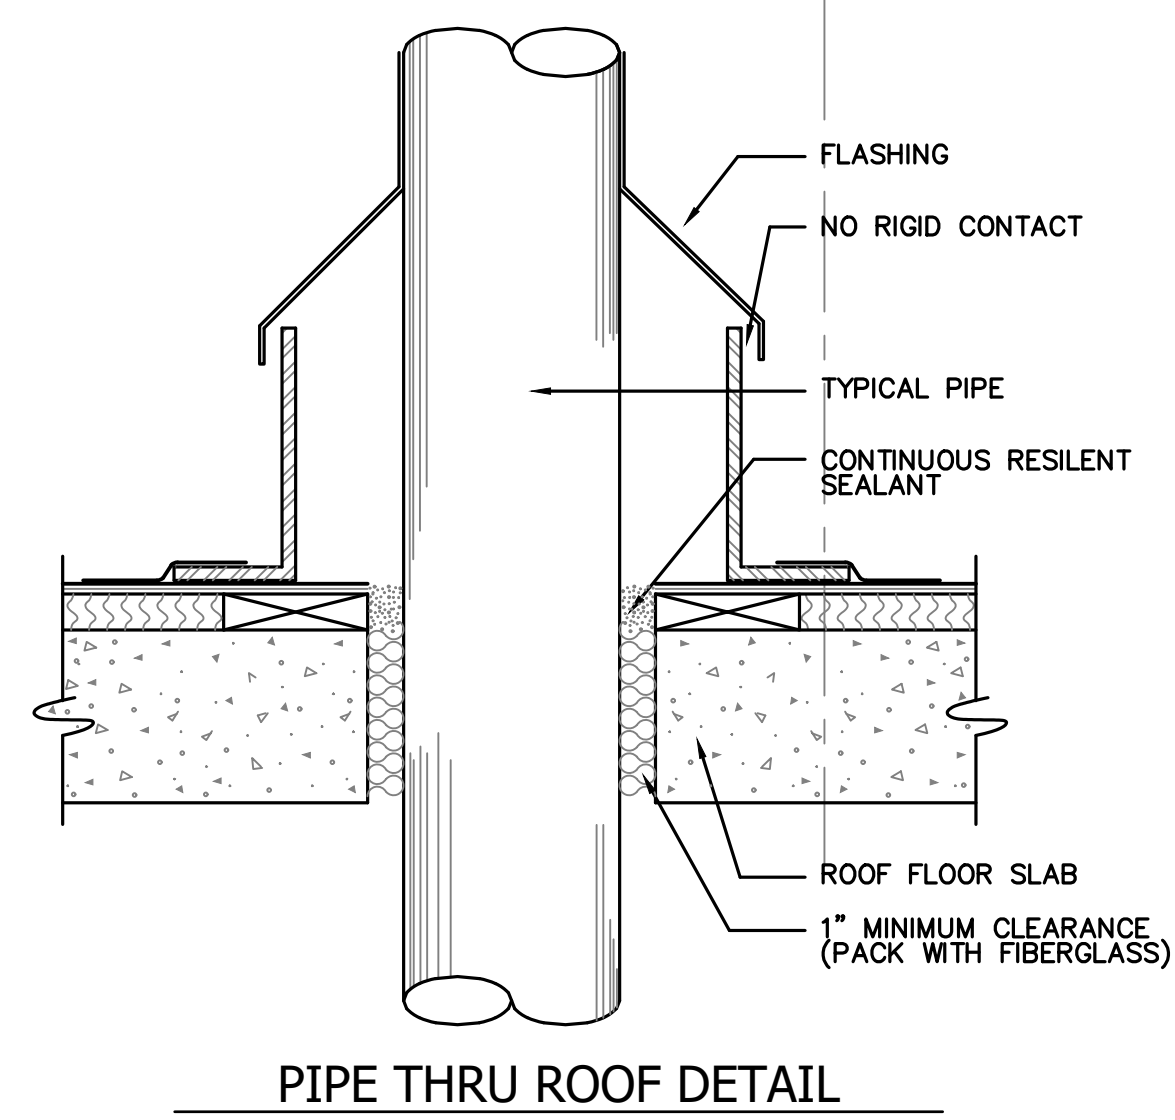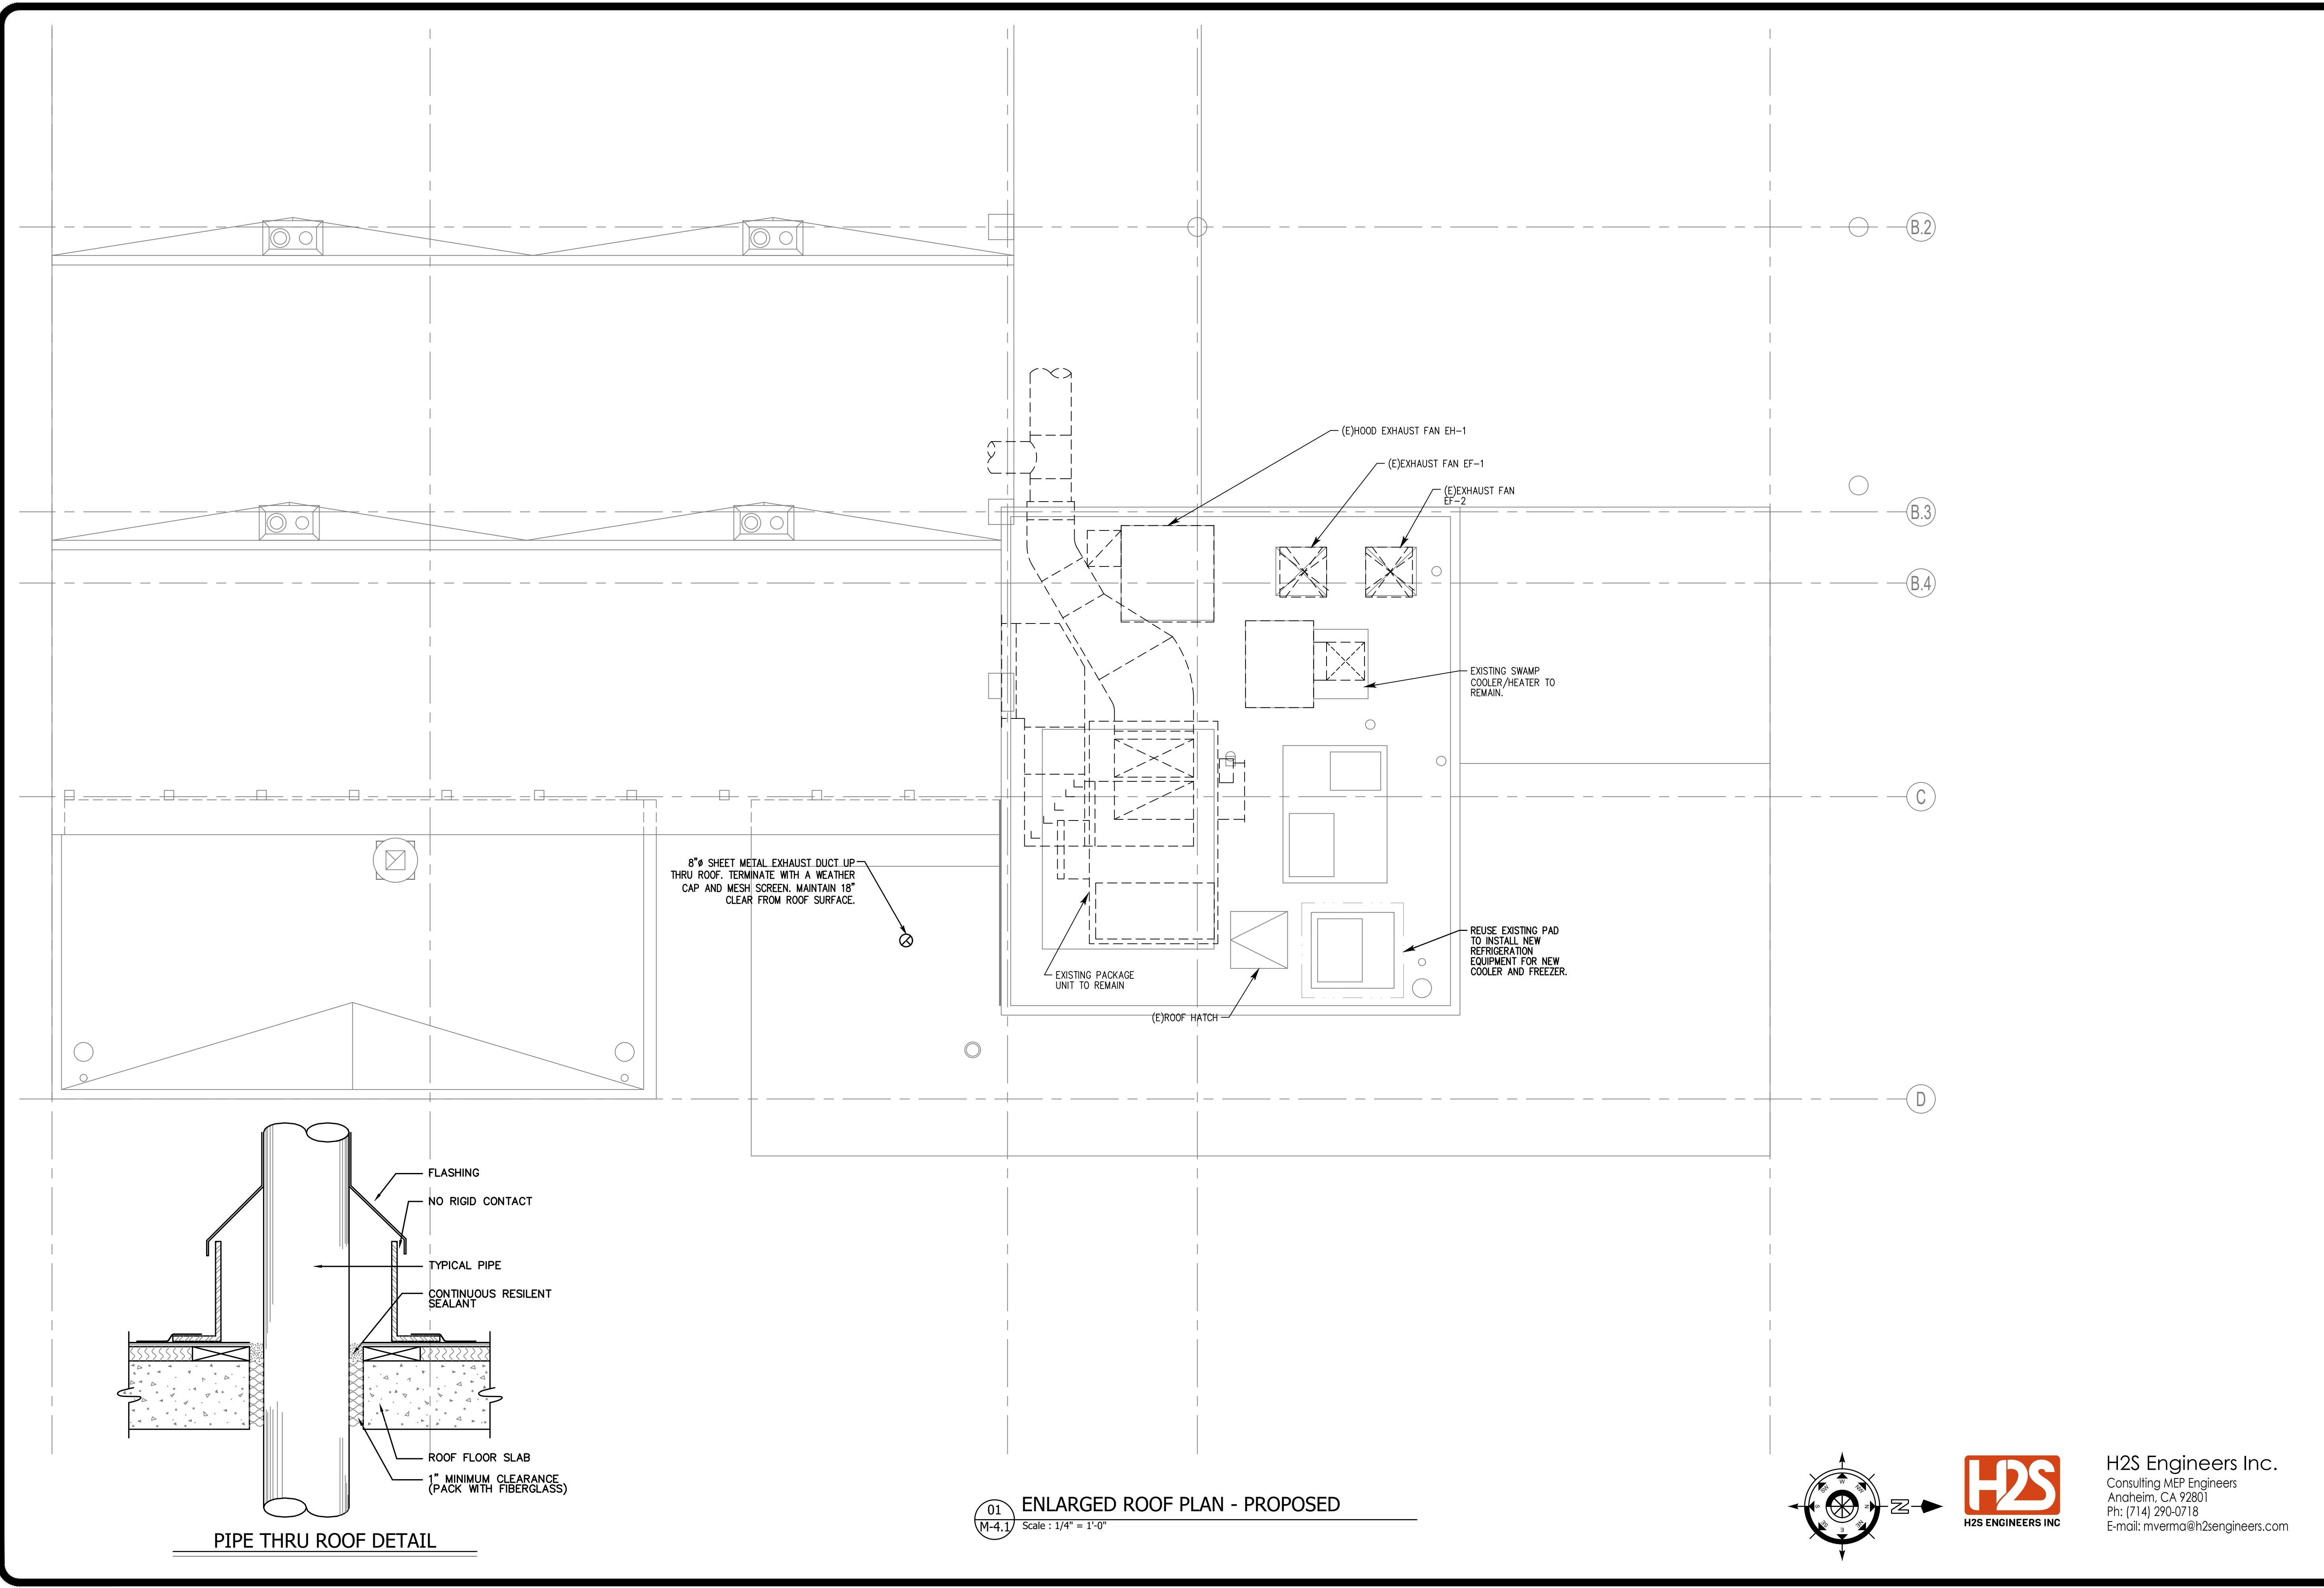

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ENLARGED ROOF PLAN - PROPOSED
 TOWN OF YUCCA VALLEY
 Senior Center - Kitchen Upgrades

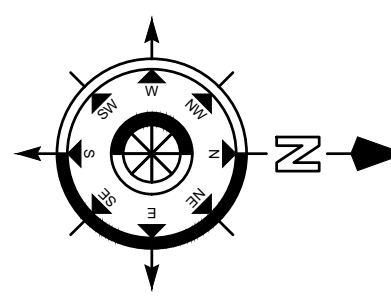M-4.1

PLUMBING FIXTURE SCHEDULE						
MARK	FIXTURE	PIPE SIZE				DESCRIPTION / REMARKS
		S/W	V	CW	HW	
ES-1	FLOOR SINK	2"	1-1/2"	1/2"	-	ZURN #1900-25 SANI-FLOOR RECEPTOR, 12x12x6 ACID RESISTING PORCELAIN ENAMEL ARCHITECTURAL AND TOP, CAST IRON BODY, SQUARE SLOTTED LIGHT DUTY GRATE. COORDINATE GRATE CONFIGURATION WITH KITCHEN ROUGH IN PLANS.
WCO ECO GCO CO	CLEAN-OUTS	-	-	-	-	WALL CLEAN OUT: "ZURN" MODEL: Z1447 SQUARE, Z1446 ROUND. FLOOR CLEANOUT: "ZURN" MODEL: Z1400-BZ MUST BE FLUSHED TO SURFACE. CLEAN OUT TO GRADE: "ZURN" MODEL: Z1400 MUST BE FLUSHED TO SURFACE. T CLEAN OUT: "ZURN" MODEL: Z1445.

GAS FIRED WATER HEATER									
UNIT NO.	MANUFACTURER & MODEL NO.	SERVICE	STORAGE CAPACITY	INPUT BTU/HR	REC @ DEG' Δ T (GPH)	INLET	OUTLET TEMP °F	OPER. WT. LBS.	REMARKS
QWH-1	A.O. SMITH BTH-199	DOMESTIC HOT WATER	100 GAL	199,900	384 @ 60'	60	120	1450	AMTROL ST-12 EXPANSION TANK; PROVIDE WITH CONDENSATE NEUTRALIZER KIT. PROVIDE CONCENTRIC VENT KIT.

REGULATORY NOTES
FIRE RESISTIVE BUILDING MATERIALS
A. ALL INSULATING MATERIAL SHALL BE INSTALLED IN COMPLIANCE WITH THE FLAME SPREAD RATING AND SMOKE DENSITY REQUIREMENTS PER CBC REQUIREMENTS.
B. INSULATION MATERIALS, WHERE CONCEALED AS INSTALLED IN BUILDINGS OF ANY TYPE OF CONSTRUCTION, SHALL HAVE A FLAME-SPREAD RATING OF NOT MORE THAN 25 AND A SMOKE-DEVELOPED INDEX OF NOT MORE THAN 450 IN ACCORDANCE WITH 2013 CBC.
C. INSULATION, INSULATION JACKET, ADHESIVES, TAPES, ETC. SHALL BE APPLIED PER MANUFACTURERS WRITTEN INSTALLATION INSTRUCTIONS.

A.D.A. COMPLIANCE NOTES
1. INSULATE EXPOSED HOT WATER AND WASTE PIPING WITH NEATLY PRE-FORMED INSULATION COVERS BY McGUIRE "PROWRAP", OR EQUAL.
2. FIXTURE MOUNTING HEIGHTS FOR THE PHYSICALLY DISABLED SHALL CONFORM TO THE AMERICANS WITH DISABILITIES ACT AND OTHER AUTHORITIES HAVING JURISDICTION.

PIPE MATERIAL SCHEDULE
<u>DOMESTIC WATER PIPING</u>
A: COPPER TUBING: ASTM B88, TYPE L, HARD DRAWN.
1. FITTINGS: ASME B16.18, CAST COPPER ALLOY OR ASTM B16.22, WROUGHT COPPER AND BRONZE.
2. MECHANICAL PRESS SEALED FITTINGS: NSF/ANSI 61, DOUBLE PRESSED TYPE AND UTILIZING EPDM SEALING ELEMENT.
3. JOINTS: ASTM B32, ALLOY GRADE Sb5 TIN-ANTIMONY, OR ALLOY GRADE Sn95 TIN-SILVER, LEAD FREE SOLDER AWS A5.8 CLASSIFICATION BCuP-3 OR BCuP-4 SILVER BRAZED.
<u>SANITARY SEWER PIPING</u>
A: CAST IRON PIPE: CISPI 301, HUBLESS, SERVICE EIGHT
1. FITTINGS: CAST IRON, CISPI 301
2. JOINTS: CISPI 310, NEOPRENE GASKETS AND STAINLESS STEEL CLAMP AND SHIELD ASSEMBLIES.
<u>SEWER AND VENT PIPE (PLASTIC)</u>
1. BELOW AND ABOVE GRADE INSIDE BUILDING SCHEDULE 40 PVC ASTM D2665. UNDERGROUND INSTALLATION MUST COMPLY WITH ASTM-D2321.

PLUMBING LEGEND
1. NOTE: FOR THE PURPOSE OF CLEARNESS AND LEGIBILITY, THE DRAWINGS ARE ESSENTIALLY DIAGRAMMATIC AND ALTHOUGH SIZES AND LOCATIONS OF EQUIPMENT ARE DRAWN TO SCALE WHEREVER POSSIBLE, THE CONTRACTOR SHALL MAKE USE OF ALL DATA IN ALL OF THE CONTRACT DOCUMENTS AND VERIFY THIS INFORMATION PRIOR TO ORDERING, FABRICATING OR INSTALLING ANY MATERIALS.
2. CONTRACTOR SHALL COORDINATE ALL WORK SHOWN ON THESE DRAWINGS AND SPECIFICATIONS WITH ALL DISCIPLINES AND TRADES PRIOR TO SUBMITTAL OF BID AND INSTALLATION OF SYSTEM.
3. THE PLUMBING CONTRACTOR SHALL GUARANTEE ALL MATERIALS & LABOR (INCLUDING THE COMPLETE PLUMBING SYSTEM) FOR A PERIOD OF ONE YEAR FROM WRITTEN ACCEPTANCE BY THE OWNER. ANY DEFECTS IN MATERIALS & OR LABOR FOUND WITHIN THE GUARANTEE PERIOD SHALL BE REMEDIATED OR REPAIRED BY THIS CONTRACTOR IN A TIMELY FASHION, AT NO COST TO THE OWNER.
4. ALL PLUMBING FIXTURE LOCATIONS (WATER CLOSETS, LAVATORIES ETC.) ARE DIAGRAMMATIC & CONTRACTOR SHALL REFER TO ARCHITECTURAL DRAWINGS FOR ADA COMPLIANT FIXTURES, EXACT LOCATIONS, MOUNTING HEIGHTS & COLOR.
5. ANY DEVIATIONS FROM THE DRAWINGS OR SPECIFICATIONS SHALL BE BROUGHT TO THE ATTENTION OF THE ARCHITECT AND ENGINEER PRIOR TO INSTALLATION.
6. CONTRACTOR SHALL VISIT SITE PRIOR TO SUBMITTAL OF BID AND FAMILIARIZE HIMSELF WITH EXISTING CONDITIONS. SUBMITTAL OF BID WILL VERIFY THAT THE CONTRACTOR HAS VISITED THE SITE.
7. PIPING SHALL BE INSTALLED PARALLEL TO BUILDING LINES AND SUPPORTED AND ANCHORED AS REQUIRED TO FACILITATE EXPANSION AND CONTRACTION. THE INSTALLATION SHALL MEET ALL CONSTRUCTION CONDITIONS AND ALLOW FOR THE INSTALLATION OF OTHER TRADES.
8. TRAP PRIMERS FOR FLOOR DRAINS AND FLOOR SINKS AND WATER HAMMER ARRESTORS TO BE INSTALLED AS PER THE LISTED PLUMBING CODE AND THE LATEST EDITION OF THE AMERICAN SOCIETY OF SANITARY ENGINEERING (ASSE 1010) SIZING AND INSTALLATION REQUIREMENTS.
9. ALL VALVES, TRAP PRIMERS, WATER HAMMER ARRESTORS OR OTHER EQUIPMENT SHOWN IN WALLS OR ABOVE NON-ACCESSIBLE CEILINGS SHALL BE INSTALLED BEHIND AN ACCESS PANEL.
10. ALL SERVICE WATER HEATING EQUIPMENT TO BE IN COMPLIANCE WITH THE STATE ENERGY CODE AND 2013 IECC REQUIREMENTS AND LABELED AS SUCH.
11. ALL ITEMS PROJECTING THROUGH THE ROOF SHALL BE FLASHED THROUGH CURBS OR PIPE SEALS A MINIMUM OF 12" ABOVE THE ROOF. THE PIPE CURBS AND SEALS SHALL BE INSTALLED BY THE ROOFING CONTRACTOR. ENSURE THAT AMPLE BOOT OPENINGS ARE PROVIDED TO ACCOMMODATE ANY ELECTRICAL CONDUIT PENETRATIONS REQUIRED FOR POWER.
12. CONTRACTOR TO REFER TO PLUMBING FIXTURE SCHEDULE FOR INDIVIDUAL WASTE, VENT & WATER CONNECTION SIZES AT EACH PLUMBING FIXTURE.
13. ALL CLEANOUTS SHALL BE INSTALLED WHERE READILY ACCESSIBLE AND LOCATED AS PER CODE REQUIREMENTS. THE CONTRACTOR SHALL COORDINATE ALL CLEAN OUT LOCATIONS WITH EQUIPMENT, MILLWORK, ETC., PRIOR TO INSTALLATION.
14. ALL PLUMBING FIXTURE VENTS TO TERMINATE A MINIMUM OF 12 INCHES FROM ANY VERTICAL SURFACE AND 10'-0" FROM OR 3'-0" ABOVE ANY MECHANICAL EQUIPMENT OUTSIDE AIR INTAKE.
15. ALL VALVES, UNIONS, ETC. TO BE SAME SIZE AS CONNECTED SUPPLY LINE UNLESS OTHERWISE NOTED ON DRAWINGS.
16. UNIONS SHALL BE PROVIDED AND INSTALLED AFTER EACH SCREW-TYPE VALVE AND PRIOR TO EQUIPMENT CONNECTIONS.
17. ALL UNDERGROUND METALLIC PIPE AND FITTINGS SHALL BE PROTECTED IN ACCORDANCE WITH THE SOILS ENGINEER'S RECOMMENDATIONS.
18. NO PIPING SHALL BE DIRECTLY EMBEDDED IN CONCRETE, MASONRY WALLS, OR CONCRETE FOOTINGS.
19. THE PLUMBING CONTRACTOR SHALL COORDINATE ALL REQUIREMENTS FOR ALL POINTS OF CONNECTION WITH THE GENERAL CONTRACTOR AND OTHER TRADES PRIOR TO START OF WORK.
20. VERIFY EXACT LOCATIONS, DEPTH AND SIZE OF ALL PIPING TO WHICH CONNECTIONS ARE REQUIRED. COORDINATE ALL CONNECTIONS WITH SITE CONDITIONS AND SITE UTILITY CONTRACTOR/ REPRESENTATIVE.
21. ALL HORIZONTAL PIPING LINES EXTENDED AND CONNECTED TO EQUIPMENT SHALL BE RUN AT THE HIGHEST POSSIBLE ELEVATIONS AND NOT LESS THAN 6" ABOVE THE FLOOR TO PROVIDE CLEARANCE FOR CLEANING.
22. ALL CUTTING OF EXISTING PAVING, WALKS AND/OR FLOORS SHALL UTILIZE MACHINE SAW CUTTING EQUIPMENT. HOLES FOR PIPES IN CONCRETE WALLS OR FLOORS SHALL UTILIZE CORE DRILLING EQUIPMENT. COORDINATE WITH ARCHITECTURAL DETAILS FOR FLOOR CUTTING AND PATCHING.
23. THE PLUMBING CONTRACTOR IS TO PROVIDE ALL ADDITIONAL STEEL HANGER MATERIALS, RODS AND CLAMPS AS REQUIRED FOR COORDINATION WITH WORK OF OTHER TRADES.
24. PIPING LAYOUT IS SCHEMATIC ONLY, EXACT ROUTING AND INSTALLATION OF PIPES TO BE COORDINATED WITH THE BUILDING STRUCTURE AND THE WORK OF OTHER CONTRACTORS.
25. NO LIQUID TRANSMISSION PLUMBING PIPING SHALL BE INSTALLED ABOVE ELECTRICAL SWITCH GEAR, EQUIPMENT, OR PANELS. MAKE ADJUSTMENTS NECESSARY TO REROUTE PIPING FOR ACTUAL INSTALLATION OF ELECTRIC EQUIPMENT.
26. WHENEVER FOUNDATION WALLS, EXTERIOR WALLS, ROOFS, ETC. ARE PENETRATED FOR THE INSTALLATION OF PLUMBING SYSTEMS, THEY SHALL BE PATCHED TO MATCH EXISTING CONSTRUCTION AND SEALED WEATHER TIGHT.
27. PLUMBING CONTRACTOR SHALL BE ON SITE AND PRESENT AT THE DATE OF TURNOVER.
28. ALL EXTERIOR EXPOSED WATER PIPING SHALL BE INSULATED AND PVC JACKETED. SEAL JACKET PER MANUFACTURER'S REQUIREMENTS.
29. LABEL ALL SHUT-OFF VALVES ABOVE THE CEILING AND IN THE WALL WITH ACCESS DOORS.
30. GENERAL CONTRACTOR TO VERIFY PRESSURE ON SITE EARLY TO VERIFY IF BOOSTER PUMPS ARE REQUIRED.

SYMBOL	ABBREVIATION	DESCRIPTION
	W	SANITARY WASTE
	GW	GREASE WASTE
	V	SANITARY VENT
	CW	DOMESTIC COLD WATER
	HW	DOMESTIC HOT WATER
	HWR	DOMESTIC HOT WATER RETURN
	G	LOW PRESSURE GAS
	MPG	MEDIUM PRESSURE GAS
	HPG	HIGH PRESSURE GAS
	CD	CONDENSATE DRAIN
	SD	STORM DRAIN
	OD	OVERFLOW STORM DRAIN
	VTR	VENT THRU ROOF
	SOV	VERTICAL SHUT-OFF VALVE
	SOV	SHUT-OFF VALVE
	PRV	PRESSURE REDUCING VALVE
		PRESSURE GAUGE
		THERMOMETER
	BV	BALL VALVE
	CV	CHECK VALVE
	U	UNION
	WHA	WATER HAMMER ARRESTOR WITH ACCESS PANEL
	TP	TRAP PRIMER WITH ACCESS PANEL
		PIPE UP
		PIPE DOWN
	FCO OR GCO	FLOOR OR GRADE CLEAN OUT
	SCO	2-WAY SERVICE CLEAN OUT
	WCO	WALL CLEAN OUT
	HB	HOSE BIBB
		CAPPED PIPE
	POC	POINT OF CONNECTION
	POR	POINT OF REMOVAL
		FLOOR DRAIN
	AP	ACCESS PANEL
	FFE	FINISHED FLOOR ELEVATION
	IE	INVERT ELEVATION
	FU	FIXTURE UNIT

SHEET INDEX	
SHEET NO.	DESCRIPTION
P-0.1	GENERAL NOTES, LEGEND AND SCHEDULES
P-0.2	PLUMBING DETAILS
P-1.1	PLUMBING FLOOR PLAN OVERALL
P-2.1	ENLARGED PLUMBING FLOOR PLAN - DEMO
P-3.1	ENLARGED PLUMBING FLOOR PLAN - PROPOSED



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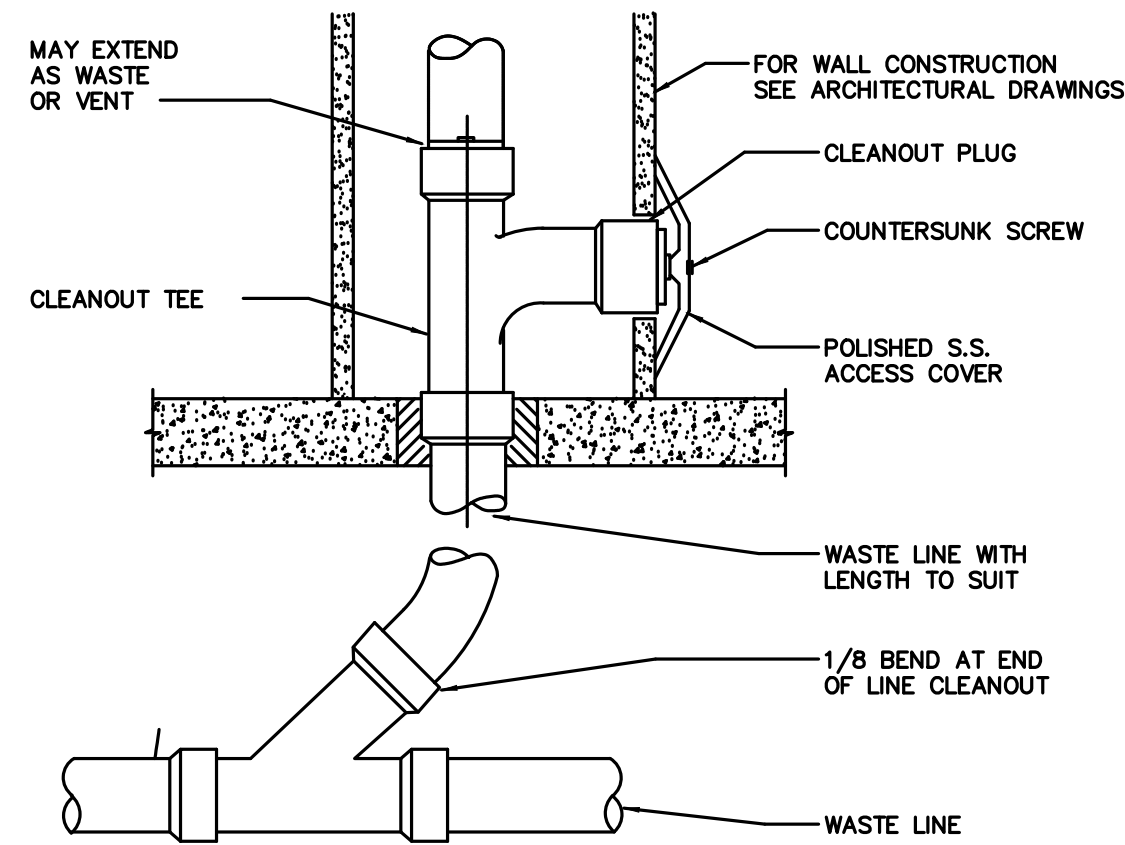
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SCALE:	AS NOTED		

GENERAL NOTES, LEGEND & SCHEDULES

TOWN OF YUCCA VALLEY


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P-0.1




WALL CLEAN OUT
SCALE: NONE

1

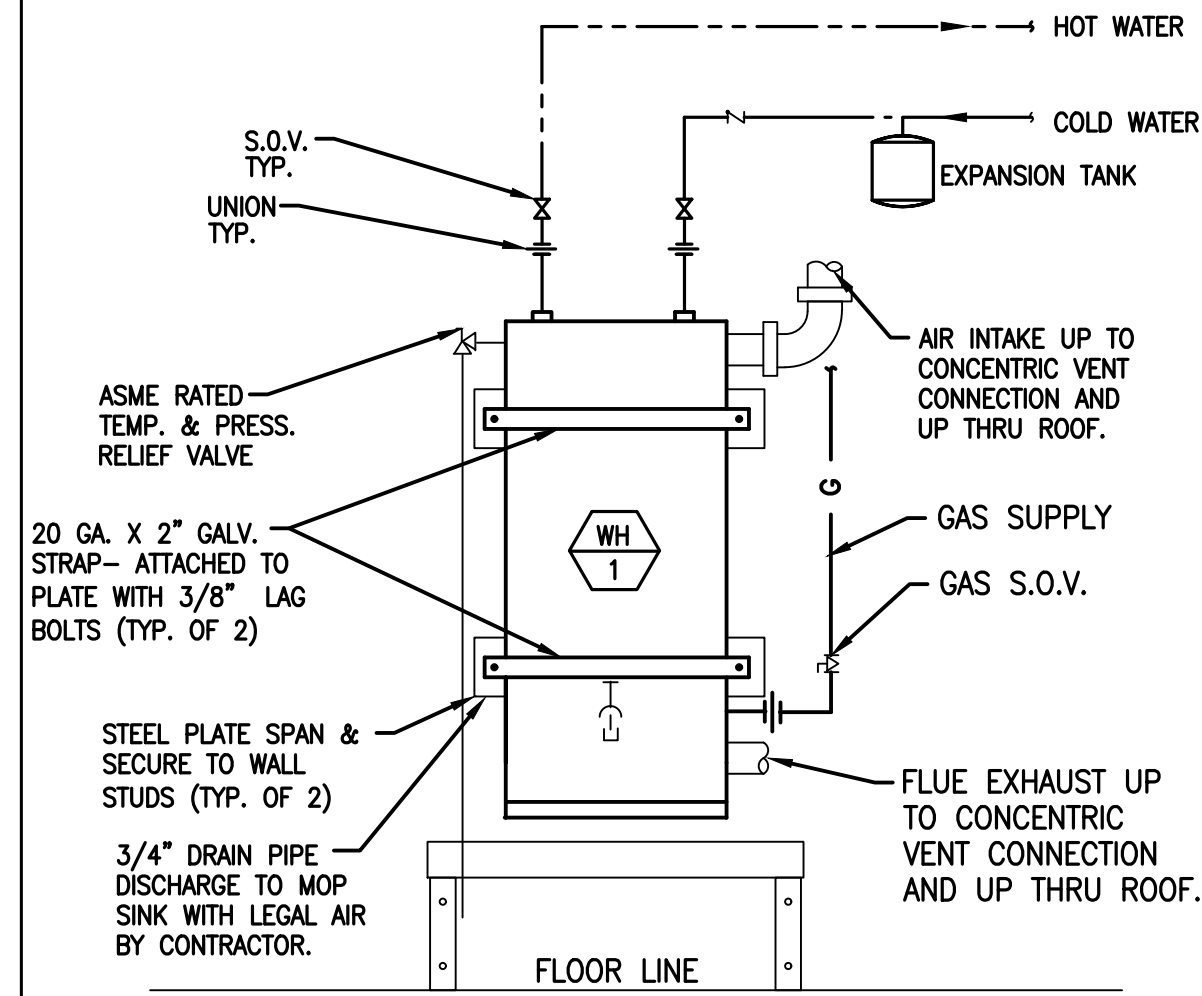

GAS FIRED WATER HEATER
SCALE: NONE

2

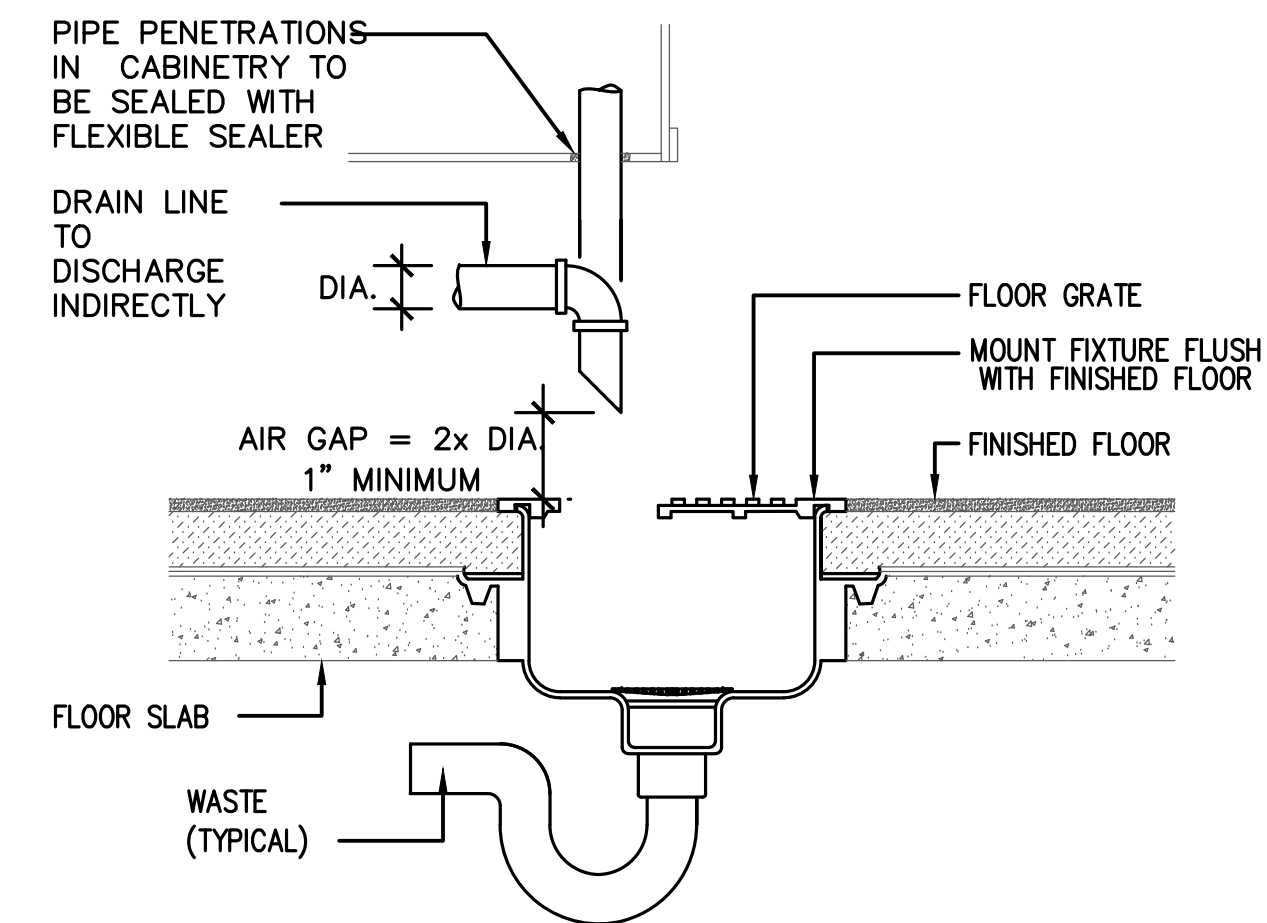


INDIRECT WASTE TO FLOOR SINK
SCALE: NONE

3

NOTE:

- TRAP PRIMER VALVE SHALL BE MOUNTED ONE FOOT ABOVE THE FINISHED FLOOR.
- PROVIDE MOUNTING BRACKETS AS REQUIRED.

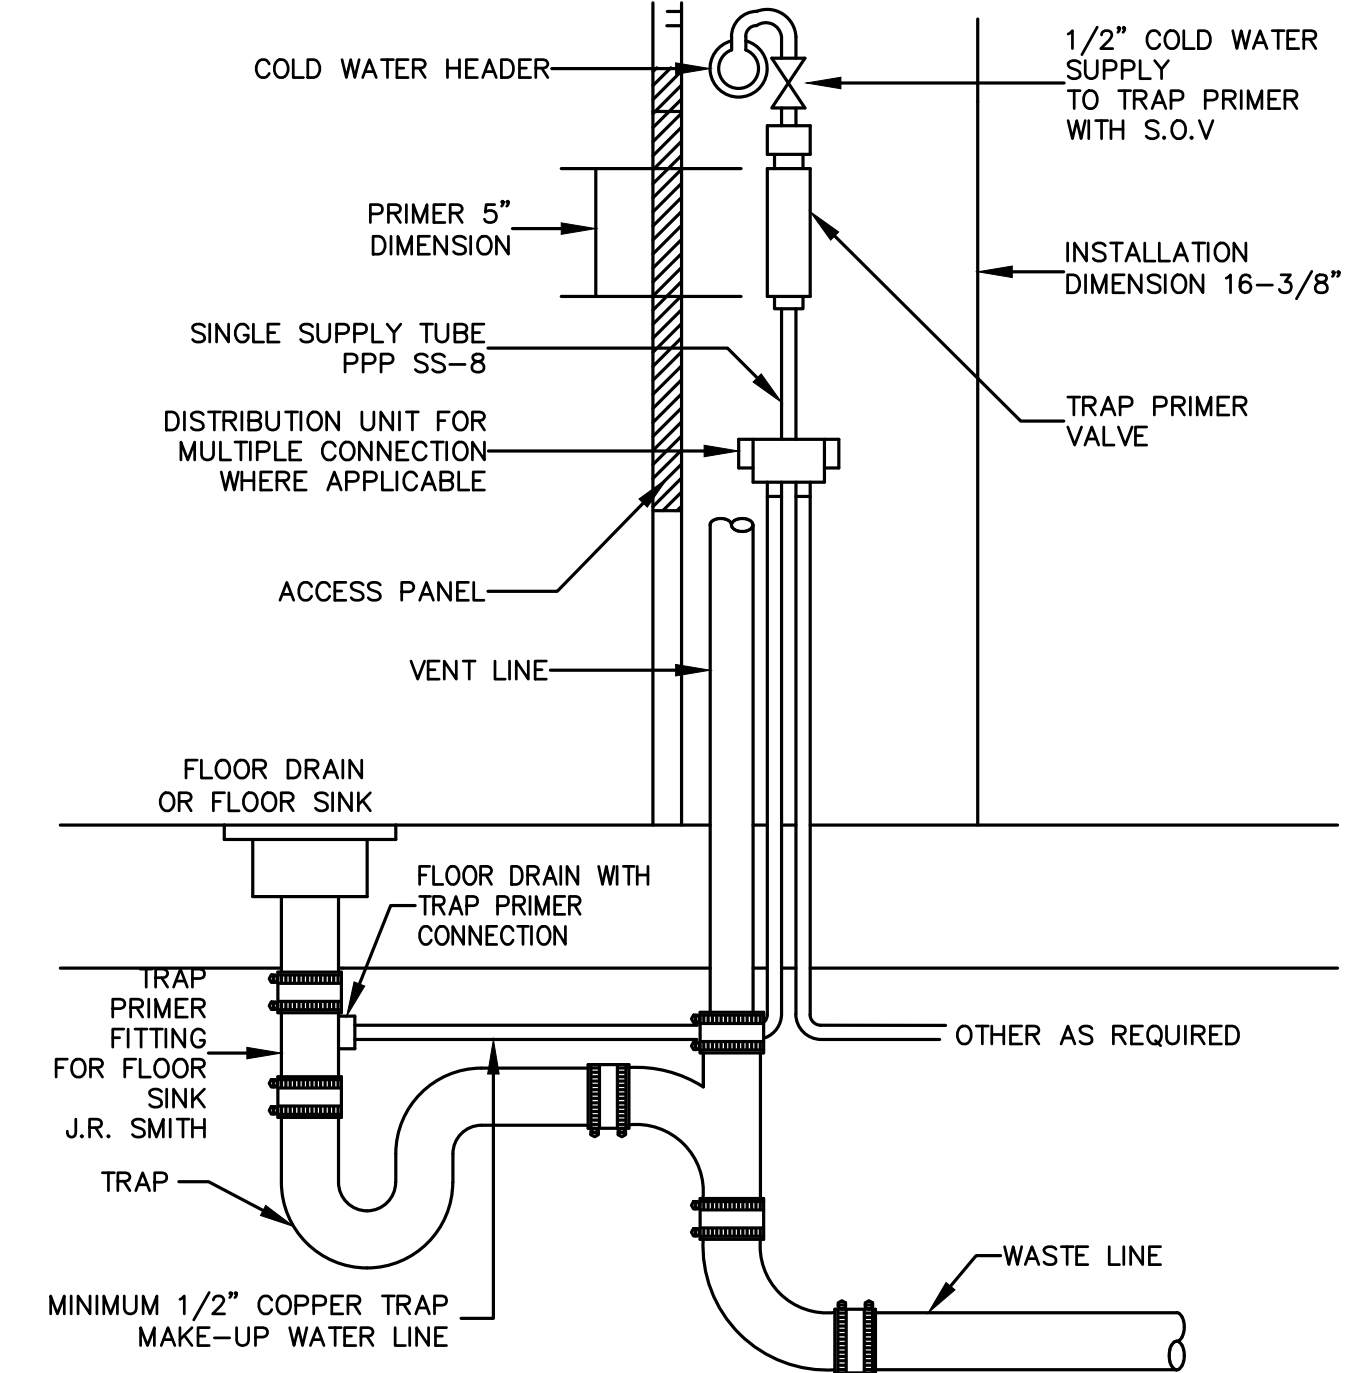


TRAP PRIMER DETAIL
SCALE: NONE

4



01 PLUMBING FLOOR PLAN - OVERALL
 P-1.1 Scale: 1/8" = 1'-0"

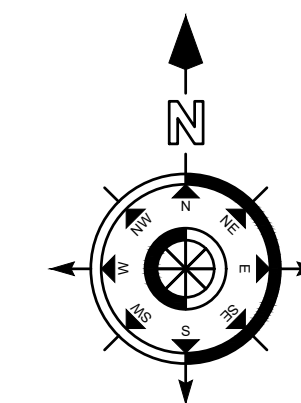

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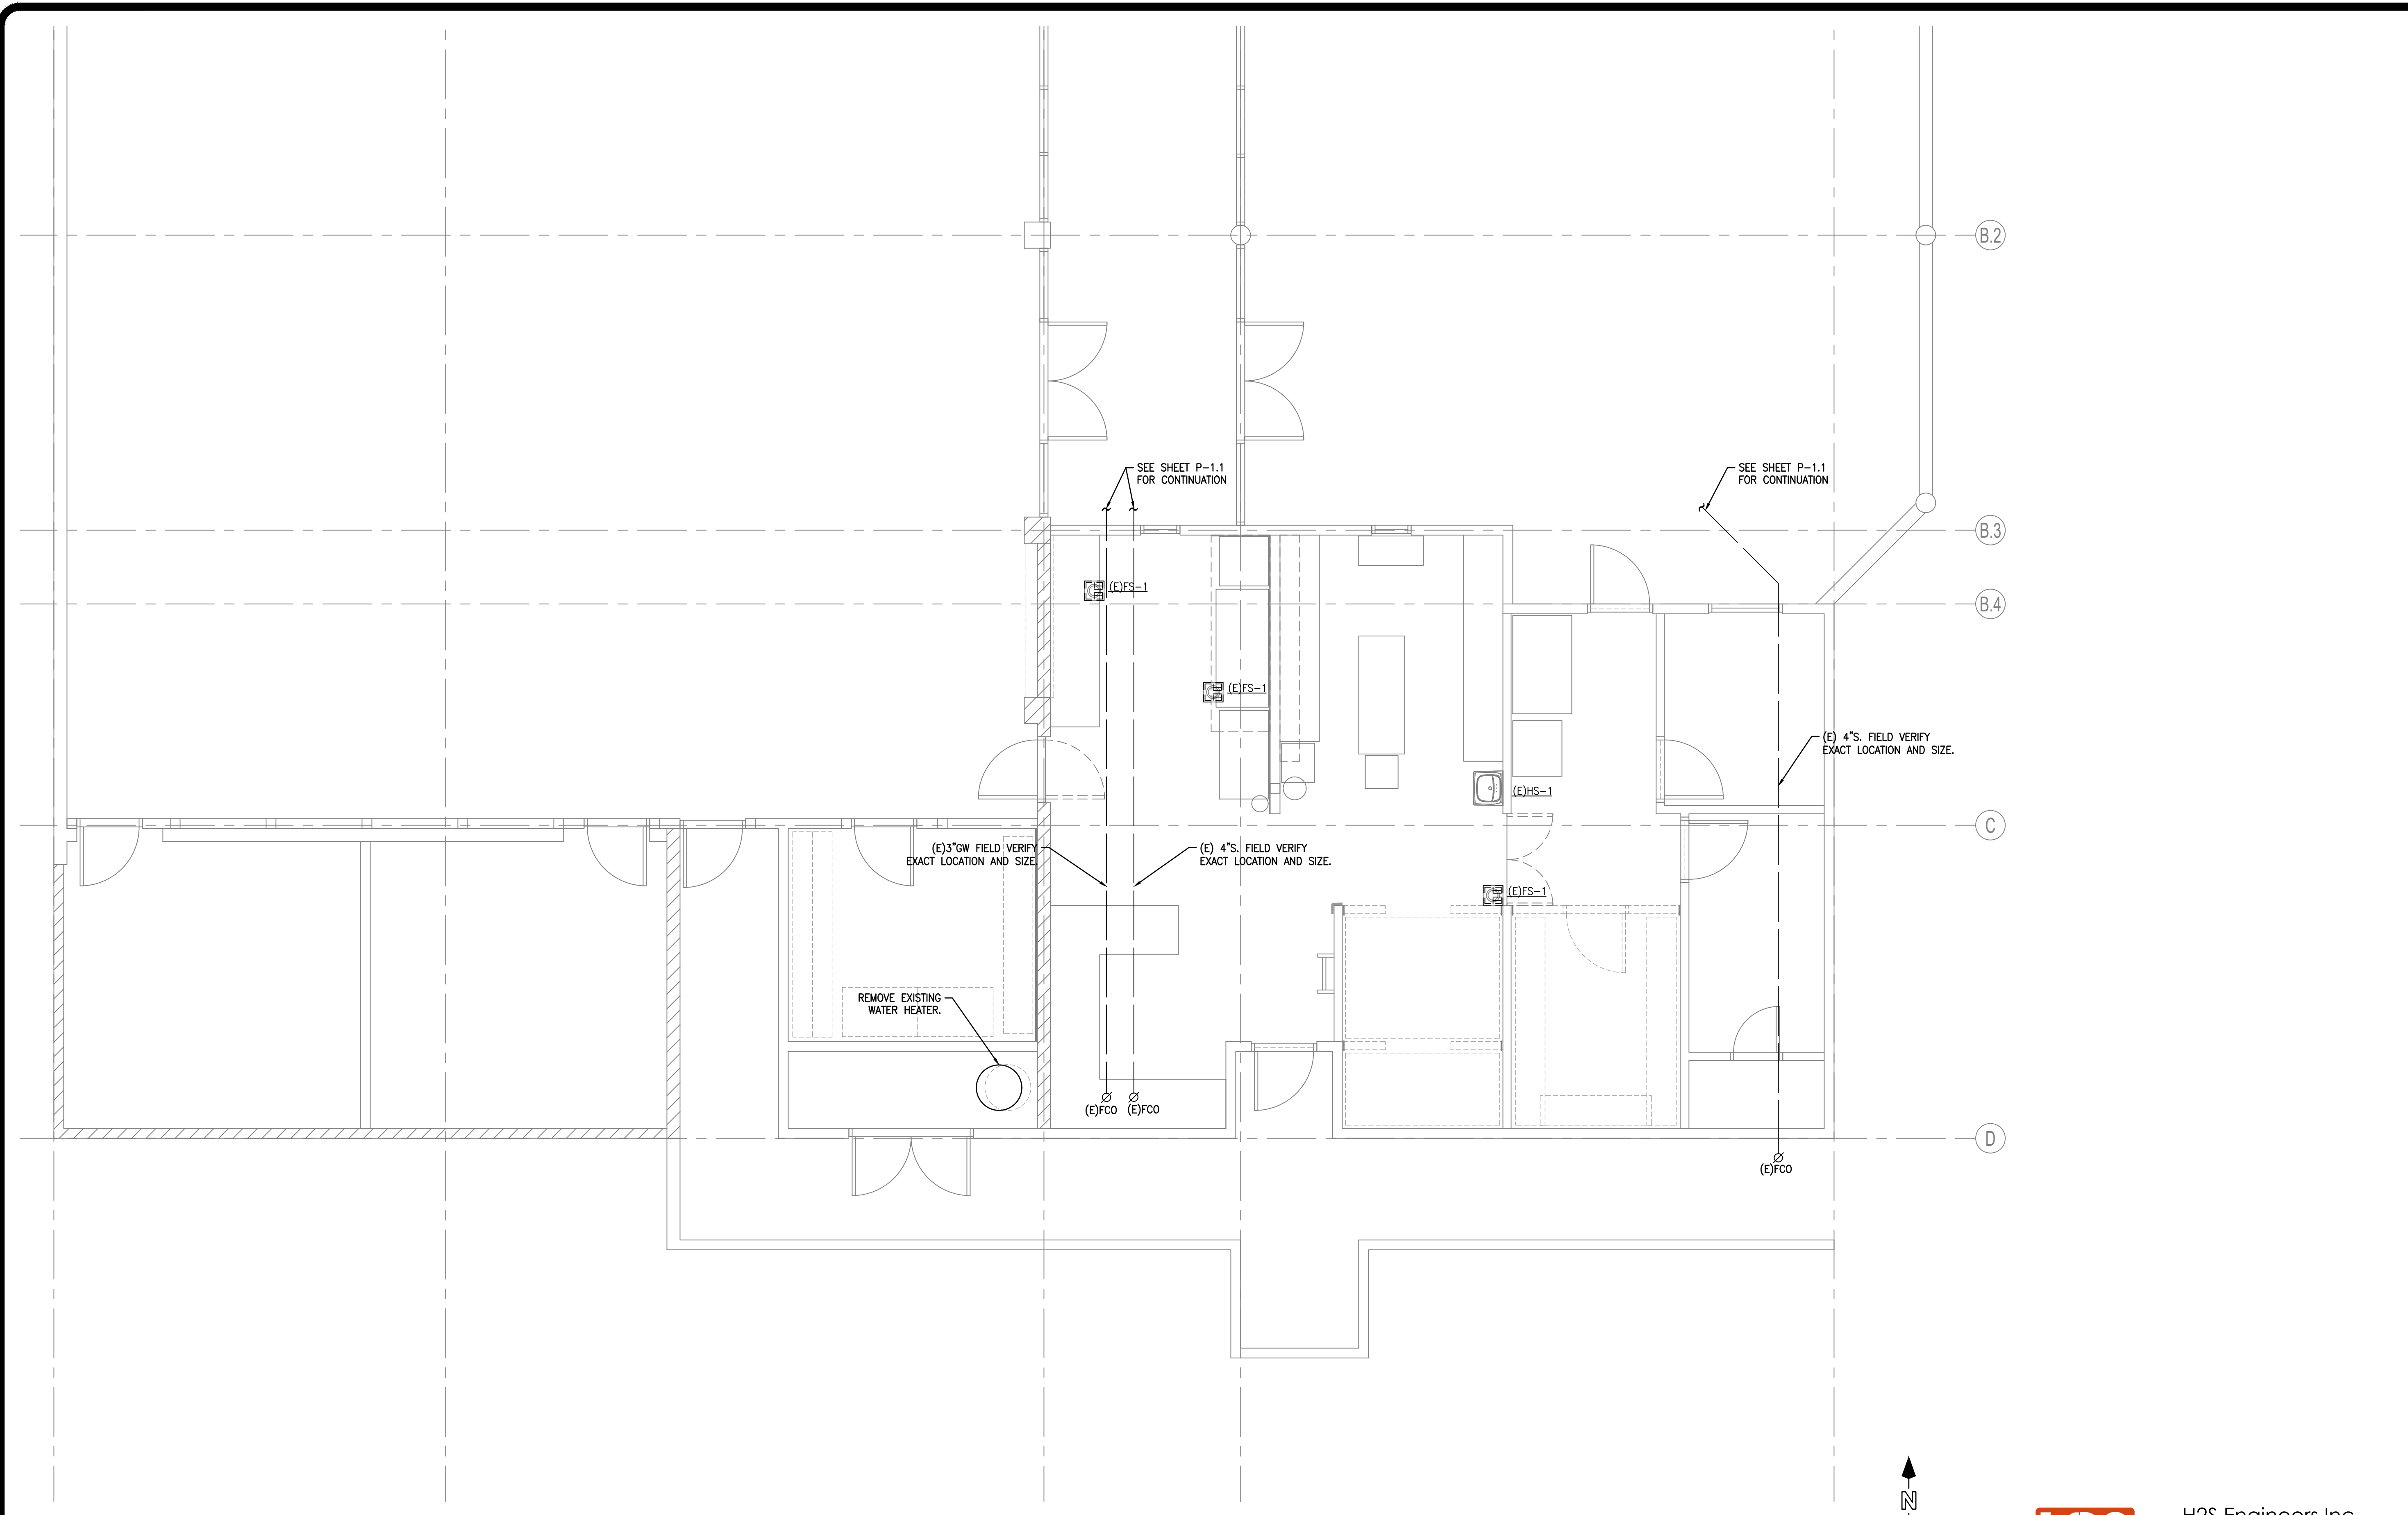
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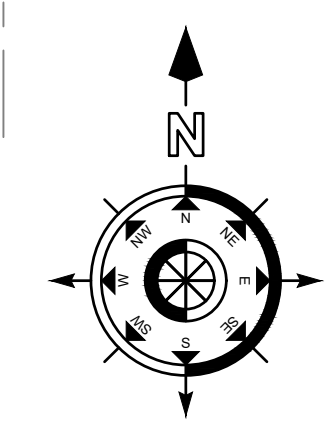
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DRAWN BY:	H.SHEETH	CHECKED BY:	H.SHEETH
SCALE:	AS NOTED		

PLUMBING FLOOR PLAN - OVERALL
TOWN OF YUCCA VALLEY
 Senior Center - Kitchen Upgrades

P-1.1



01 ENLARGED PLUMBING FLOOR PLAN - DEMO
 P-2.1 Scale: 1/4" = 1'-0"



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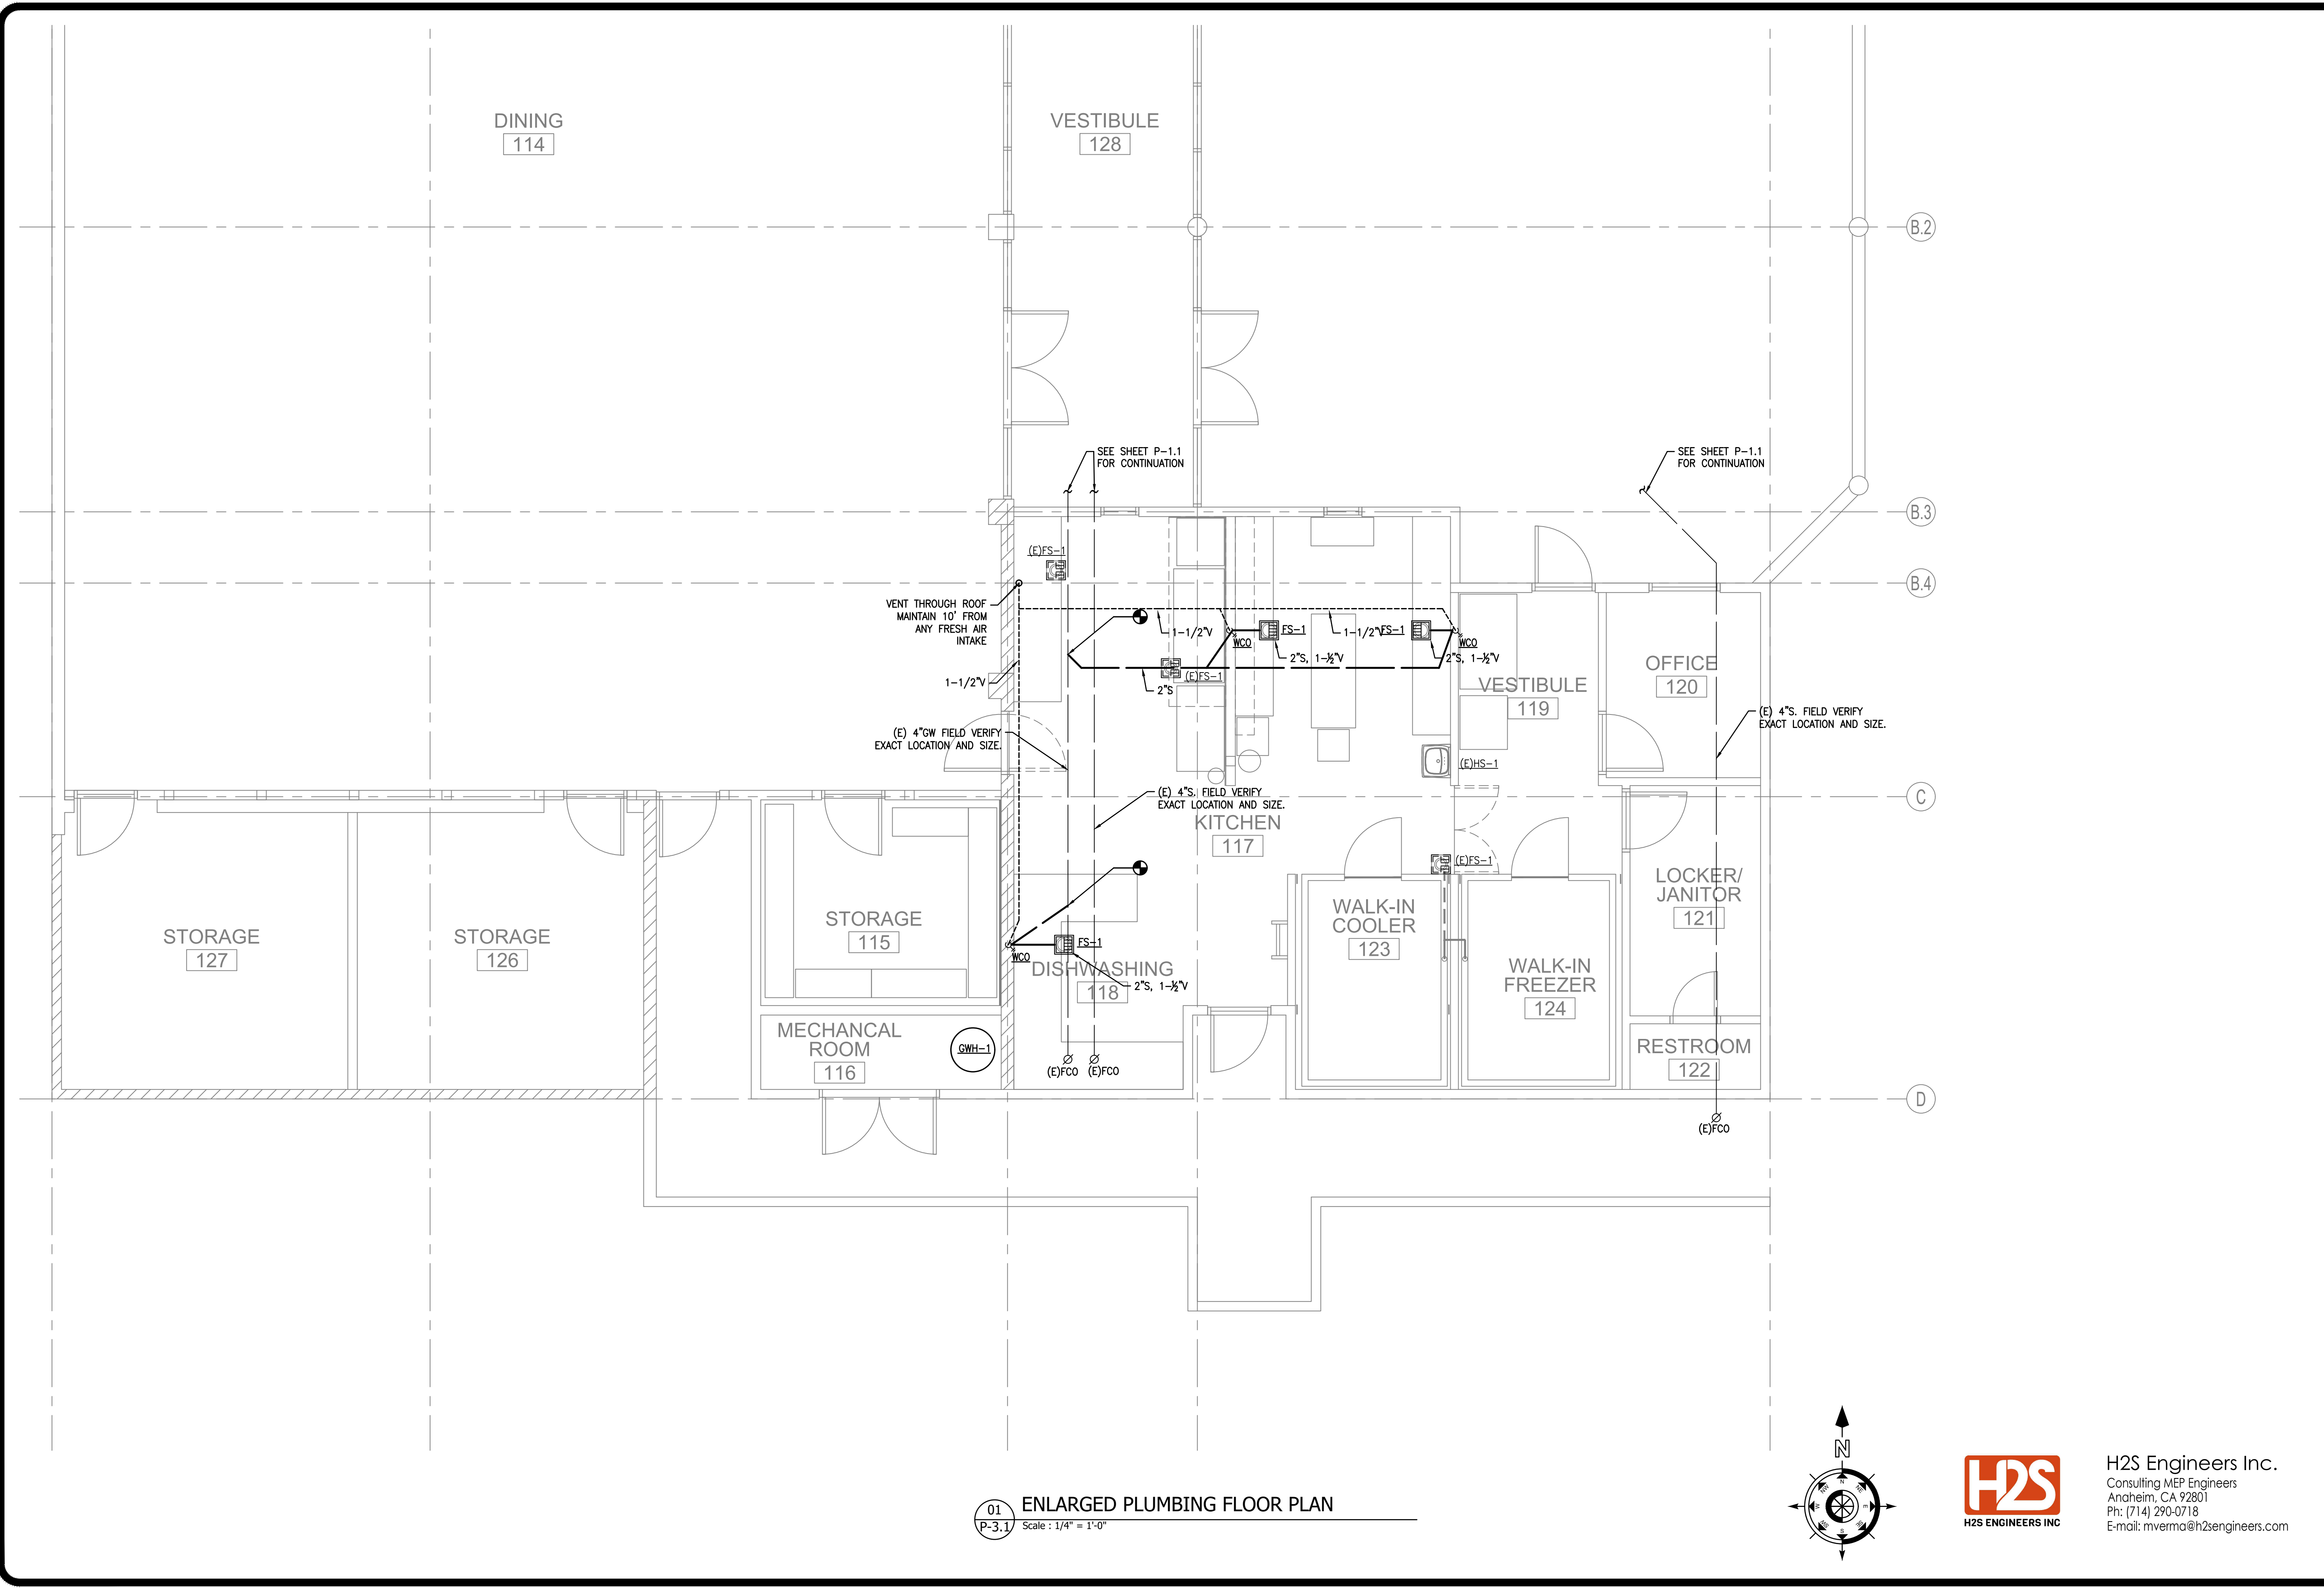
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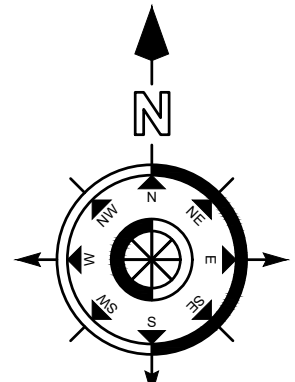
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ENLARGED PLUMBING FLOOR PLAN - DEMO
 TOWN OF YUCCA VALLEY
 Senior Center - Kitchen Upgrades



01 ENLARGED PLUMBING FLOOR PLAN
 P-3.1 Scale: 1/4" = 1'-0"



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ENLARGED PLUMBING FLOOR PLAN
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