
### **PROJECT LOCATION**

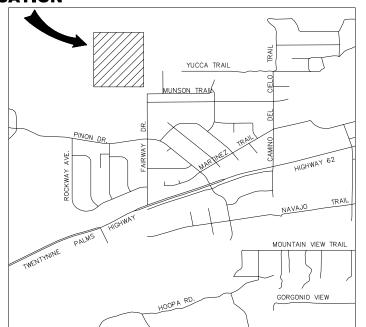

VICINITY MAP

NOT TO SCALE

### LEGEND AND ABBREVIATIONS

BLOW OFF BUILDING SETBACK LINE CURB FACE EDGE OF PAVEMENT HOUSE FINISH FLOOR FINISHED GRADE FIRE HYDRANT FINISHED SURFACE GRADE BREAK GUARD POST INVERT ELEVATION NATURAL GROUND

PROPERTY LINE POWER POLE RADIUS ROUGH GRADED PROPOSED RIGHT OF WAY SEWER MANHOLE TOP OF CURB

TOP OF FOOTING

WATER METER

UNDERGROUND SERVICE ALERI

OF HIGHWAY 62, 45' EAST OF THE CENTERLINE OF KICKAPOO TRAIL, 3'

NORTHEAST OF UTILITY POLE AND 2' SOUTHWEST OF WITNESS POST.

ELEVATION: 3329.55 (NAVD 88)


TOP OF SCREEN FENCE TOP OF RETAINING WALL TYPICAL VALILT

-(ELEV)- - EXISTING CONTOUR EXISTING SEWER FXISTING WATER EXISTING JOSHUA TREE - PROPOSED CONTOUR BOUNDARY STAKE PROPOSED WALL 2.00% GRADIENT S SEWER CLEANOUT REMOVE EXISTING PAVEMENT PROPOSED PAVEMENT PROPOSED CONCRETE

### EARTHWORK QUANTITIES ESTIMATE

#### PRIVATE ENGINEER'S NOTE TO CONTRACTOR

THE EXISTENCE AND LOCATION OF ANY UNDERGROUND UTILITY PIPES, CONDUITS OR STRUCTURES SHOWN ON THESE PLANS ARE OBTAINED BY A SEARCH OF THE AVAILABLE RECORDS. TO THE BEST OF OUR KNOWLEDGE THERE ARE NO EXISTING UTILITIES EXCEPT AS SHOWN ON THESE PLANS. THE CONTRACTOR IS REQUIRED TO TAKE DUE PRECAUTIONARY MEASURES TO PROTECT THE UTILITY LINES SHOWN ON THESE DRAWINGS. THE CONTRACTOR FURTHER ASSUMES ALL LIABILITY AND RESPONSIBILITY FOR THE UTILITY PIPES, CONDUITS OR STRUCTURES SHOWN OR NOT SHOWN ON THESE DRAWINGS.

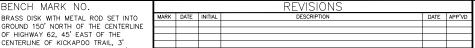

PLANS PREPARED BY




PROJECT LOCATION MAP

## SCALE: I' = 50" APPROVED BY DATE RECOMMENDED BY

IN THE TOWN OF YUCCA VALLEY, COUNTY OF SAN BERNARDINO

# FAIRWAY DRIVE PRECISE GRADING PLAN

## NORTH PARK IMPROVEMENTS

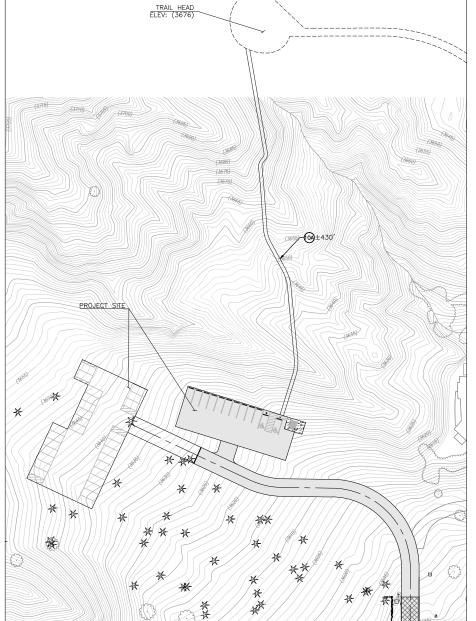

TOWN OF YUCCA VALLEY 57090 TWENTYNINE PALMS HIGHWAY YUCCA VALLEY, CA 92284

#### **BENCHMARK**

BRASS DISK WITH METAL ROD SET INTO GROUND 150' NORTH OF THE CENTERLINE OF HIGHWAY 62, 45' EAST OF THE CENTERLINE OF KICKAPOO TRAIL, 3' NORTHEAST OF UTILITY POLE AND 2' SOUTHWEST OF

ELEVATION: 3329.55 (NAVD 88)

#### BASIS OF BEARINGS

THE BASIS OF BEARINGS FOR THIS MAP IS TAKEN ALONG THE WEST LINE OF TRACT NO. 7064, M.B. 91/86-88 AND THE EAST LINE OF TRACT NO. 4762, M.B. 66/89-92, AS SHOWN

SAID LINE BEARS N 0019'55" E.

QUANTITIES SHOWN IS FOR PERMIT PURPOSES ONLY, IT IS THE CONTRACTOR'S RESPONSIBILITY TO DETERMINE THE QUANTITIES FOR HIS BID AND PAYMENT

QUANTITIES ESTIMATE DOES NOT INCLUDE CLEARING, SHRINKAGE, SUBSIDENCE, ANY OTHER LOSSES, OR ANY GRADING OF EXCAVATION COVERED UNDER A SEPARATE

### CONSTRUCTION NOTES AND QUANTITIES ESTIMATE:

① CONSTRUCT 3" AC PAVEMENT OVER 6" AGGREGATE BASE TON 2 REMOVE EXISTING PAVEMENT 1,045 3 REMOVE EXISTING JOSHUA TREE (CONFIRM WITH TOWN ENGINEER PRIOR TO REMOVAL) PRECISE GRADING CONSTRUCTION NOTES (5) CONSTRUCT 4" WHITE PARKING STRIPE PER DETAIL ON SHEET 2 6 CONSTRUCT 5" CONCRETE CURB STOPS PER DETAIL ON SHEET 2 FΑ CONSTRUCT ADA PARKING STALL AND CONSTRUCT HANDICAP PAVEMENT SYMBOLS/MARKING PER SECTION 1109A OF THE 2019 CBC. PER DETAIL SÉE SHEET 2 O CONSTRUCT HANDICAP SIGNS AND POST EΑ  $\bigodot$  Construct 1/4 ton RIP-RAP energy dissipater per detail on sheet 3 TON 4-FT WIDE ROUGH GRADED TRAIL (FIELD VERIFY LOCATION) UTILITY PLAN CONSTRUCTION NOTES (1) INSTALL 2" WATER SERVICE PIPE (TOWN OF YUCCA VALLEY) (12) INSTALL 2" 22.5\* ELBOW 1" WATER SERVICE AND METER INSTALLATION PER HDWD STD. DWG. C-48 (BY HDWD)

1" SERVICE CONNECTION TO WATER MAIN PER HDWD STD. DWG. C-9 (BY HDWD) EΑ (6) INSTALL 4" SEWER PIPE (AMTROL RP-HP PRESSURISER OR EQUAL)

### 19 INSTALL SEWER CLEAN-OUT PER DETAIL ON SHEET 2 EROSION CONTROL PLAN CONSTRUCTION NOTES

- 30 SILT FENCE PER CASQA SE-1 AND DETAIL HEREON
- 3) STABILIZED CONSTRUCTION ENTRANCE/EXIT WITH RUMBLE RACKS PER CASQA TC-1 AND DETAIL HEREON

(18) INSTALL 2" BACKFLOW PREVENTION DEVICE PER HDWD STD DWG C-15

- (32) GRAVEL BAG BARRIER PER CASQA SE-8 AND DETAIL HEREON
- 33 MATERIAL DELIVERY AND STORAGE PER CASQA WM-01
- $\ensuremath{\mathfrak{F}}$  vehicle and equipment fueling area per casqa (ns-8, ns-9 and ns-10)
- 35) WASTE MANAGEMENT AREA PER CASQA WM-05
- (36) VEHICLE STORAGE
- 37 WIND EROSION CONTROLS PER CASQA WE-1
- 33 STREET SWEEPING AT ALL CONSTRUCTION SITE ENTRANCES/EXITS PER CASQA
- 39 PAVING AND GRINDING OPERATION PER CASQA NS-3
- (WM-9) SANITARY/SEPTIC MANAGEMENT
- (4) STRAW WATTLES TYPE 2 PER CALTRANS STD. H51

SHEET INDEX:	
PLAN TITLE	SHEET NO.
TITLE SHEET	1
GENERAL NOTES AND DETAILS	2
SIDE PLAN/HORIZONTAL CONTROL PLAN	3
ROUGH GRADING PLAN	4
PRECISE GRADING PLAN	5
STREET IMPROVEMENT PLAN	6
RESTROOM/UTILITY PLAN	7
EROSION CONTROL PLAN	8
RESTROOM DETAILS	9
RESTROOM DETAILS	10

#### UTILITY CONTACT INFORMATION

NATURAL CAS

THE CONTRACTOR SHALL BE RESPONSIBLE FOR THE LOCATION AND PROTECTION OF ALL UTILITIES. FOR LOCATION OF UNDERGROUND UTILITIES, OR FOR EMERGENCY ASSISTANCE CALL:

HI-DESERT WATER DISTRICT: WATER 55439 29 PALMS HWY YUCCA VALLEY, CA 92284

TITLE SHEET

THE GAS COMPANY

YUCCA VALLEY, CA 92284

295 NORTH SUNRISE RD. PALM SPRINGS, CA 92262

TIME WARNER CABLE 83-473 AVENUE 45 INDIO, CA 92201

4878 NEWTON ROAD YUCCA VALLEY, CA 92287 (760) 365-2015

FRONTIER COMMUNICATIONS

## TOWN OF YUCCA VALLEY

CABLE

NORTH PARK IMPROVEMENTS TOWN PROJECT NO. 8950-2020, CDBG PROJECT No. TYVA-20-I-03/0173

SHEET

10\_sheet DRAWING NO

### GRADING GENERAL NOTES

- 1) ALL WORK SHALL BE DONE IN ACCORDANCE WITH THE STANDARD PLANS OF THE TOWN OF YUCCA VALLEY AND STANDARD SPECIFICATIONS FOR PUBLIC WORKS CONSTRUCTION (GREENBOOK), LATEST EDITION, AND THE PROJECT'S "CONDITIONS OF APPROVAL", CALTRANS STANDARDS CURRENT EDITION.
- 2) THE CONTRACTOR SHALL BE RESPONSIBLE FOR PROVIDING AN EFFECTIVE MEANS OF DUST CONTROL WHICH SHALL INCLUDE PROVISIONS FOR ADEQUATE WATERING DURING THE GRADING PROCESS AND PROVISIONS FOR CONTINUANCE OF DUST CONTROL UNTIL THE GRADE SURFACE PRESENTS SUFFICIENT COVER AGAINST WIND OR WATER EROSION THAT SPECIAL DUST CONTROL MEASURES ARE NO LONGER NECESSARY.
- 3) CONTRACTOR SHALL OBTAIN PERMITS, AS REQUIRED BY THE TOWN OF YUCCA VALLEY DEVELOPMENT CODE.
- 4) ALL GRADING SHALL COMPLY WITH APPENDIX CHAPTER 33 OF THE CALIFORNIA BUILDING CODE, LATEST EDITION AS AMENDED BY THE TOWN OF YUCCA VALLEY.
- 5) THE LOCATION OF EXISTING, UNDERGROUND UTILITIES ARE SHOWN IN AN APPROXIMATE WAY ONLY. SUBJECT TO THE PROVISIONS OF SECTION 4215 OF THE CALIFORNIA GOVERNMENT CODE, THE CONTRACTOR SHALL DETERMINE THE EXACT LOCATION OF ALL EXISTING UTILITIES BEFORE COMMENCING WORK. CONTACT DIG ALERT AT 811 TWO WORKING DAYS PRIOR TO ANY FXCAVATION
- 6) DIMENSIONING TO CURBS SHALL BE TO FACE OF CURB.
- 7) CONTRACTOR SHALL DISPOSE OF ALL DEBRIS OFF-SITE AT A LEGALLY APPROVED DISPOSAL SITE.
- 8) CONTRACTOR SHALL REMOVE ANY ABANDONED UTILITY FACILITIES AND SHOW LIMITS OF REMOVALS ON THE RECORD DRAWINGS.
- 9) THE CONTRACTOR SHALL BE RESPONSIBLE FOR THE REMOVAL, REPLACEMENT OR RELOCATION OF ALL REGULATORY, WARNING AND GUIDE SIGNS.
- 10) THE ASPHALT DESIGN MUST MEET THE CALTRANS STANDARD SPECIFICATIONS FOR TYPE B ASPHALT, % MAXIMUM MEDIUM AND % MAXIMUM MEDIUM. THE OIL SHALL BE PG 70-10.
- 11) THE AGGREGATE BASE SHALL BE CLASS II, FOR 1/4" MAXIMUM ACCORDING TO THE STATE OF CALIFORNIA STANDARD SPECIFICATIONS.
- 12) A "RECORD DRAWING" (FORMERLY CALLED "AS-BUILT" DRAWING) OF THIS PLAN MUST BE SUBMITTED TO AND APPROVED BY THE TOWN ENGINEER BY THE PROJECT ENGINEER OF RECORD PRIOR TO ACCEPTANCE OF THE PROJECT.
- 13) CONSTRUCTION SIGNING, LIGHTING AND BARRICADING SHALL BE PROVIDED ON ALL PROJECTS AS REQUIRED BY TOWN STANDARDS OR AS DIRECTED BY THE TOWN ENGINEER. AS A MINIMUM, ALL CONSTRUCTION SIGNING, LIGHTING AND BARRICADING SHALL BE IN ACCORDANCE WITH STATE OF CALIFORNIA, DEPARTMENT OF TRANSPORTATION, "MANUAL OF TRAFFIC CONTROLS FOR CONSTRUCTION AND MAINTENANCE WORK ZONES" DATED 1991, OR SUBSEQUENT EDITIONS IN FORCE AT THE TIME OF CONSTRUCTION.
- 14) THE FLOWLINES OF ALL CURB AND GUTTERS AND CROSS GUTTERS SHALL BE WATER TESTED BEFORE ACCEPTANCE OF THE PROJECT.
- 15) PARKING STALLS SHALL BE CLEARLY DELINEATED WITH A 4 TO 6 INCH STRIPE "HAIRPIN" OR ELONGATED "U" DESIGN OR OTHER APPROVED STRIPING OR STALL DELINEATION.TING ON THE SITE IS REQUIRED BEFORE START OF GRADNING WITH THE FOLLOW
- 16) FINAL SITE GRADING AND DRAINAGE FLOW LINES SHALL BE CERTIFIED, IN WRITING, BY THE ENGINEER OF RECORD TO BE IN CONFORMANCE TO THE APPROVED GRADING PLAN PRIOR TO FINAL INSPECTION.
- 17) NPDES PERMIT IS REQUIRED PRIOR TO ISSUANCE OF A GRADING PERMIT FOR PARCELS 1
- 18) THE LOCATION OF BLOCK WALLS, RETAINING WALLS, AND OTHER STRUCTURES SHALL BE CLEARLY DEFINED ON THE PLANS. CONSTRUCTION AND STRUCTURAL DETAILS SHALL NOT BE SHOWN ON THE GRADING PLAN
- 19) ALL PROVISIONS OF THE PRELIMINARY SOILS REPORT PREPARED BY CONVERSE CONSULTANTS DATED AUGUST 18, 2021 SHALL BE COMPLIED WITH.
- 20) THIS PLAN IS FOR GRADING PURPOSES ONLY. APPROVAL DOES NOT CONSTITUTE APPROVAL OF BUILDING LOCATIONS, OFF-SITE DRAINAGE FACILITIES, DRIVEWAY LOCATIONS OR SIZES, PARKING LOT LAYOUT, ETC., OR OTHER ITEMS NOT RELATED TO BASIC GRADING OPERATIONS. NO STRUCTURAL CALCULATIONS HAVE BEEN MADE FOR ANY STRUCTURES ON THIS PLAN DURING PLAN CHECK; THEREFORE, THE PLAN CHECK ENGINEER TAKES NO RESPONSIBILITY FOR THE INTEGRITY OF SUCH STRUCTURES.
- 21) PLANS MAY BE SUBJECT TO COMPLIANCE REVIEW WITH CURRENT REQUIREMENTS IF CONSTRUCTION HAS NOT STARTED WITHIN 12 MONTHS OF PLAN APPROVAL BY THE TOWN ENGINEER.
- 22) GRADING PLAN MUST INCLUDING THE FOLLOWING GENERAL NOTE: "UPON ISSUANCE OF A GRADING PERMIT BY THE TOWN OF YUCCA VALLEY ALL GRADING SHALL BE UNDERTAKEN AND COMPLETED IN COMPLIANCE WITH TOWN OF YUCCA VALLEY ORDINANCE NO. 133, IN PARTICULAR, SECTION 4(B) BUILDING CODE AMENDMENTS: 4, APPENDIX, VOLUME 1, CHAPTER 33, EXCAVATION AND GRADING, A. SECTION 3309.3 GRADING DESIGNATION, B. SECTION 316, EROSION CONTROL AND 5. SECTION 3320 ENGINEERING REPORTS, AND THE ENGINEER OF RECIRD SHAAL CERTIFY THAT ALL GRADING COMPLIES WITH SAID ORDINANCE PRIOR TO ACCPETANCE OR ISSUANCE OF ANY PERMITS BY THE TOWN OF YUCCA VALLEY!






BENCH MARK NO.

BRASS DISK WITH METAL ROD SET INTO
GROUND 150' NORTH OF THE CENTERLINE
OF HIGHWAY 62, 45' EAST OF THE
CENTERLINE OF KICKAPOO TRAIL, 3'
NORTHEAST OF UTILITY POLE AND 2'
SOUTHWEST OF WITNESS POST.


ELEVATION: 3329.55 (NAVD 88)

AARK DATE INITIAL DESCRIPTION DATE APP'VI

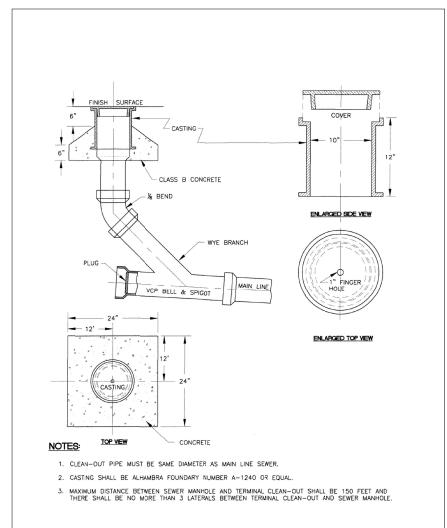


### SEWER TERMINAL CLEAN-OUT

NTS

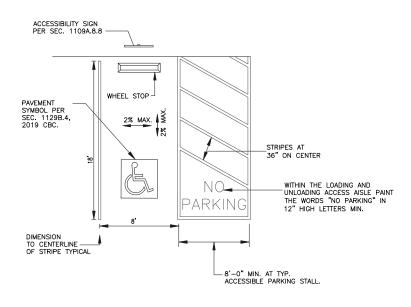


PER CBC 2019, CHAPTER IIB-502.3.3 AND SPPWC STD. 180-0

## ADA PARKING STALL DETAIL NTS

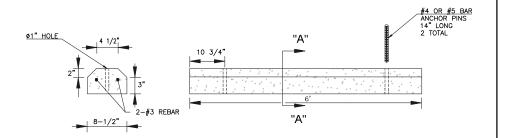

## CONCRETE CURB STOP DETAIL NTS

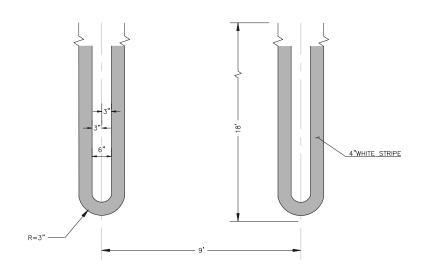

PARKING STALL STRIPING






APPROVED BY:	
ARMANDO BALDIZZONE, DIRECTOR OF PUBLIC WORKS R.C.E. 70102	DATE
RECOMMENDED BY:	
NOEL OWSLEY, TOWN ENGINEER R.C.E. 39827	DATE


### TOWN OF YUCCA VALLEY

NORTH PARK IMPROVEMENTS TOWN PROJECT NO. 8950-2020, CDBG PROJECT No. TYVA-20-I-03/0173 GENERAL NOTES AND DETAILS

SHEET <u>2</u>

OF 10 SHEET DRAWING NO.

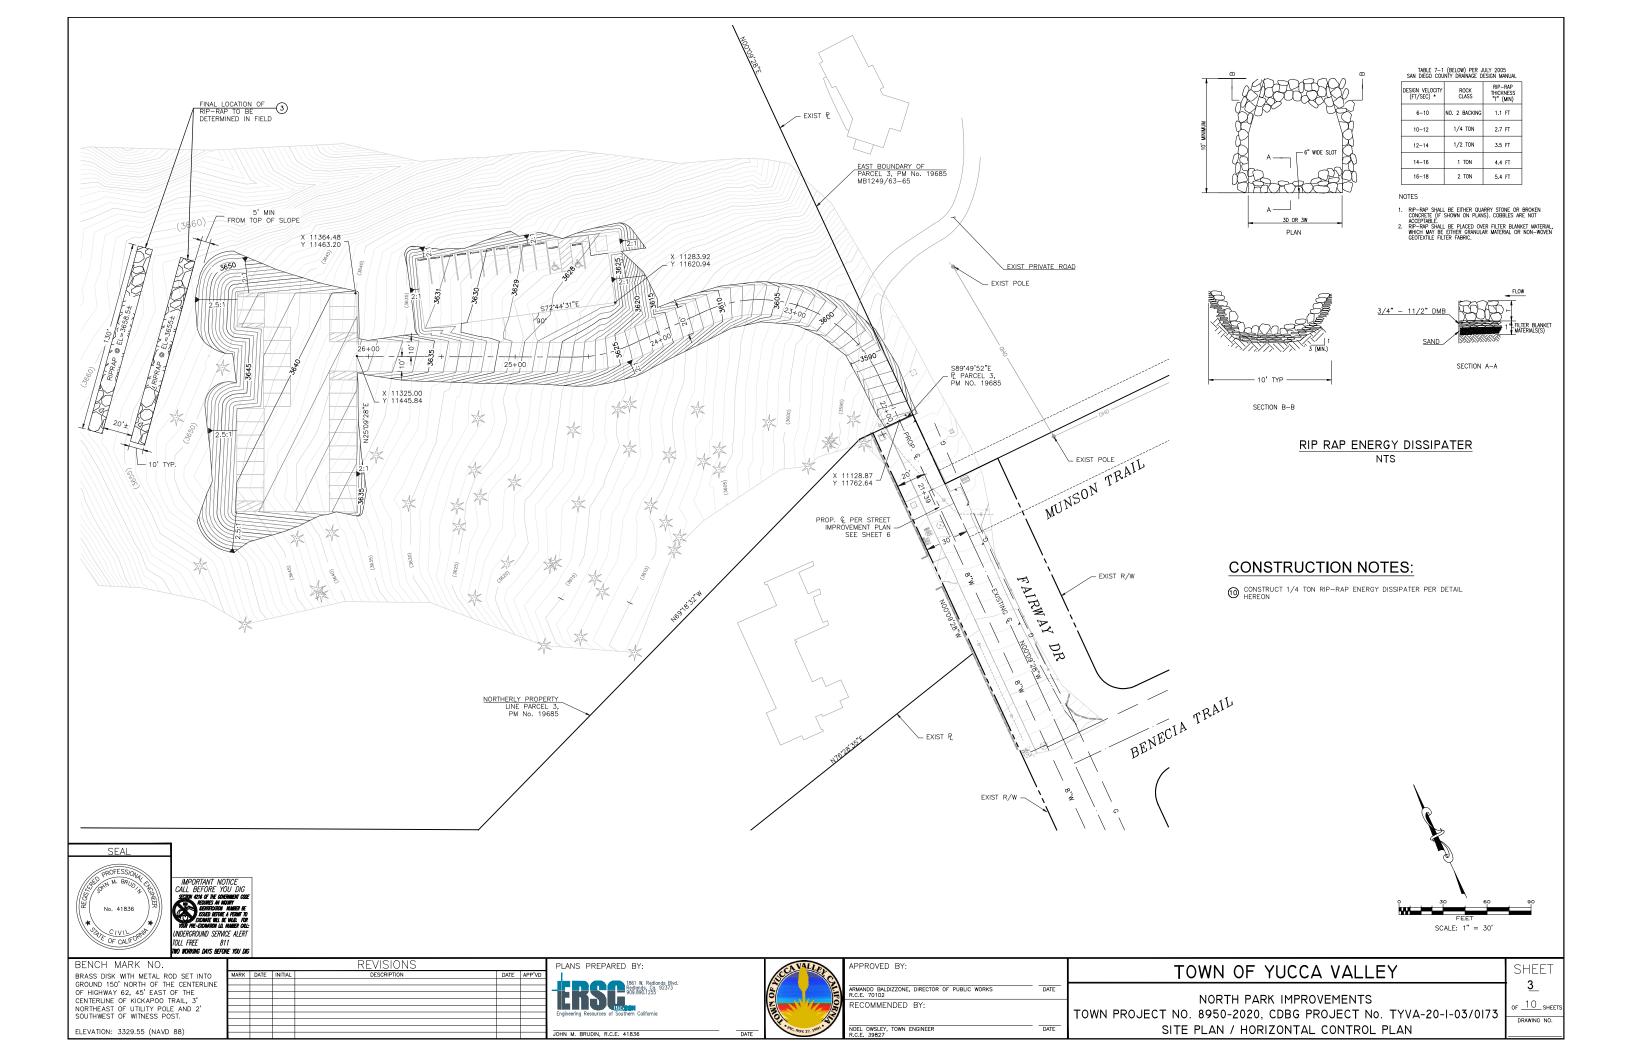

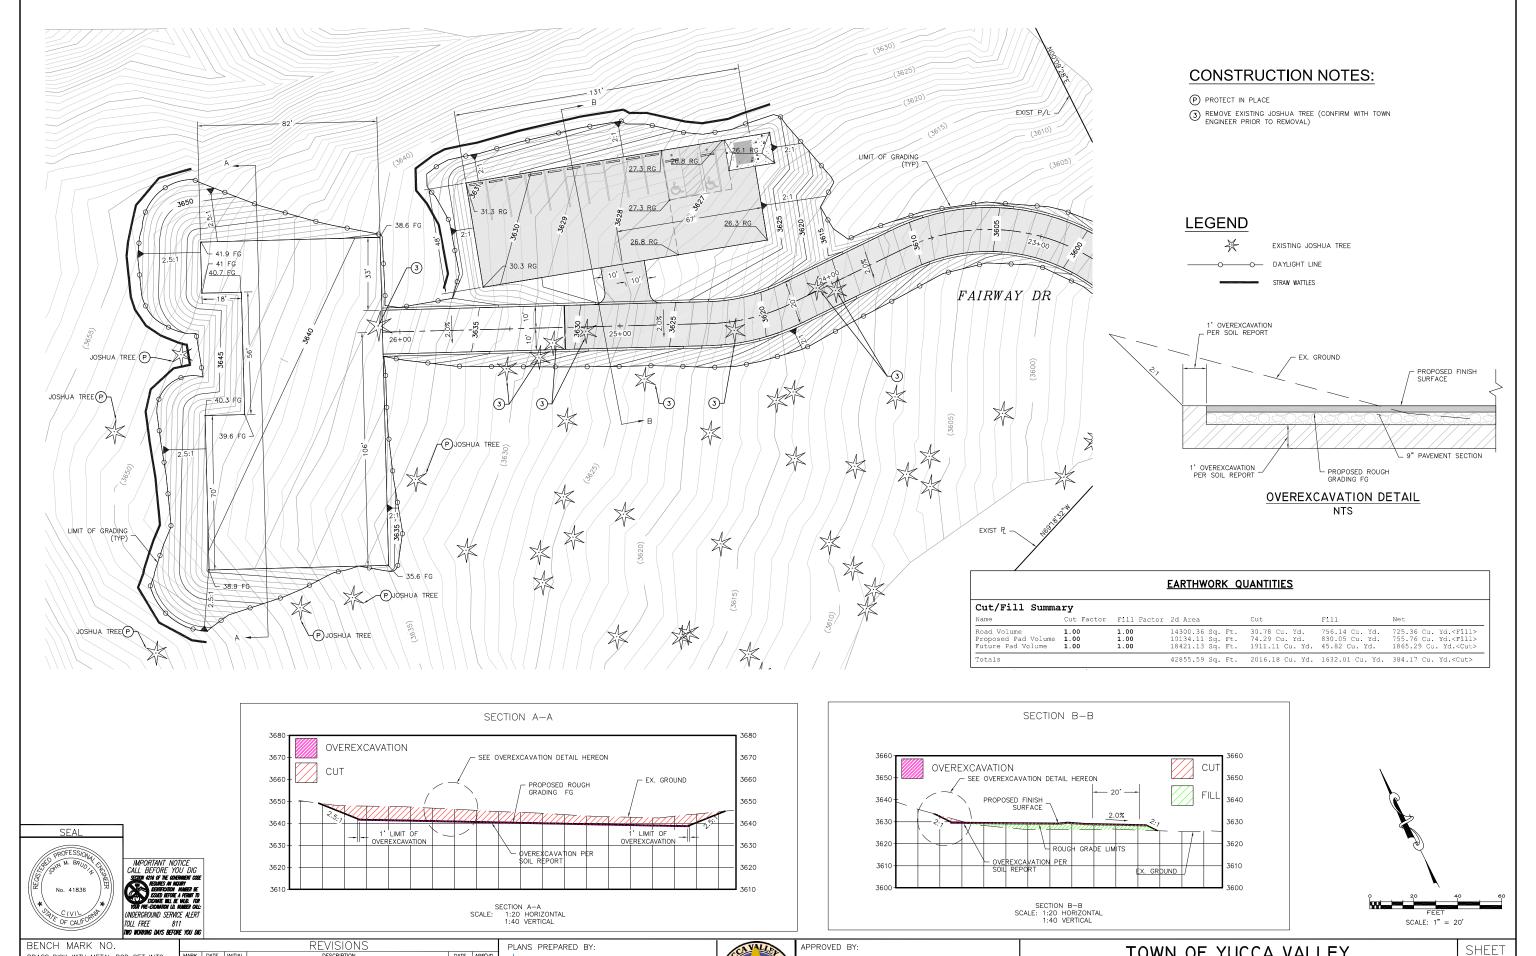

BENCH MARK NO. BRASS DISK WITH METAL ROD SET INTO GROUND 150' NORTH OF THE CENTERLINE OF HIGHWAY 62, 45' EAST OF THE CENTERLINE OF KICKAPOO TRAIL, 3' NORTHEAST OF UTILITY POLE AND 2' SOUTHWEST OF WITNESS POST.

ELEVATION: 3329.55 (NAVD 88)

REVISIONS PLANS PREPARED BY: 1861 W. Rediands Blv Rediands Co. 92373 909.890.1255




ATTROVED BY.		
ARMANDO BALDIZZONE, DIRECTOR OF PUBLIC WORKS R.C.E. 70102	DATE	
RECOMMENDED BY:		Т
NOEL OWSLEY, TOWN ENGINEER R.C.E. 39827	DATE	

TOWN OF YUCCA VALLEY

NORTH PARK IMPROVEMENTS TOWN PROJECT NO. 8950-2020, CDBG PROJECT No. TYVA-20-I-03/0173 ROUGH GRADING PLAN


<u>4</u> of 10 sheets DRAWING NO.

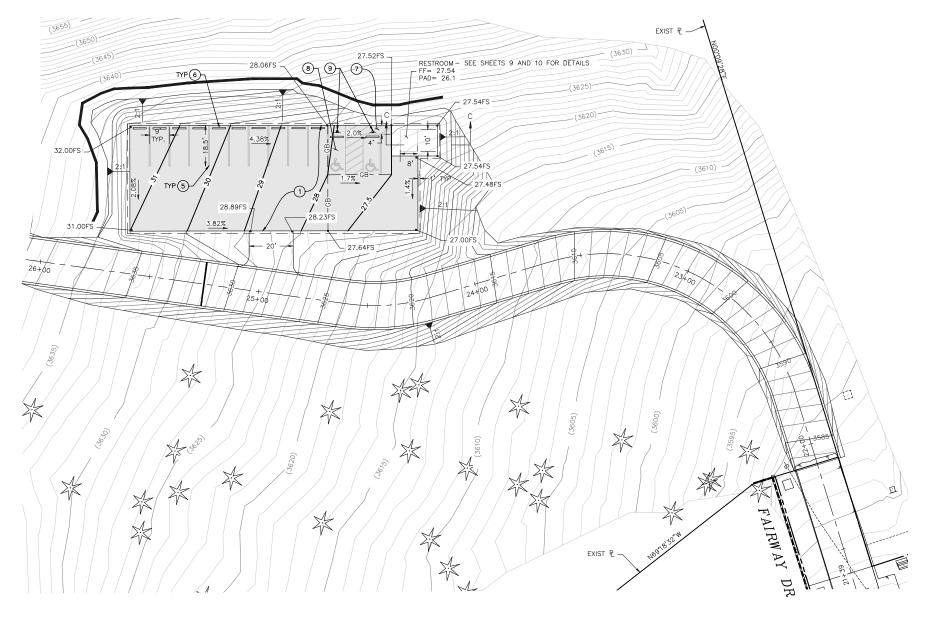


### **CONSTRUCTION NOTES:**


- 1 CONSTRUCT 3" AC PAVEMENT OVER 6" AGGREGATE BASE
- (5) CONSTRUCT 4" WHITE PARKING STRIPE PER DETAIL ON SHEET 2
- 6 CONSTRUCT 5" CONCRETE CURB STOPS PER DETAIL ON SHEET 2
- 7 CONSTRUCT BLUE PATH OF TRAVEL STRIPING
- (3) CONSTRUCT ADA PARKING STALL AND HANDICAP PAVEMENT SYMBOLS/MARKING PER SECTION 1109A OF THE 2019 CBC. PER DETAIL SEE SHEET 2
- 9 CONSTRUCT HANDICAP SIGNS AND POST

### LEGEND

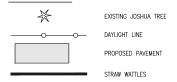


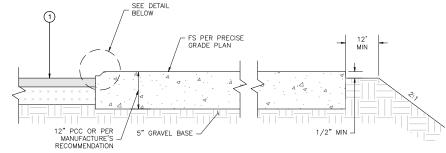

SECTION C-C NTS

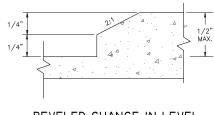

BEVELED CHANGE IN LEVEL

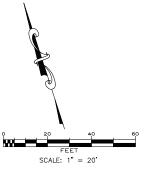



IMPORTANT NOTICE
CALL BEFORE YOU DIG
STIMM 410 FOR EMEMBERS OF
REMIES IN ROUNT
REMIES IN ROUNT
REMIES IN ROUNT
STATE OF THE STATE OF THE STATE
SIZE BETTLE A FEBRIT TO
TOOL FREE-DOMINION LO MINERO CULUNDERGROUNDS SERVICE ALERT
TOLL FREE
811

I	BENCH MARK NO.	REVISIONS			
ı	BRASS DISK WITH METAL ROD SET INTO	MARK	DATE	INITIAL	DESCRIPTION
ı	GROUND 150' NORTH OF THE CENTERLINE	<b>—</b>			
ı	OF HIGHWAY 62, 45' EAST OF THE				
ı	CENTERLINE OF KICKAPOO TRAIL, 3'				
ı	NORTHEAST OF UTILITY POLE AND 2'				
I	SOUTHWEST OF WITNESS POST.	<b>-</b>			
I	ELEVATION: 3329.55 (NAVD 88)				
ı	ELEVATION: 3329.33 (NAVD 66)				

PLANS PREPARED BY:	
1851 W. Redonds Blud. Redonds Blud. Redonds Co. 92373 99.9801123 Engineering Resources of Southern California	

CAVALLEY	APPROVED BY
	ARMANDO BALDIZZON R.C.E. 70102
	RECOMMENDE
O	NOEL OWSLEY, TOWN
MOV. 27. 10	R.C.E. 39827

	APPROVED BY:		
١	ARMANDO BALDIZZONE, DIRECTOR OF PUBLIC WORKS R.C.E. 70102	DATE	
	RECOMMENDED BY:		T
	NOEL OWSLEY, TOWN ENGINEER R.C.E. 39827	DATE	

### TOWN OF YUCCA VALLEY


SHEET


<u>5</u>


OF 10 SHEETS


DRAWING NO.


NORTH PARK IMPROVEMENTS
FOWN PROJECT NO. 8950-2020, CDBG PROJECT No. TYVA-20-I-03/0I73
PRECISE GRADING PLAN

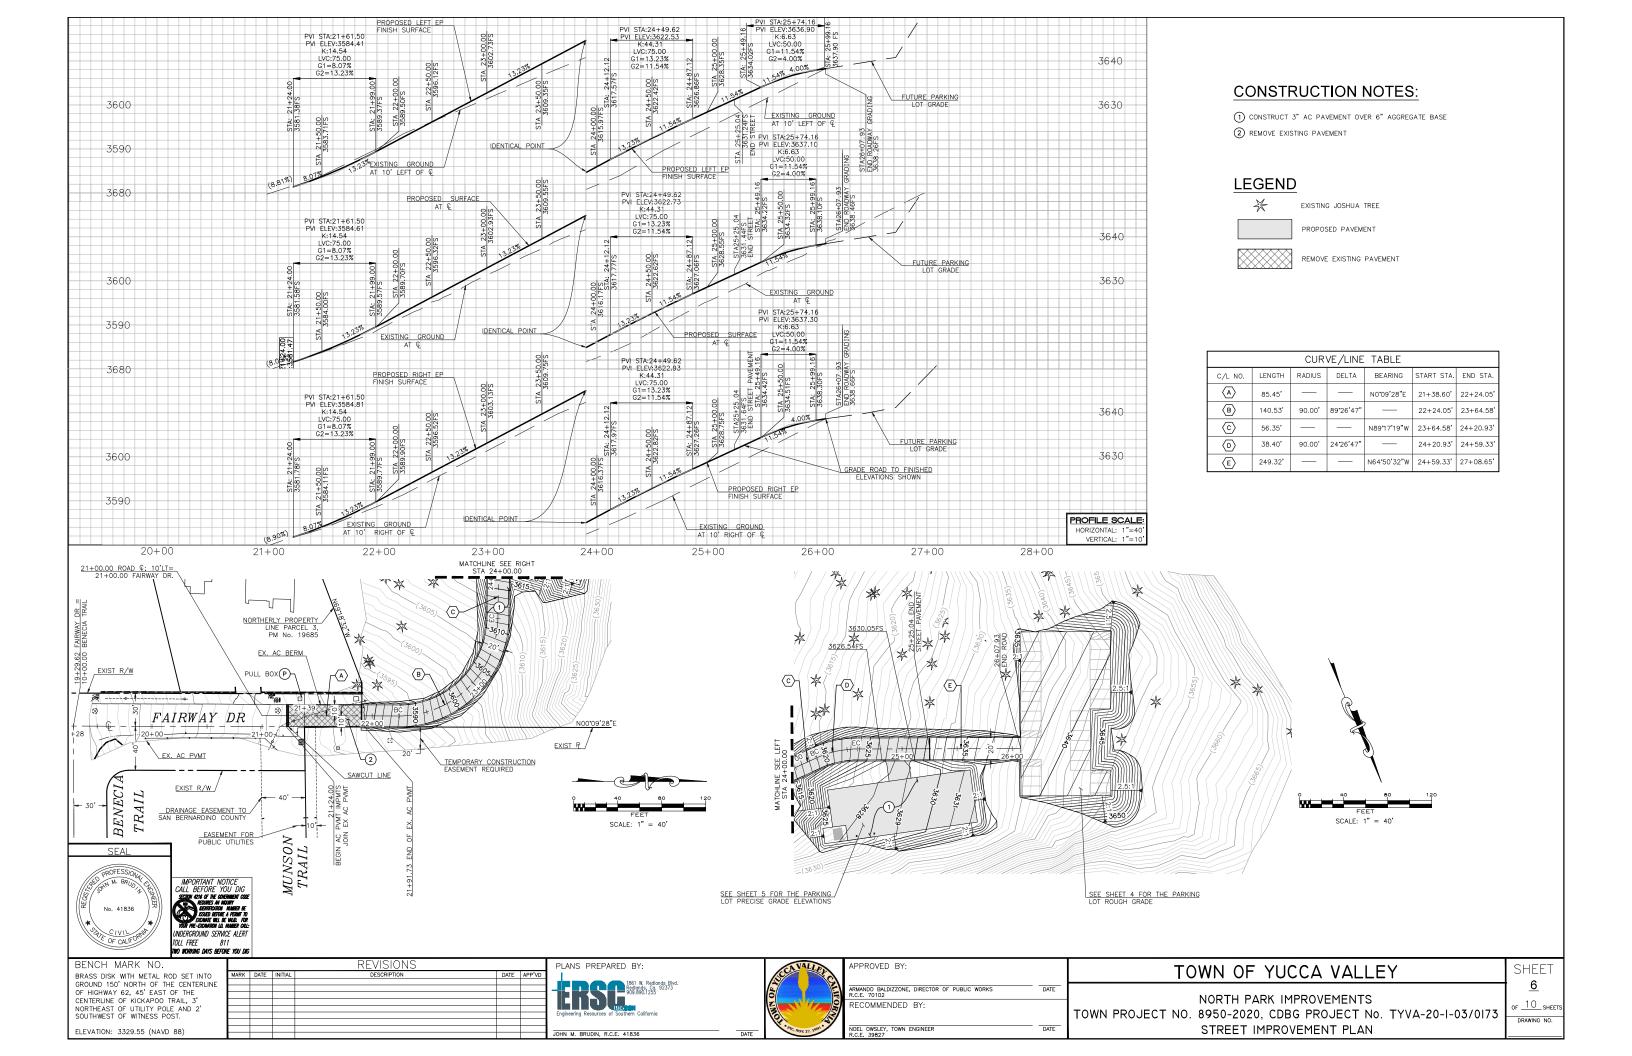


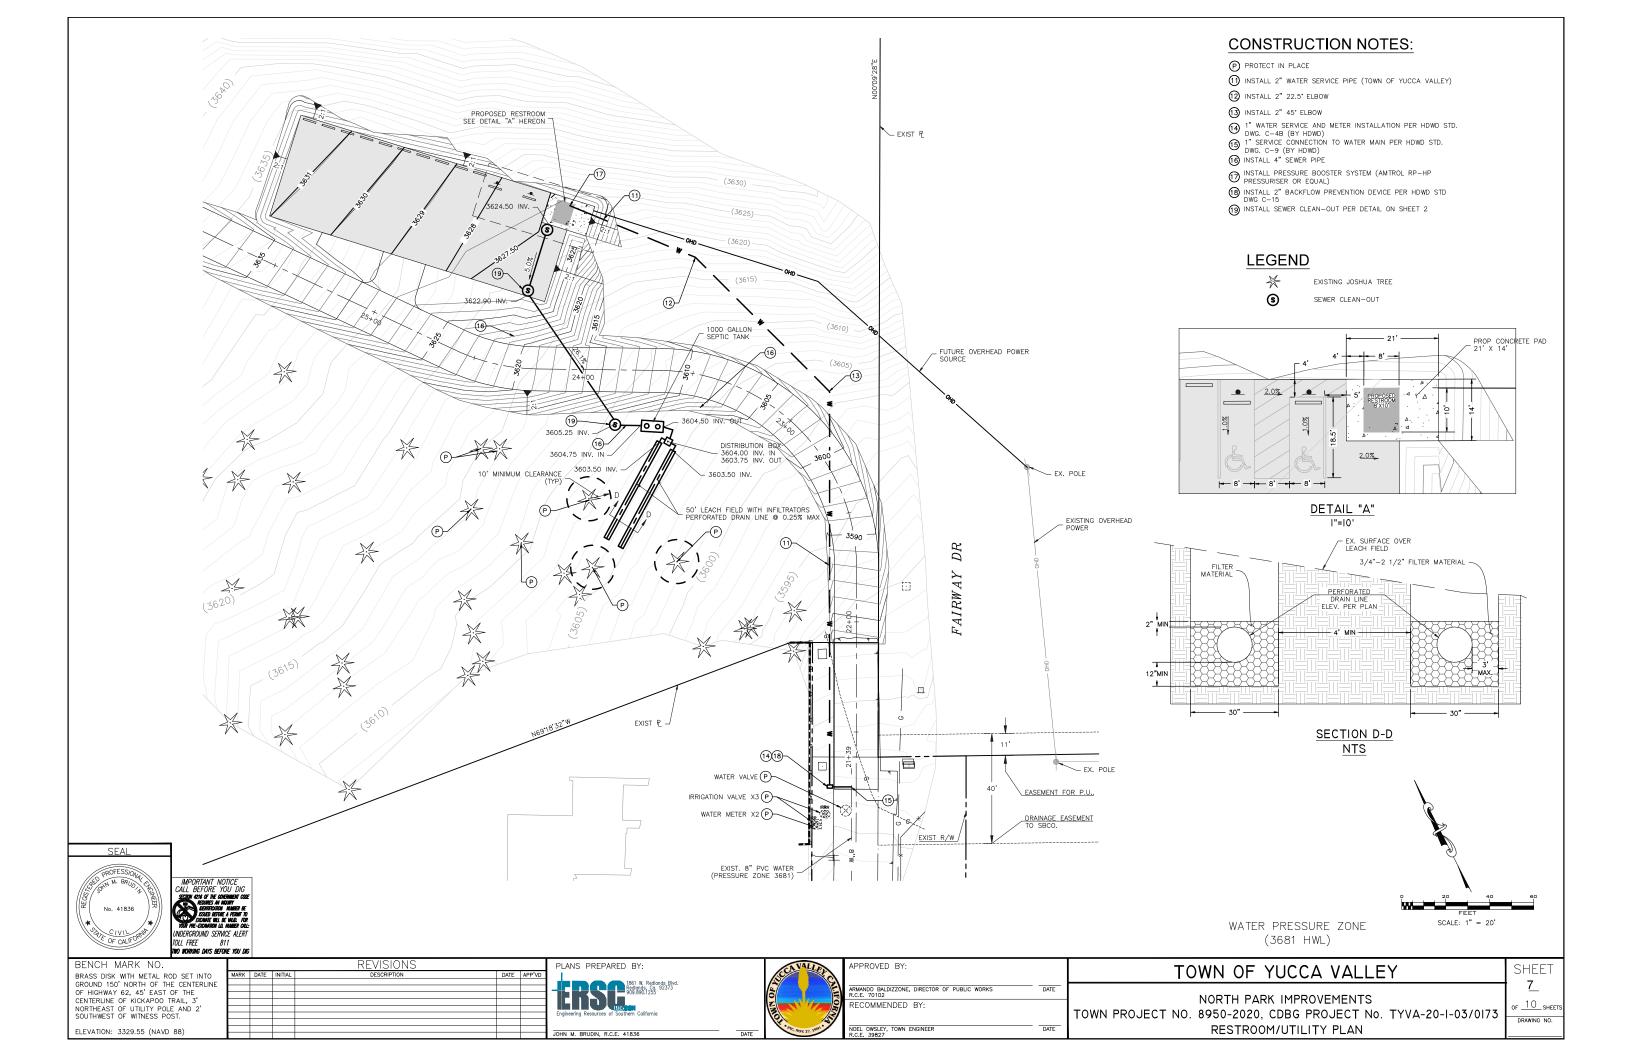

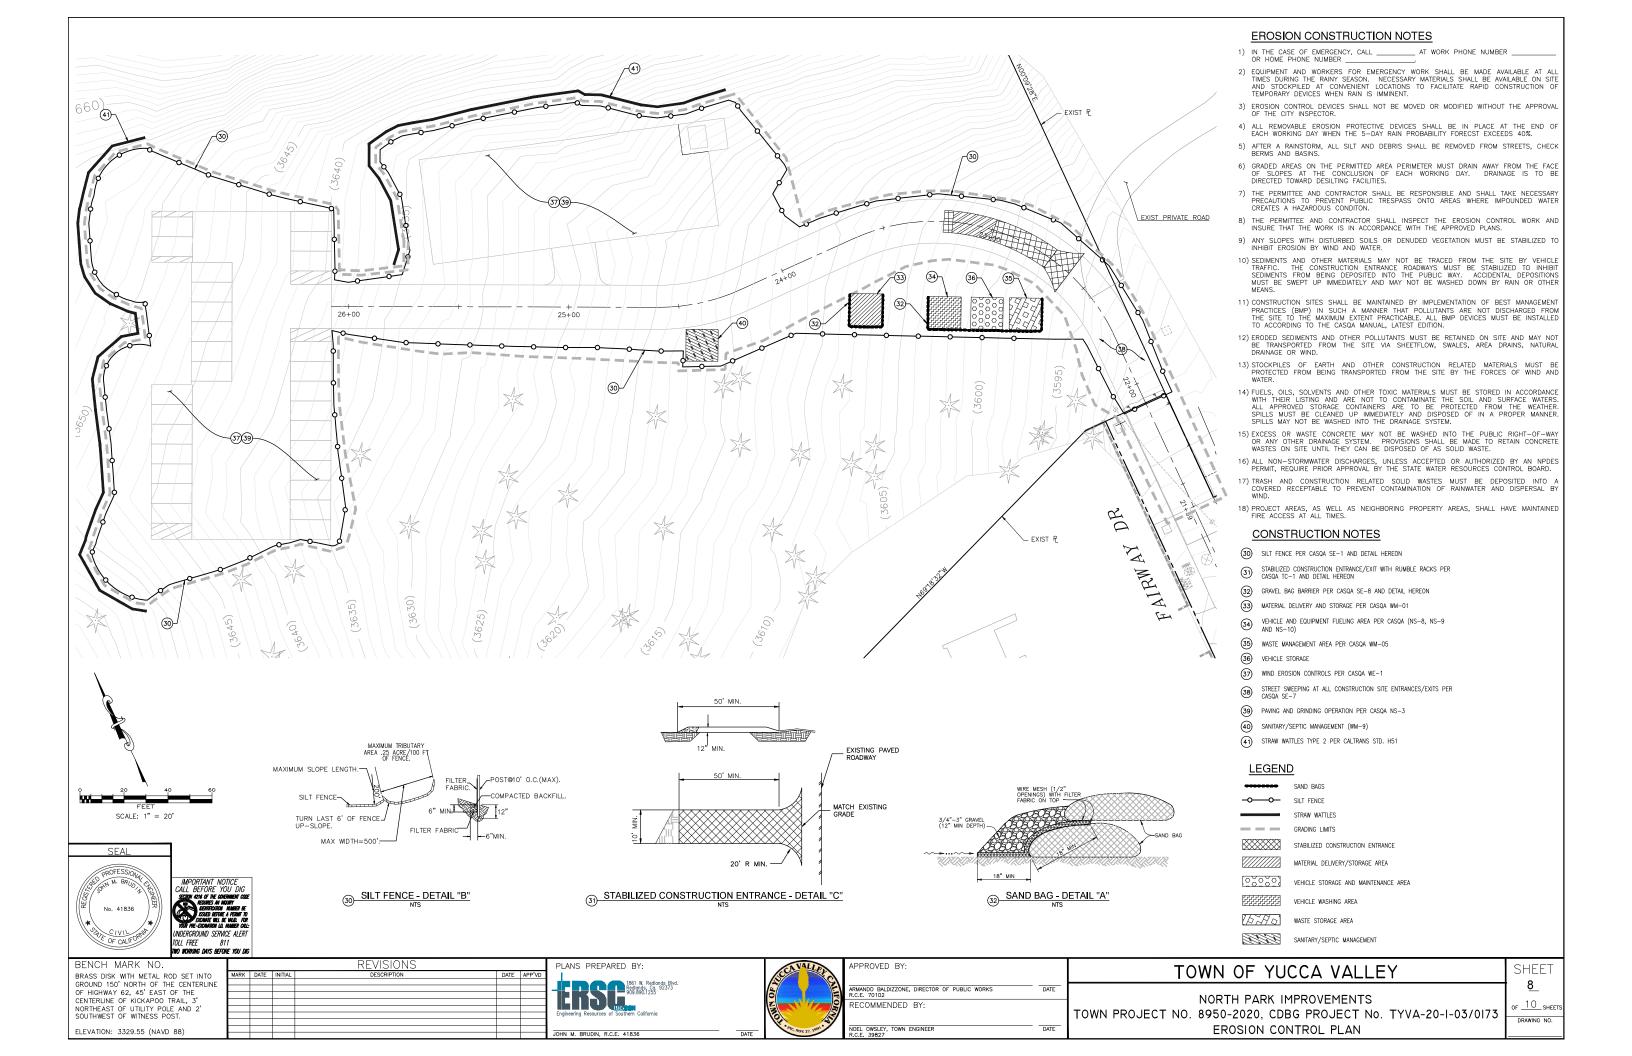

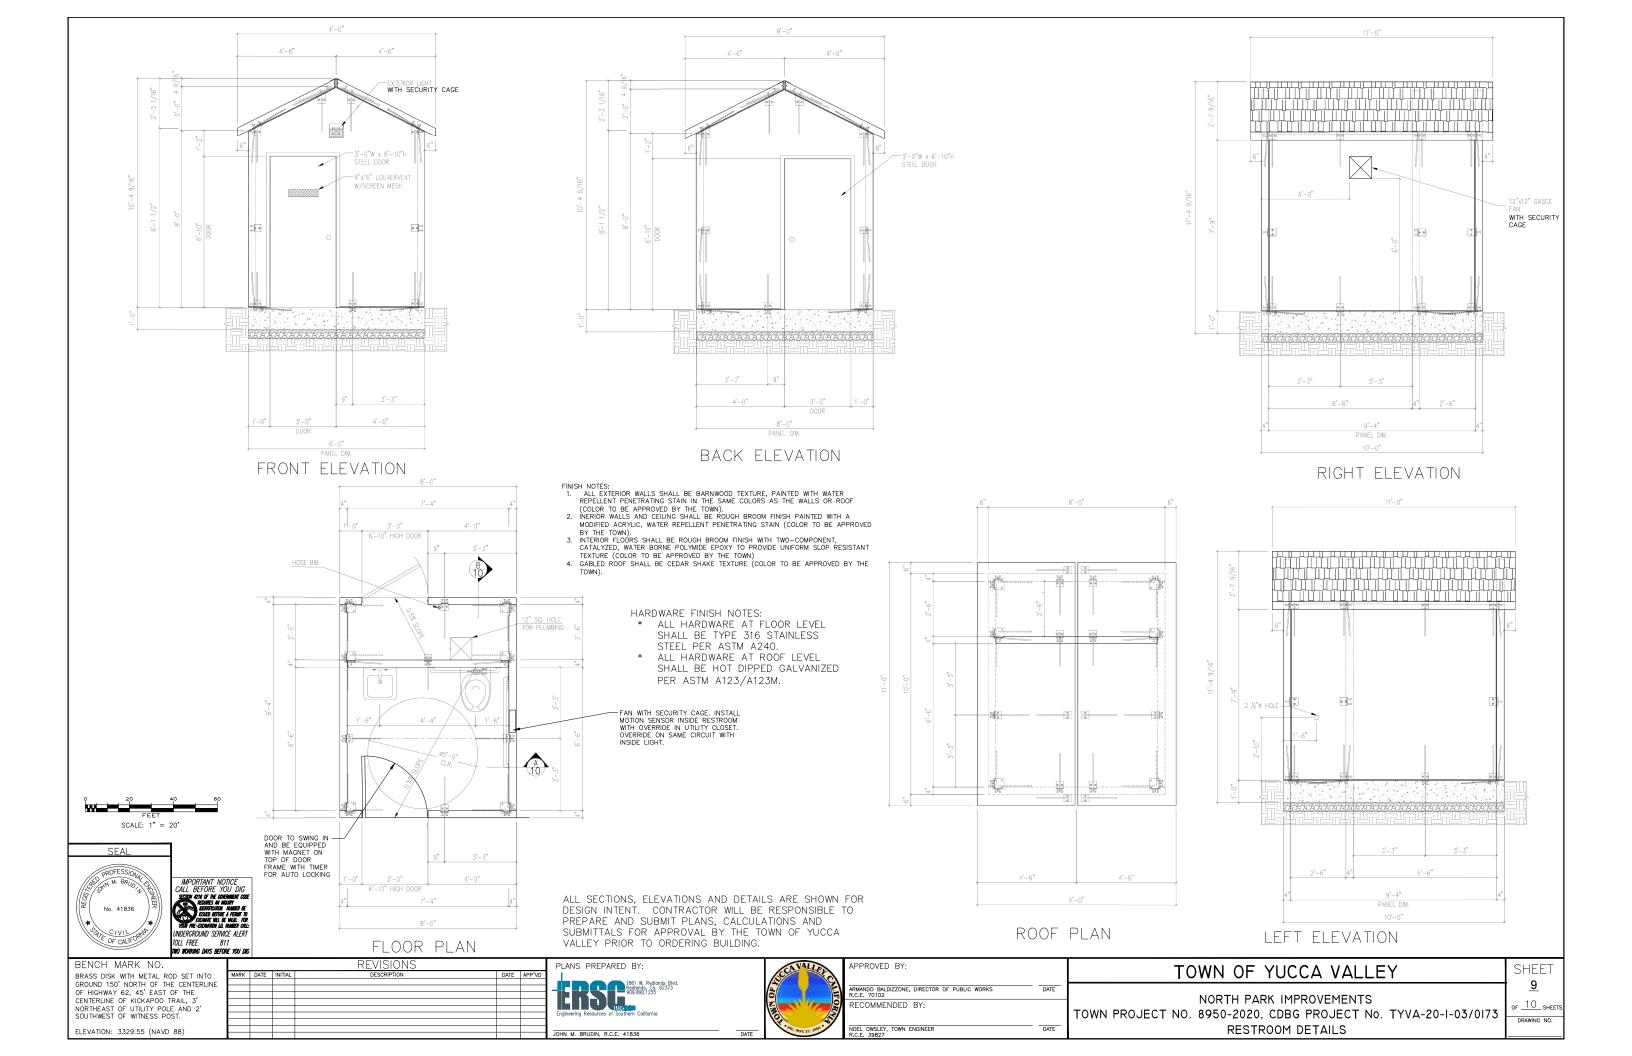

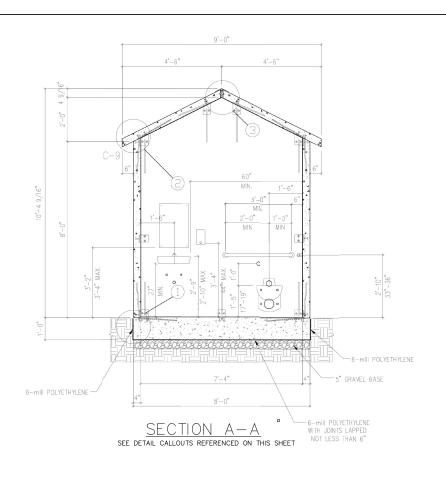

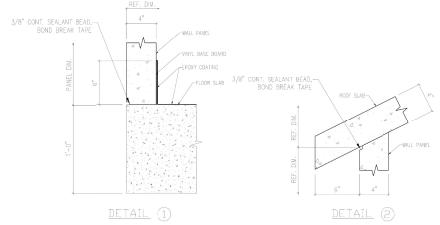

- FINISH NOTES:

  1. ALL EXTERIOR WALLS SHALL BE BARNWOOD TEXTURE, PAINTED WITH WATER REPELLENT PENETRATING STAIN IN THE SAME COLORS AS THE WALLS OR ROOF (COLOR TO BE APPROVED BY THE TOWN).


  2. INERIOR WALLS AND CELLING SHALL BE ROUGH BROOM FINISH PAINTED WITH A MODIFIED ACRYLIC, WATER REPELLENT PENETRATING STAIN (COLOR TO BE APPROVED BY THE TOWN).

  3. INTERIOR FLOORS SHALL BE ROUGH BROOM FINISH WITH TWO—COMPONENT, CATALYZED, WATER BORNE POLYMIDE EPOXY TO PROVIDE UNIFORM SLOP RESISTANT TEXTURE (COLOR TO BE APPROVED BY THE TOWN).


  4. GABLED ROOF SHALL BE CEDAR SHAKE TEXTLIRE (COLOR TO BE APPROVED BY THE
- 4. GABLED ROOF SHALL BE CEDAR SHAKE TEXTURE (COLOR TO BE APPROVED BY THE

- HARDWARE FINISH NOTES:

  \* ALL HARDWARE AT FLOOR LEVEL
  SHALL BE TYPE 316 STAINLESS STEEL PER ASTM A240.
- ALL HARDWARE AT ROOF LEVEL SHALL BE HOT DIPPED GALVANIZED PER ASTM A123/A123M.

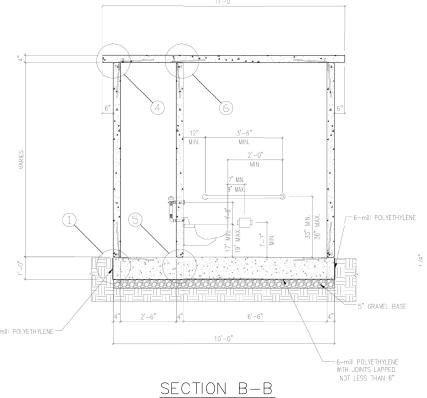


SEE DETAIL CALLOUTS REFERENCED ON THIS SHEET

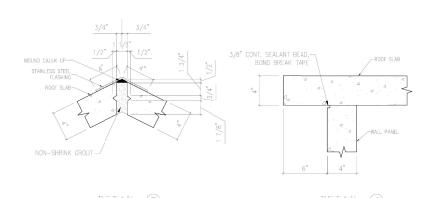

	RESTROOM FIXTURE TABLE					
ITEM	DESCRIPTION	MODEL	COMMENTS	QUANTITY		
1	SINK	KOHLER MODEL K-2812, OR EQUAL		1		
2	FAUCET	MOEN MODEL 8884, OR EQUAL	TIMED DISPENSING	1		
3	PRESSURE BOOSTER SYTEM	AMTROL RP-HP PRESSURISER		1		
4	TOILET	ACORN SIPHON JET TOILET-OFF FLOOR MODEL R2105-T-1, OR EQUAL		1		
5	FLUSHMETER	SLOAN MODEL 952-1.6, OR EQUAL		1		
6		PRIER P-164D14 QUARTER-TURN FROST FREE ANTI-SIPHON OUTDOOR HYDRANT, 14-INCH, OR EQUAL	HEIGHT ABOVE FLOOR TO BE DETERMINED BY TOWN	1		
7	SOAP DISPENSER	ATLAS AMERICAN AUTO SOAP DISPENSER MODEL AA-SDS-AF, OR EQUAL		1		
8	HAND DRYER	FASTAIRE HAND DRYER, MODEL HDO3. OR EQUAL	BLOWER MOTOR IN UTILITY CLOSET	1		
9	TOILET PAPER HOLDER	18/8 SS TWN JUMBO ROLL TOILET TISSUE DISPENSER, MODEL 407SLTD302, OR EQUAL	STAINLESS STEEL, HOLDS 2-3 ROLLS	1		
10	ELECTRICAL OUTLETS	20A, 125 V OUTLET W/ GFCI	LOCATIONS TO BE DETERMINED BY TOWN	4		
11	MAGNETIC LOCKING SYSTEM	OMRON RFID MAGNETIC LOCK, D40ML SERIES, OR EQUAL	LOCATION COORDINATED WITH TOWN	1		
			•			

3/8" CONT. SEALANT BEAD.-BOND BREAK TAPE -VINYL BASE BOARD

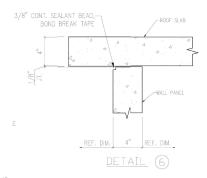

COLD WATER BELOW GRADE COLD WATER STUB OUT ABOVE GRADE SUPPLY LINE TO BE-INSULATED WITH HEAT TAPE

FAN WITH SECURITY CAGE.
INSTALL MOTION SENSOR
INSIDE RESTROOM WITH
OVERRIDE IN UTILITY CLOSET.
OVERRIDE ON SAME CIRCUIT
WITH INSIDE LIGHT. 9 DOOR TO SWING IN AND BE EQUIPPED WITH MAGNETIC AT TOP OF FRAME WITH TIMER FOR AUTO DOOR LOCKING INSIDE LIGHT ON SAME MOTION SENSOR AS FAN.

WASTE PIPE BELOW GRADE

ALL SECTIONS, ELEVATIONS AND DETAILS ARE SHOWN FOR DESIGN INTENT. CONTRACTOR WILL BE RESPONSIBLE TO PREPARE AND SUBMIT PLANS, CALCULATIONS AND SUBMITTALS FOR APPROVAL BY THE TOWN OF YUCCA VALLEY PRIOR TO ORDERING BUILDING.

BRASS DISK WITH METAL ROD SET INTO GROUND 150' NORTH OF THE CENTERLINE OF HIGHWAY 62, 45' EAST OF THE CENTERLINE OF KICKAPOO TRAIL, 3' NORTHEAST OF UTILITY POLE AND 2' SOUTHWEST OF WITNESS POST.

ELEVATION: 3329.55 (NAVD 88)

UNDERGROUND SERVICE ALERI

SCALE: 1" = 20'

PROFESS/ON





	APPROVED BY:		
١	ARMANDO BALDIZZONE, DIRECTOR OF PUBLIC WORKS R.C.E. 70102	DATE	Г
	RECOMMENDED BY:		
	NOEL OWSLEY, TOWN ENGINEER R.C.E. 39827	DATE	

### TOWN OF YUCCA VALLEY

NORTH PARK IMPROVEMENTS TOWN PROJECT NO. 8950-2020, CDBG PROJECT No. TYVA-20-I-03/0I73 RESTROOM DETAILS

FLOOR PLAN

SHEET <u>10</u> \_10\_sheet DRAWING NO.